

# HOUSE ON A HILL - PNL2021-00187-0360312800-CDR PLANS

APN: 036-031-280  
 10th Street  
 Montara, California 94037

| REVISION: | NO. | DESCRIPTION               | DATE       |
|-----------|-----|---------------------------|------------|
|           | 1   | DESIGN REVIEW APPLICATION | 5/11/2021  |
|           | 2   | PLN2021-00187 CYCLE 2     | 8/5/2021   |
|           | 3   | PLN2021-00187 CYCLE 3     | 12/21/2021 |
|           | 4   | COASTSIDE DESIGN REVIEW   | 02/16/2022 |



| SHEET LIST-PLANNING |      |
|---------------------|------|
| #                   | NAME |

| GENERAL INFORMATION |                         |
|---------------------|-------------------------|
| A000                | COVER SHEET             |
| A002                | LIFE & FIRE SAFETY PLAN |
| A003                | LOT COVERAGE DIAGRAM    |

| CIVIL  |                                    |
|--------|------------------------------------|
| C001   | COVER SHEET                        |
| C002   | GRADING & DRAINAGE PLAN            |
| C003   | UTILITY PLAN                       |
| C004   | CROSS SECTIONS                     |
| C005   | CONSTRUCTION DETAILS               |
| C006   | CONSTRUCTION DETAILS               |
| C007   | CONSTRUCTION DETAILS               |
| C008   | EROSION & SEDIMENT CONTROL PLANS   |
| C009   | EROSION & SEDIMENT CONTROL DETAILS |
| SURVEY |                                    |
| SU-1   | SITE - SURVEY                      |

| LANDSCAPE |  |
|-----------|--|
| L001      | LANDSCAPE DESIGN PLAN & SITE LIGHTING PLAN |
| L002      | LANDSCAPE PLANTING PLAN                    |

| IRRIGATION |                             |
|------------|-----------------------------|
| IR-11      | IRRIGATION PLAN             |
| IR-12      | IRRIGATION NOTES AND LEGEND |
| IR-13      | IRRIGATION DETAILS          |
| IR-14      | IRRIGATION DETAILS          |
| IR-15      | IRRIGATION DETAILS          |

| ARCHITECTURAL |                               |
|---------------|-------------------------------|
| A011          | DEMOLITION SITE PLAN          |
| A112          | ARCHITECTURAL SITE PLAN       |
| A113          | ARCHITECTURAL SITE SECTIONS   |
| A211          | GROUND FLOOR PLAN             |
| A212          | SECOND FLOOR PLAN & ROOF PLAN |
| A311          | ELEVATIONS                    |
| A312          | ELEVATIONS                    |

| SHEET LIST-PLANNING |      |
|---------------------|------|
| #                   | NAME |

|      |            |
|------|------------|
| A313 | ELEVATIONS |
|------|------------|

**FOR REVIEW & FILING  
 NOT FOR CONSTRUCTION**

STAMP:



ARCHITECT:

**David Jaehning Architect**  
 381 11th Street, San Francisco, California 94103

CONSULTANT TEAM:

STRUCTURAL/CIVIL:  
 Design Everest, Inc.  
 365 Flower Lane, Mountain View, CA 94043

LANDSCAPE ARCHITECTURE:

Tomas McKay: Architecture-Landscape Architecture  
 217 Bonita Avenue, Piedmont, CA 94611

IRRIGATION:

Russell D Mitchell & Associates, Inc.  
 2760 Camino Diablo, Walnut Creek, CA 94597

CLIENT:

**Irene Chan-Jones and Bill Jones**  
 100 Burlwood Drive, San Francisco, CA 94127

**ARCHITECTURAL:**

DAVID JAEHNING ARCHITECT  
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 T: +1 415 272 9444

**STRUCTURAL/CIVIL:**

DESIGN EVEREST  
 365 FLOWER LANE  
 MOUNTAIN VIEW, CA 94043  
 T: +1 415 870 1101

**MECHANICAL,  
 ELECTRICAL, &  
 PLUMBING:**

DESIGN/BUILD/PERMIT BY  
 LICENSED CONTRACTOR

**CEC, PART 5, CBCS TITLE 24:**

ENERGY CALC CO  
 45 MITCHELL BLVD SUITE 16  
 SAN RAFAEL, CA 94903  
 T: +1 415 457 0990

**FIRE PROTECTION:**

TBD

**LANDSCAPE DESIGN:**

TOMAS MCKAY: ARCHITECTURE-  
 LANDSCAPE ARCHITECTURE  
 217 BONITA AVE, PIEDMONT CA 94611  
 T: +1 415 730 6649

**IRRIGATION:**

RUSSELL D MITCHELL & ASSOCIATES  
 2760 CAMINO DIABLO,  
 WALNUT CREEK CA 94597  
 T: +1 925 939 3985

**SURVEYOR:**

BGT LAND SURVEYING  
 871 WOODSIDE WAY  
 SAN MATEO, CA 94401  
 T: +1 650 212 1030

**BUILDING/PLANNING CODE  
 INFORMATION:**

APPLICABLE BUILDING CODE: 2016 CA BUILDING STANDARDS  
 CODE, CA CODE OF REGULATIONS  
 TITLE 24, CA RESIDENTIAL CODE,  
 CA PLUMBING CODE, CA  
 MECHANICAL CODE, CA ENERGY  
 CODE, CA FIRE CODE, CALIFORNIA  
 ELECTRICAL CODE

CITY ZONED: S-17 COASTAL DEVELOPMENT  
 DISTRICT

PARCEL SIZE: 5,995 SQ FT

LOT COVERAGE: BUILDING: 1,576 SF  
 HARDSCAPE: 94 SF  
 TOTAL: 1,670 SF

DRIVEWAY AREA  
 (PERMEABLE PAVING): 752 SF

FLOOR AREA RATIO: GOVERNED BY 6300.2.5a

LANDSCAPE AREA  
 (PLANTING): 3,157 SF

OCCUPANCY  
 CLASSIFICATION: R-3

BUILDING AREA (GROSS): LEVEL 1: 1,579 SF  
 LEVEL 2: 1,322 SF  
 TOTAL: 2,901 SF

ALLOWABLE AREA PER  
 6300.2.5a: (0.53)(5,995 SF) = 3,177 SF

GRADE ELEVATION: 198'-0"

BUILDING HEIGHT: 27' - 11 1/2"

BUILDING LEVELS: 2

**BUILDING/PLANNING CODE  
 INFORMATION:**

SEE SHEET A112 FOR ADD'L  
 PARCEL COVERAGE  
 CALCULATIONS

TYPE OF CONSTRUCTION:

TYPE V-B

ROOF CONSTRUCTION:

CLASS 'B' OR HIGHER PER CBC  
 TABLE 1505.1

ALLOWABLE HEIGHT:  
 BUILDABLE AREA:

50'-0" PER TABLE 504.3  
 12,000 SF

OCCUPANT LOAD:

2883 SF/ 200 GROSS = 14 PERSONS

EGRESS REQUIREMENTS:

PER SECTION 1006.2.1:  
 IN GROUP-R-2 AND R-3  
 OCCUPANCIES, ONE MEANS OF  
 EGRESS IS PERMITTED WITHIN  
 AND FROM INDIVIDUAL DWELLING  
 UNITS WITH A MAXIMUM  
 OCCUPANT LOAD OF 20 WHERE  
 THE DWELLING UNIT IS EQUIPPED  
 THROUGHOUT WITH AN  
 AUTOMATIC SPRINKLER SYSTEM IN  
 ACCORDANCE WITH SECTION  
 903.1.1 OR 903.2.1.2 AND THE  
 COMMON PATH OF EGRESS  
 TRAVEL DOES NOT EXCEED 125  
 FEET

SMOKE DETECTOR  
 REQUIREMENTS:

SMOKE DETECTORS TO BE HARD-  
 WIRED AND INTERCONNECTED  
 WITH BATTERY BACKUP PER CBC,  
 STATE FIRE MARSHAL REGS, AND  
 COASTSIDE FIRE ORDINANCE  
 2019-03. ONE DETECTOR MIN AT  
 EACH FLOOR, ONE DETECTOR PER  
 SLEEPING AREA, ONE CENTRALLY-  
 LOCATED DETECTOR PER ACCESS  
 AREA TO SLEEPING AREA.

**BUILDING/PLANNING CODE  
 INFORMATION:**


FIRE SPRINKLER  
 REQUIREMENTS:

PROVIDE AUTOMATIC SPRINKLER  
 SYSTEM (INSTALLED UNDER  
 SEPARATE PERMIT) AT DWELLING  
 AND GARAGE. ALL UNDERGROUND  
 SPRINKLER LINES SHALL BE  
 FLUSHED AND INSPECTED BY FIRE  
 DISTRICT PRIOR TO HOOK-UP TO  
 RISER.



① LOCATION PLAN  
 1" = 800'-0"

COUNTY APPROVAL STAMP

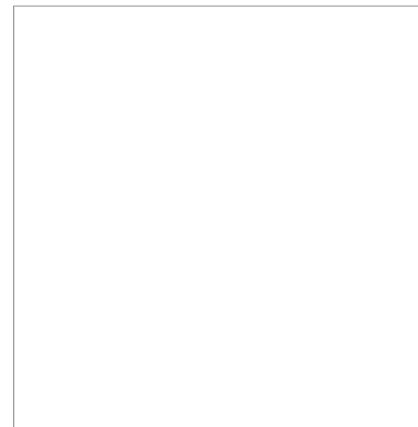

PROJECT NO: PROJECT NAME:

**2101 House on a Hill**

APN: 036-031-280

PROJECT ADDRESS: 10th Street  
 Montara, CA 94037

PROJECT PHASE: **Construction Documents**

DRAWN: AG CHECKED Checker

ISSUE DATE: 2/16/2022 9:03:01 PM

DRAWING TITLE: **COVER SHEET**

DRAWING NO: **A000**

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 Architect.

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|-----------|-----|-----------------------|------------|
|           | 2   | PLN2021-00187 CYCLE 2 | 8/5/2021   |
|           | 3   | PLN2021-00187 CYCLE 3 | 12/21/2021 |

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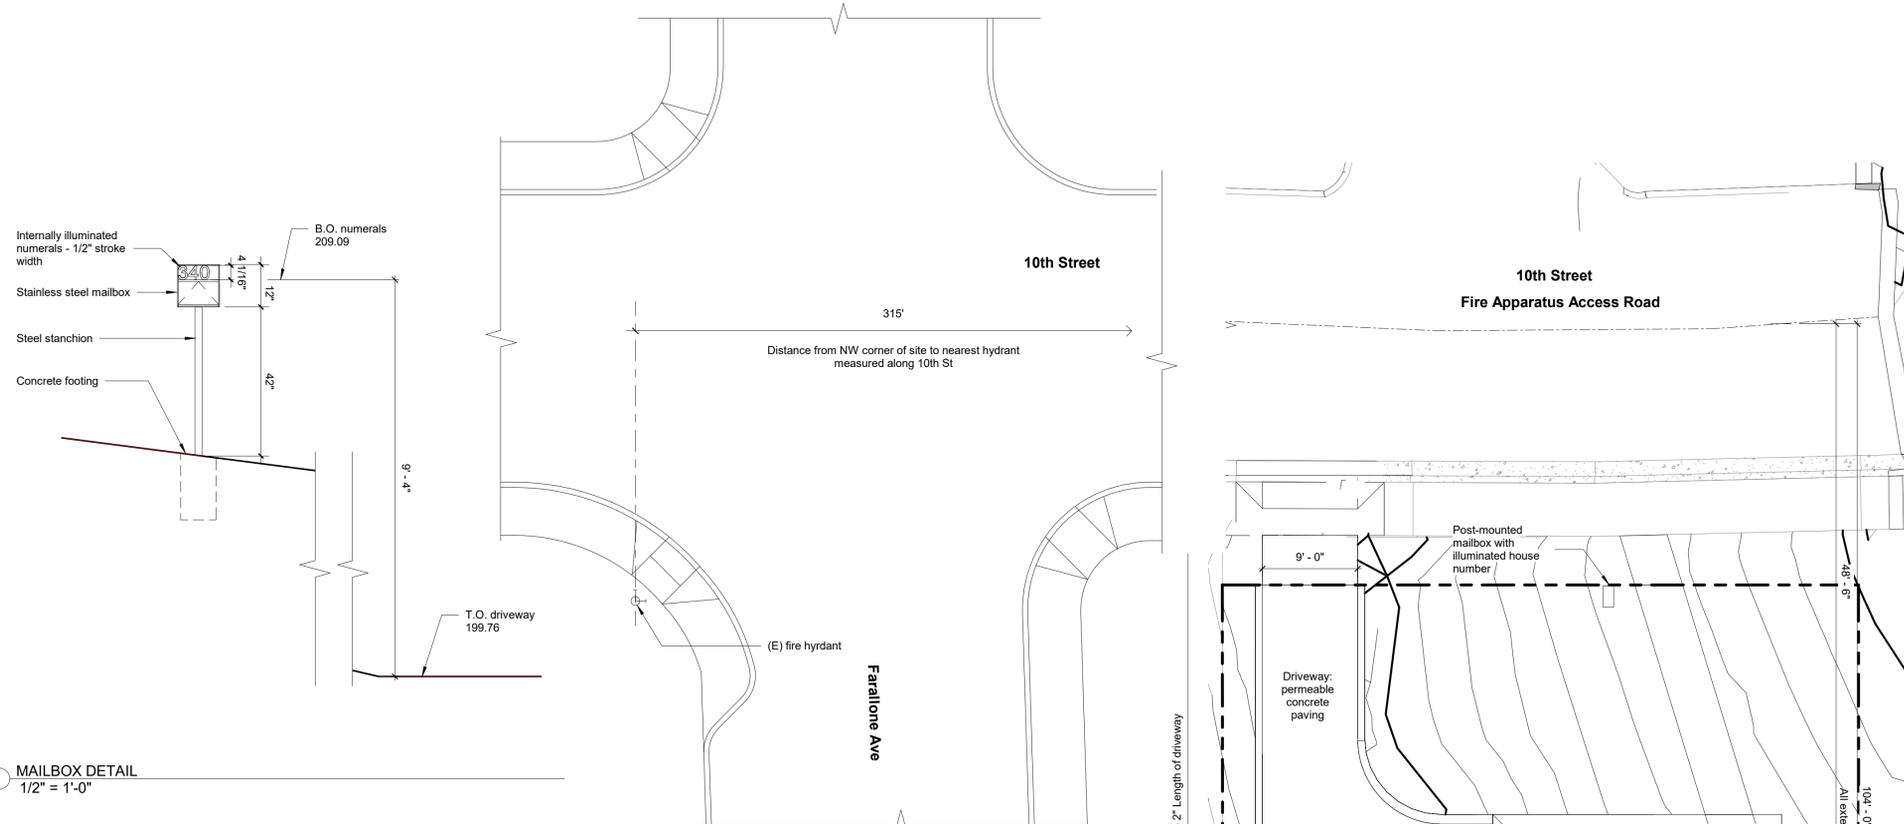
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ISSUE DATE: 2/16/2022 9:03:03 PM


DRAWING TITLE: **LIFE & FIRE SAFETY PLAN**

DRAWING NO: **A002**


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MAILBOX DETAIL  
1/2" = 1'-0"




1 GROUND FLOOR LIFE SAFETY PLAN  
1/8" = 1'-0" REF 1 - A113

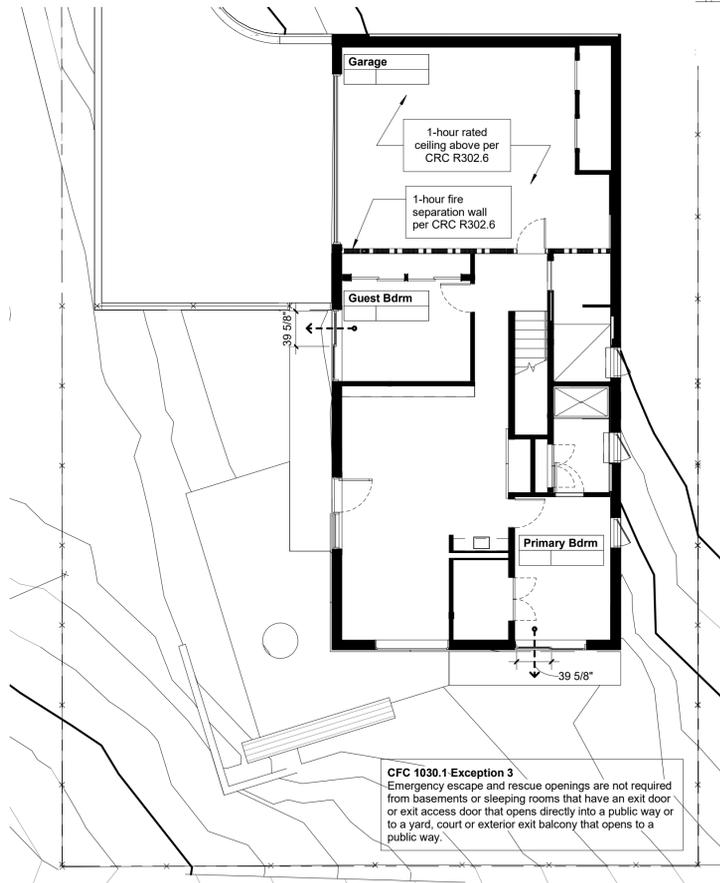

2 SECOND FLOOR LIFE SAFETY PLAN  
1/8" = 1'-0" REF 1 - A113

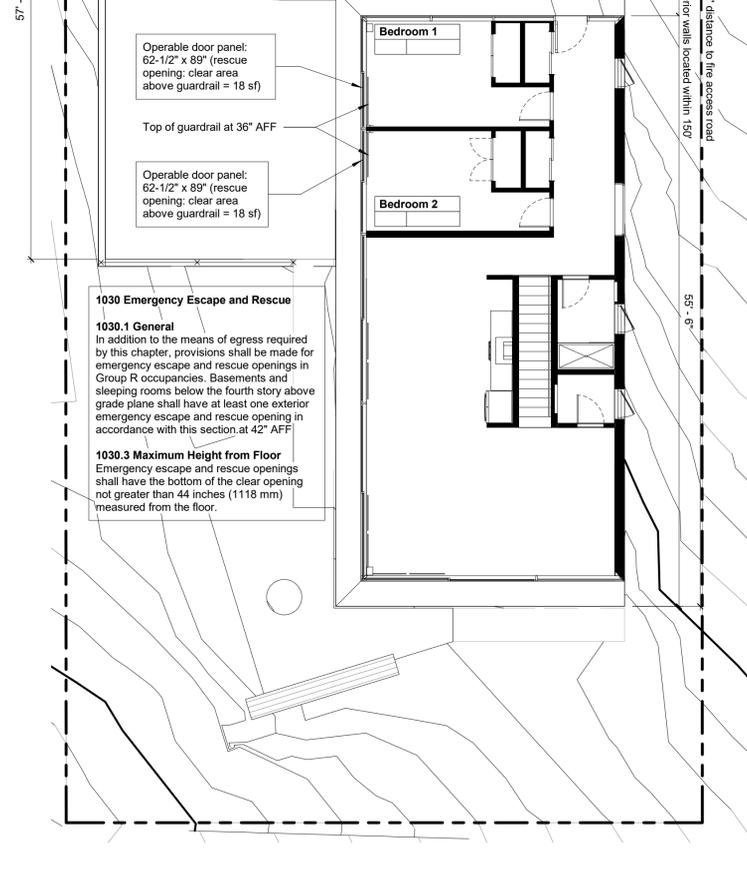COUNTY APPROVAL STAMP

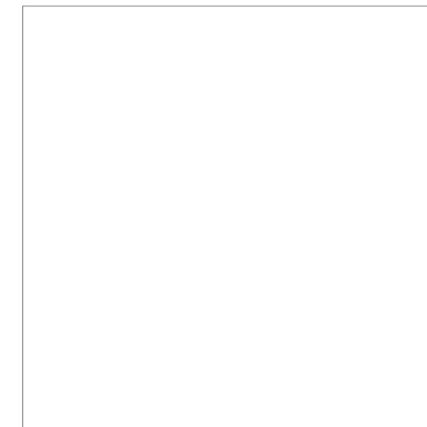

**Fire Resistive Construction**

**703A.2 Qualification by Testing**  
Material and material assemblies tested in accordance with the requirements of Section 703A shall be accepted for use when the results and conditions of those tests are met. Product evaluation testing of material and material assemblies shall be approved or listed by the State Fire Marshal, or identified in a current report issued by an approved agency.

**704A.4 Alternative Methods for Determining Ignition-Resistant Material**  
1. Noncombustible material. Material that complies with the definition for noncombustible materials in Section 202.

*NONCOMBUSTIBLE. Material of which no part will ignite and burn when subjected to fire. Any material passing ASTM E136 shall be considered noncombustible.*

**705A.2 Roof Coverings**  
Where the roof profile allows a space between the roof covering and roof decking, the spaces shall be constructed to resist the intrusion of flames and embers, be firestopped with approved materials or have one layer of minimum 72 pound (32.4 kg) mineral-surfaced nonperforated cap sheet complying with ASTM D3909 installed over the combustible decking.

**705A.4 Roof Gutters**  
Roof gutters shall be provided with the means to prevent the accumulation of leaves and debris in the gutter.


**Exception:** Any of the following shall be deemed to meet the assembly performance criteria and intent of this section:

- 707A.3 Exterior Walls**
- One layer of 5/8-inch Type X gypsum sheathing applied behind the exterior covering or cladding on the exterior side of the framing
  - The exterior portion of a 1-hour fire resistive exterior wall assembly designed for exterior fire exposure including assemblies using the gypsum panel and sheathing products listed in the Gypsum Association Fire Resistance Design Manual

**707A.5 Enclosed Roof Eaves and Roof Eave Soffits**

The exposed underside of enclosed roof eaves having either a boxed-in roof eave soffit with a horizontal underside, or sloping rafter tails with an exterior covering applied to the under-side of the rafter tails, shall be protected by one of the following:  
Noncombustible material  
Ignition-resistant material  
One layer of 5/8-inch Type X gypsum sheathing applied behind an exterior covering on the underside of the rafter tails or soffit  
The exterior portion of a 1-hour fire resistive exterior wall assembly applied to the underside of the rafter tails or soffit including assemblies using the gypsum panel and sheathing products listed in the Gypsum Association Fire Resistance Design Manual

| NO. | DESCRIPTION           | DATE       |
|-----|-----------------------|------------|
| 2   | PLN2021-00187 CYCLE 2 | 8/5/2021   |
| 3   | PLN2021-00187 CYCLE 3 | 12/21/2021 |

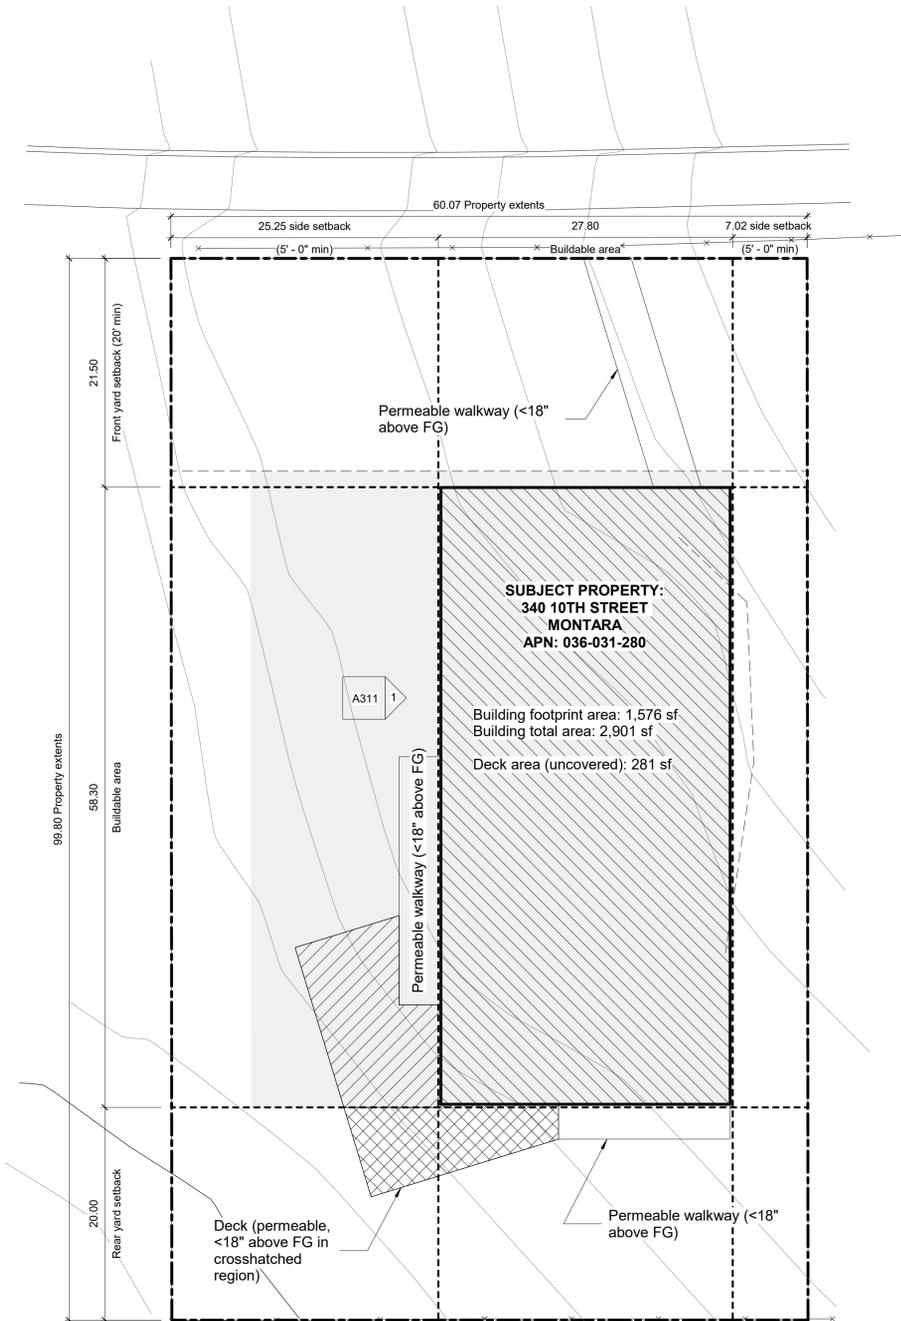

The following regulations shall apply in any single-family residential district with which the "S-17" District is combined.

**Building Site Width**  
The minimum building site width shall be an average of 50 feet.

*Building site is 60.07' wide*

**Building Site Area**  
The minimum building site area shall be 5,000 sq ft

*Building site area is 5,995 sq ft ±*

**Building Setbacks**  
The minimum setbacks shall be:  
Front setback: 20 ft  
Rear setback: 20 ft  
Side setback: 5 ft if 16 ft in height or less; For structures over 16 feet in height: combined total of 15 feet with a minimum of 5 feet on any side.

*Proposed front yard setback: 20 ft  
Proposed rear yard setback: 20 ft  
Proposed side yard setbacks: 25.25 ft (west) + 7.02 ft (east) = 32.27' total (>15')*

In any area where the "S-17" District is combined with the "DR" District, the minimum side yard setback may be reduced to provide for creative design concepts such as "zero" side yard setbacks provided that: (1) the Design Review Committee approves, (2) the application involves joint development of two or more adjacent parcels, (3) the total side yard requirement is met and (4) a minimum side yard of 5 feet is maintained adjacent to any parcel not included with the application.

**Parcel Coverage**  
The maximum parcel coverage shall be:

- a. For structures 16 feet in height or less: 50%.
- b. For structures greater than 16 feet in height: 35%.

Parcel coverage shall include all: (1) buildings, (2) accessory buildings, or (3) structures such as patios, decks, balconies, porches, bridges, and other similar uses which are eighteen (18) inches or more above the ground.

**Building Floor Area**  
The maximum building floor area shall be established according to the parcel size:  
5,000 - 11,968 sq ft = 0.53 of parcel size (or 3,177 SF)

The maximum building floor area shall include the floor area of all stories of all buildings and accessory buildings on a building site. Maximum building floor area specifically includes:  
(1) gross floor area of all stories,  
(2) the area of all decks, porches, balconies or other areas covered by a waterproof roof, which extends four (4) or more feet from exterior walls,  
(3) the area of all garages and carports.

**Parcel Coverage:**

Structures >16' in height: 1,576 SF = 26.22% (complies with 35% limit)  
Structures <16' in height: 281 SF = 4.6% (complies with 50% limit)  
Hardscape: 94 SF = 1.5% (complies with 10% limit)  
**Total: 1,670 SF (28%)**

Driveway (pervious) area: **752 SF**

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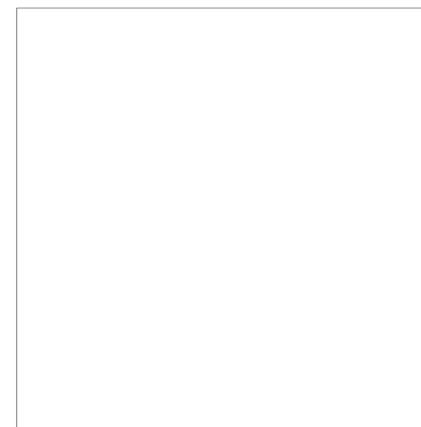
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COUNTY APPROVAL STAMP



① LOT COVERAGE DIAGRAM  
1/8" = 1'-0"

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APN: 036-031-280

PROJECT ADDRESS: 10th Street  
Montara, CA 94037

PROJECT PHASE: **Construction Documents**

DRAWN: Author CHECKED: Checker

ISSUE DATE: 2/16/2022 9:03:04 PM

DRAWING TITLE: **LOT COVERAGE DIAGRAM**

DRAWING NO: **A003**

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# SITE IMPROVEMENT PLAN



PROJECT LOCATION MAP

VICINITY MAP

### BASIS OF BEARINGS:

THE BEARING, SOUTH 61°17'53" EAST, OF THE CENTERLINE OF 10TH STREET, AS SHOWN ON THAT CERTAIN RECORD OF SURVEY WHICH WAS FILED FOR RECORD IN BOOK 23 OF LLS MAPS PAGE 87 ON JUNE 20, 2002, SAN MATEO COUNTY RECORDS., WAS USED AS THE BASIS OF BEARINGS FOR THIS SURVEY.

### BENCHMARK:

ELEVATIONS SHOWN HEREON ARE BASED UPON NGVD 29 ("MEAN SEA LEVEL" DATUM). SITE BENCHMARK IS THE SANITARY SEWER MANHOLE LID WITH AN ELEVATION OF 200.75 FEET.

### SURVEY NOTES:

BGT RELIED UPON A LAWYERS TITLE COMPANY PRELIMINARY TITLE REPORT, ORDER NO. 0051900303, AS TITLE REFERENCE. NO EASEMENTS WERE REFERENCED WITHIN SAID REPORT.

UTILITIES SHOWN HEREON TAKEN FROM VISUAL SURFACE EVIDENCE AND SHOULD BE CONSIDERED AS APPROXIMATE ONLY. ACTUAL LOCATIONS OF UTILITIES MAY VARY. TRUE LOCATION OF UTILITIES CAN ONLY BE OBTAINED BY EXPOSING THE UTILITY.

SURVEY PERFORMED BY: BGT LAND SURVEYING  
www.bgtssurveying.com

### STATEMENT OF RESPONSIBILITY:

- CONTRACTOR AGREES THAT HE SHALL ASSUME SOLE AND COMPLETE RESPONSIBILITY FOR JOB SITE CONDITIONS DURING THE COURSE OF CONSTRUCTION OF THIS PROJECT, INCLUDING SAFETY OF ALL PERSONS AND PROPERTY; THAT THIS REQUIREMENT SHALL APPLY CONTINUOUSLY AND NOT BE LIMITED TO NORMAL WORKING HOURS AND THAT THE CONTRACTOR SHALL DEFEND, INDEMNIFY AND HOLD THE OWNER AND THE ENGINEER HARMLESS FROM ANY AND ALL LIABILITY, REAL OR ALLEGED, IN CONNECTION WITH THE PERFORMANCE OR WORK ON THIS PROJECT.
- PROTECT TREES TO REMAIN, UNLESS OTHERWISE NOTED, BOTH ON-SITE AND ADJACENT PROPERTIES.
- PROTECT NEIGHBORING PROPERTIES FROM DAMAGE DURING CONSTRUCTION.
- IT IS THE CONTRACTOR'S RESPONSIBILITY TO MAINTAIN AND PRESERVE THE EXISTING MONUMENTS OF RECORD. SHOULD THE CONTRACTOR DESTROY OR DISTURB ANY MONUMENTS OF RECORD, THE CONTRACTOR SHALL, AT ITS SOLE EXPENSE, RETAIN A CALIFORNIA LICENSED LAND SURVEYOR TO REPLACE SAID MONUMENTS AND FILE AN APPROPRIATE CORNER RECORD.
- CONTRACTOR SHALL REPLACE OR REPAIR, AT HIS OWN EXPENSE, ALL DAMAGED, REMOVED OR OTHERWISE DISTURBED EXISTING UTILITIES, OR IMPROVEMENTS IN KIND.
- THE CONTRACTOR SHALL COMPLY WITH ALL OSHA REQUIREMENTS RELATED TO SHORING OF EXCAVATIONS.
- CONTRACTOR SHALL CLEAN STREETS TO REMOVE ACCUMULATION OF MUD AND DEBRIS RESULTING FROM CONSTRUCTION ACTIVITIES.
- THE CONTRACTOR IS RESPONSIBLE FOR CONFORMING TO EXISTING PAVEMENT, ADJACENT LANDSCAPE AND OTHER IMPROVEMENTS WITH A SMOOTH TRANSITION IN PAVING, CURBS, GUTTERS, SIDEWALK, ETC. TO AVOID ABRUPT OR APPARENT CHANGES IN GRADES OR CROSS SLOPES, LOW SPOTS OR HAZARDOUS CONDITIONS
- CONTRACTOR TO OBTAIN REQUIRED PERMITS FOR HAUL ROUTES PRIOR TO DEMOLITION AND CONSTRUCTION.
- CONTRACTOR IS RESPONSIBLE FOR SCHEDULING ALL INSPECTIONS AS REQUIRED.
- THE CONTRACTOR SHALL TAKE ALL NECESSARY PRECAUTIONS TO PRESERVE AND PROTECT THOSE TREES AND ANY FENCES WHICH MAY BE REQUIRED TO REMAIN BY THE OWNER.

### PERVIOUS CONCRETE REQUIREMENTS:

#### CONTRACTOR OR PERMITEE SHALL:

- PROVIDE CERTIFICATION FROM THE CONCRETE MANUFACTURER THAT THE CONCRETE MEETS THE REQUIREMENTS OF THE C3 STORMWATER HANDBOOK FOR PERVIOUS CONCRETE. THIS INCLUDES, BUT IS NOT LIMITED TO, HAVING A MINIMUM SURFACE INFILTRATION RATE OF 100 INCHES PER HOUR WHEN TESTED IN ACCORDANCE WITH ASTM C1701.
- ONLY CONTRACTORS HOLDING CERTIFICATION OF COMPLETION FROM THE NATIONAL READY MIX CONCRETE ASSOCIATION (NRMA) SHALL INSTALL THE CONCRETE AND AT LEAST ONE FOREMAN WITH THIS CERTIFICATION MUST BE ON THE JOB SITE AT ALL TIMES DURING CONCRETE INSTALLATION.
- PROTECT THE EXCAVATED AREA FROM EXCESSIVE COMPACTION DUE TO CONSTRUCTION TRAFFIC AND PROTECT THE FINISHED PAVEMENT FROM CONSTRUCTION TRAFFIC.

### MAINTENANCE:

- A MAINTENANCE PLAN SHALL BE PROVIDED
- KEEP LANDSCAPED AREAS WELL MAINTAINED.
- PREVENT SOIL FROM WASHING ONTO THE PAVEMENT. PERVIOUS PAVEMENT SURFACE SHALL BE VACUUM CLEANED USING COMMERCIALY AVAILABLE SWEEPING MACHINES AT FOLLOWING TIMES:  
-END OF WINTER (APRIL)  
-MID-SUMMER (JULY / AUGUST)  
-AFTER AUTUMN LEAF-FALL (NOVEMBER)
- INSPECT OUTLETS YEARLY, PREFERABLY BEFORE WET SEASON. REMOVE ACCUMULATED TRASH/DEBRIS.
- WHEN VACUUM CLEANING, INSPECT PERVIOUS PAVING FOR ANY SIGNS OF HYDRAULIC FAILURE.

### AS NEEDED MAINTENANCE:

- IF ROUTINE CLEANING DOES NOT RESTORE INFILTRATION RATES, THEN RECONSTRUCTION OF PART OF THE PERVIOUS SURFACE MAY BE REQUIRED.
- THE SURFACE AREA AFFECTED BY HYDRAULIC FAILURE SHOULD BE LIFTED, IF POSSIBLE, FOR INSPECTION OF THE INTERNAL MATERIALS TO IDENTIFY THE LOCATION AND EXTENT OF BLOCKAGE.
- LIFT AND REPLACE SURFACE MATERIALS AS NEEDED TO RESTORE INFILTRATION. GEOTEXTILES MAY NEED COMPLETE REPLACEMENT.
- SUB-SURFACE LAYERS MAY NEED CLEANING AND REPLACING.
- REMOVED SILTS MAY NEED TO BE DISPOSED OF AS CONTROLLED WASTE.


### EARTHWORK QUANTITIES

|         |        |
|---------|--------|
| CUT:    | 342 CY |
| FILL:   | 33 CY  |
| EXPORT: | 309 CY |
| IMPORT: | 0 CY   |

NOTE: EARTHWORK QUANTITIES SHOWN ARE APPROXIMATE. IT SHALL BE THE CONTRACTOR'S RESPONSIBILITY TO INDEPENDENTLY ESTIMATE QUANTITIES FOR HIS/HER OWN USE.

### SHEET INDEX:

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### ABBREVIATIONS:
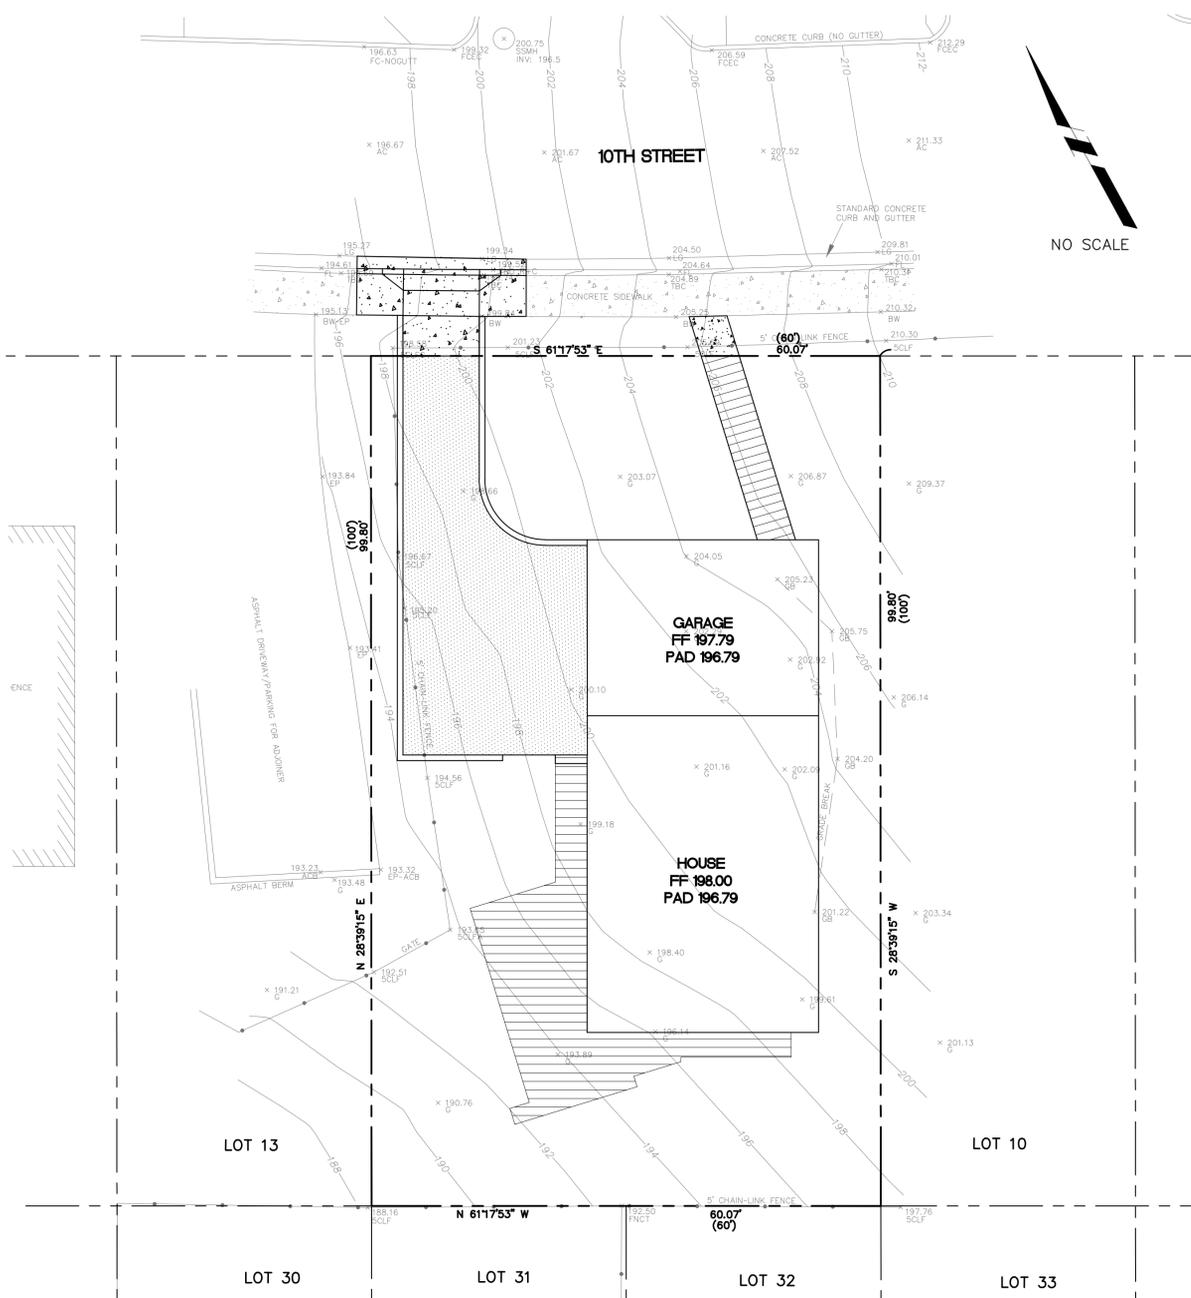
|       |                          |
|-------|--------------------------|
| BS    | BOTTOM STEP              |
| BW    | BOTTOM OF WALL           |
| EX    | EXISTING                 |
| FF    | FINISHED FLOOR           |
| FG    | FINISHED GRADE           |
| FL    | FLOW LINE                |
| HMA-A | HOT MIX ASPHALT (TYPE A) |
| INV   | INVERT                   |
| GB    | GRADE BREAK              |
| LP    | LOW POINT                |
| O.C.  | ON CENTER                |
| OG    | ORIGINAL GROUND          |
| PCC   | PORTLAND CEMENT CONCRETE |
| PL    | PROPERTY LINE            |
| PVC   | POLYVINYL CHLORIDE       |
| R     | RADIUS                   |
| RET   | RETAINING                |
| SD    | STORM DRAIN              |
| SUB   | SUBDRAIN                 |
| TC    | TOP OF CURB              |
| TD    | TOP OF DECK              |
| TG    | TOP OF GRATE             |
| TS    | TOP OF STEP              |
| TW    | TOP OF WALL              |
| TYP   | TYPICAL                  |

### LEGEND:

|     |                                |
|-----|--------------------------------|
| --- | PROPERTY LINE                  |
| •   | SPOT ELEVATION                 |
| 1   | CONSTRUCTION REFERENCE NOTE    |
| --- | SUBDRAIN SYSTEM                |
| --- | DRAIN PIPE SYSTEM              |
| --- | EXISTING BUILDING              |
| ○   | DOWNSPOUT                      |
| —   | CLEAN OUT                      |
| ▨   | PERMEABLE WOOD DECK            |
| ▨   | PERVIOUS CONCRETE DRIVEWAY     |
| ▨   | CONCRETE SIDEWALK AND DRIVEWAY |



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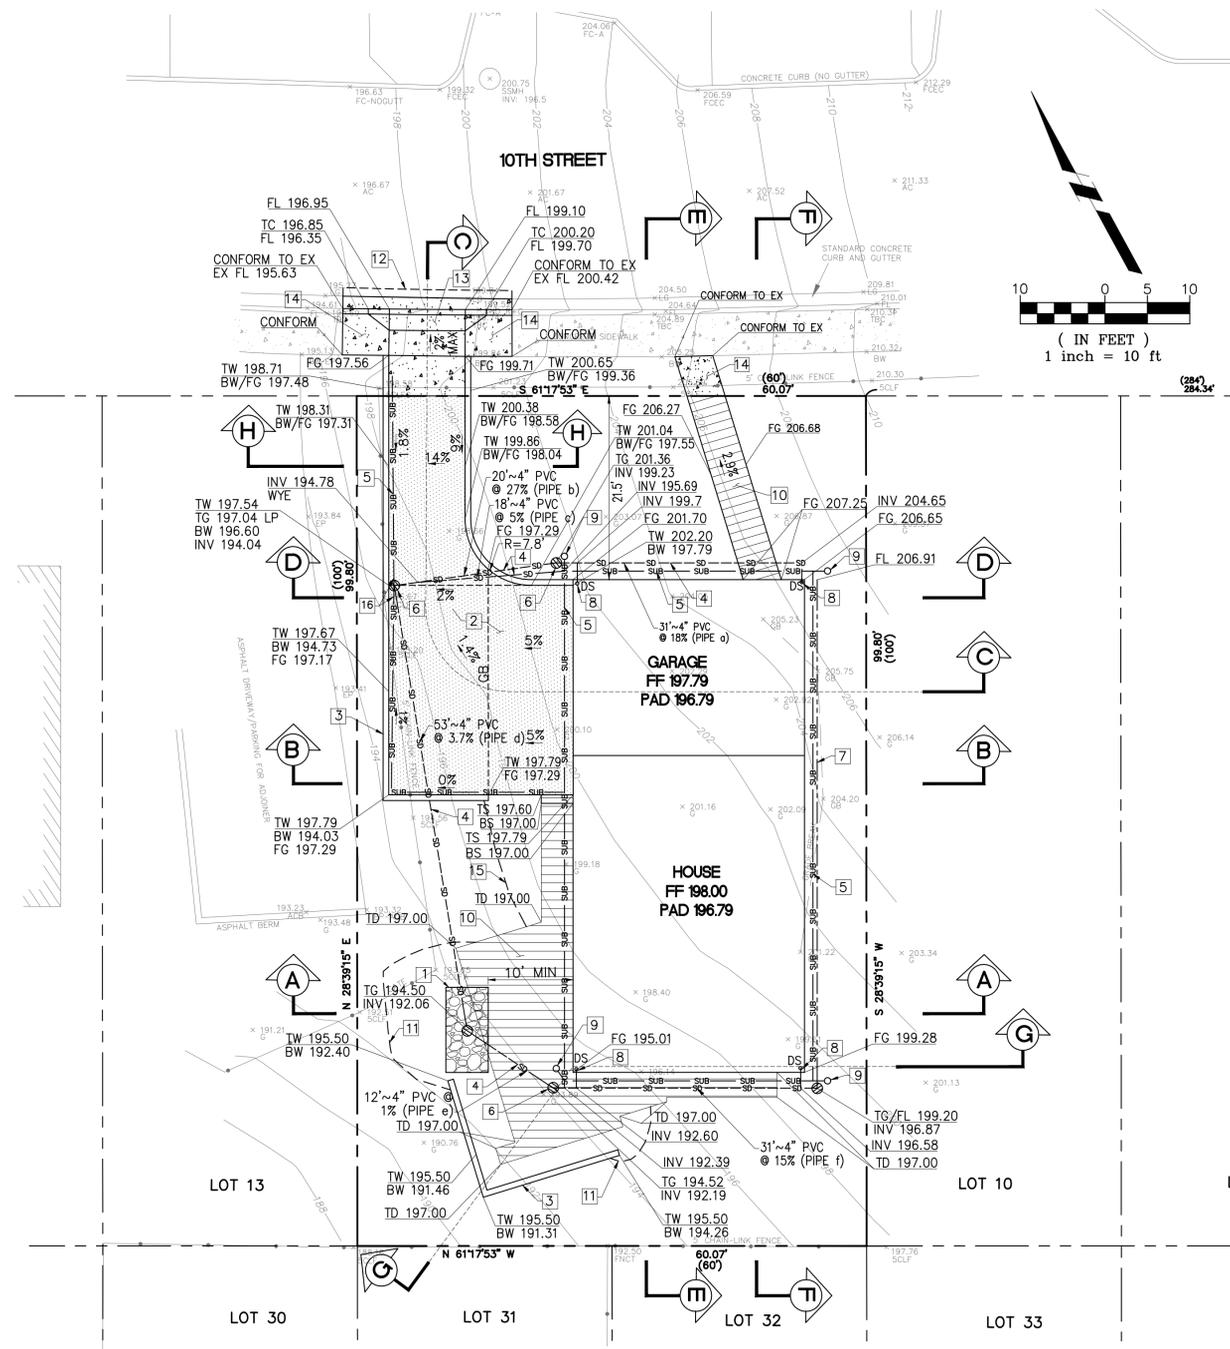
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PROJECT NO: PROJECT NAME:  
**2101 House on a Hill**  
APN: 036-031-280  
PROJECT ADDRESS: 340 10th Street, Mountain View, CA 94037  
PROJECT PHASE: **100% Schematic Design**  
DRAWN: CK CHECKED: CK  
ISSUE DATE: November 02, 2021  
DRAWING TITLE: **COVER SHEET**  
DRAWING NO: **C001**

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**GRADING/DRAINAGE NOTES:**

- THE DESIGN AND LOCATIONS OF SUBDRAINAGE SYSTEMS AROUND THE FOUNDATION PERIMETER ARE DEPEND ON THE AVAILABLE INFORMATION DURING DESIGN PHASE. GEOTECHNICAL CONSULTANT SHALL REVIEW AND PROVIDE THE RECOMMENDATIONS BEFORE GRADING WORKS BEGIN.
- IT IS EXTREMELY IMPORTANT THAT STRONG MEASURES BE TAKEN TO CONTROL AND CONDUCT ALL SURFACE AND SUBSURFACE WATERS AWAY FROM THE PROJECT SITE SO THAT THEY DO NOT ADVERSELY AFFECT THE FOUNDATION OF THE STRUCTURE OR THE STABILITY OF ADJACENT SLOPES, AND THAT ALL DRAINAGE FACILITIES BE DILIGENTLY MAINTAINED.
- PROTECTIVE NATURAL VEGETATION, AND EVEN PLANTING TREES AND SHRUBS ON BARREN SLOPES WILL ALSO HELP TO MAINTAIN SLOPE STABILITY AND LIMIT EROSION.
- THE CONTRACTOR SHALL POTHOLE AND VERIFY LOCATIONS AND ELEVATIONS OF ALL CONNECTIONS TO EXISTING UNDERGROUND FACILITIES BEFORE ANY CONSTRUCTION. THE ENGINEER MUST BE NOTIFIED IMMEDIATELY IF CONDITIONS DIFFER FROM THOSE SHOWN ON THE PLANS SO THAT DESIGN CHANGES CAN BE MADE.
- IT IS THE CONTRACTOR'S RESPONSIBILITY TO VERIFY THE LOCATIONS OF ALL EXISTING UNDERGROUND UTILITIES AND DRAIN PIPES. CALL USA (UNDERGROUND SERVICE ALERT) 2 WORKING DAYS BEFORE DIGGING AT 811. LOCATIONS SHOWN ON THE PLANS WERE TAKEN FROM AVAILABLE RECORDS AND ARE APPROXIMATE AND SHOWN FOR GENERAL INFORMATION ONLY, AND MAY BE INCOMPLETE. RELOCATION OR REPAIR OF ANY DAMAGE TO UTILITIES OR PIPELINES AND PLUGGING OR REMOVAL OF ABANDONED LINES SHALL BE THE CONTRACTOR'S RESPONSIBILITY.
- CONSTRUCTION ENTRANCES SHALL BE INSTALLED PRIOR TO COMMENCEMENT OF GRADING. ALL CONSTRUCTION TRAFFIC ACCESSING AND EXITING THE SITE MUST CROSS THE STABILIZED CONSTRUCTION ENTRANCE WAYS.
- INFORMATION REGARDING EXISTING UTILITIES IS FROM RECORD DATA AND MAY NOT REPRESENT ACTUAL CONDITIONS. CONTRACTOR SHALL CONDUCT FIELD EVALUATION OF ALL EXISTING SUBSURFACE IMPROVEMENTS AND UTILITIES, WHETHER SHOWN ON THESE PLANS OR NOT, PRIOR TO THE COMMENCEMENT OF WORK.
- THE CONTRACTOR SHALL TAKE ALL PRECAUTIONS NECESSARY TO AVOID PROPERTY DAMAGE TO ADJACENT PROPERTIES DURING THE CONSTRUCTION PHASE OF THE PROJECT. THE CONTRACTOR WILL BE HELD RESPONSIBLE FOR ANY DAMAGES TO ADJACENT PROPERTIES OCCURRING DURING THE CONSTRUCTION PHASE OF THE PROJECT.
- THE CONTRACTOR WILL BE RESPONSIBLE FOR PROVIDING AND MAINTAINING TRAFFIC CONTROL DEVICES SUCH AS BARRICADES, WARNING SIGNS, DIRECTIONAL SIGNS, FLAGMEN AND LIGHTS TO CONTROL THE MOVEMENT OF TRAFFIC WHERE NECESSARY. PLACEMENT OF THESE DEVICES SHALL BE APPROVED BY THE COUNTY/CITY ENGINEER PRIOR TO PLACEMENT. TRAFFIC CONTROL DEVICES SHALL CONFORM TO THE APPROPRIATE CALIFORNIA MUTCD (MANUAL ON UNIFORM TRAFFIC CONTROL DEVICES).
- IN ACCORDANCE WITH GENERALLY ACCEPTED CONSTRUCTION PRACTICES, THE CONTRACTOR WILL BE SOLELY AND COMPLETELY RESPONSIBLE FOR CONDITIONS ON THE JOB SITE, INCLUDING SAFETY OF ALL PERSONS AND PROPERTY DURING THE PERFORMANCE OF THE WORK. THIS REQUIREMENT WILL APPLY CONTINUOUSLY AND NOT BE LIMITED TO NORMAL WORKING HOURS.
- THE CONTRACTOR SHALL BE REQUIRED TO OBTAIN ALL PERMITS FROM AUTHORITIES AND REGULATORY AGENCIES HAVING JURISDICTION OVER THE SITE, AS REQUIRED, PRIOR TO BEGINNING WORK.
- BEFORE BEGINNING CONSTRUCTION, THE CONTRACTOR SHALL COMPLY WITH THE EROSION CONTROL PLAN AND PERMIT.
- MINIMIZE INTERFERENCE WITH ADJOINING ROADS, STREETS, WALKS, AND OTHER ADJACENT OCCUPIED OR USED FACILITIES DURING EARTH MOVING OPERATIONS.
- DO NOT CLOSE OR OBSTRUCT STREETS, WALKS, OR OTHER ADJACENT OCCUPIED OR USED FACILITIES WITHOUT PERMISSION FROM OWNER AND AUTHORITIES HAVING JURISDICTION.
- PROVIDE ALTERNATE ROUTES AROUND CLOSED OR OBSTRUCTED TRAFFIC WAYS IF REQUIRED BY OWNER OR AUTHORITIES HAVING JURISDICTION.
- DO NOT CONDUCT WORK ON ADJOINING PROPERTY UNLESS DIRECTED BY ENGINEER.
- DO NOT COMMENCE EARTH-MOVING OPERATIONS UNTIL TEMPORARY EROSION- AND SEDIMENTATION-CONTROL MEASURES ARE IN PLACE.
- PROTECT STRUCTURES, UTILITIES, SIDEWALKS, PAVEMENTS, AND OTHER FACILITIES FROM DAMAGE CAUSED BY SETTLEMENT, LATERAL MOVEMENT, UNDERMINING, WASHOUT, AND OTHER HAZARDS CREATED BY EARTH MOVING OPERATION.
- PROTECT AND MAINTAIN EROSION AND SEDIMENTATION CONTROLS DURING EARTH MOVING OPERATIONS.
- PROTECT SUBGRADES AND FOUNDATION SOILS FROM FREEZING TEMPERATURES AND FROST. REMOVE TEMPORARY PROTECTION BEFORE PLACING SUBSEQUENT MATERIALS.
- EXCAVATE BY HAND AROUND TREE TO INDICATED LINES, CROSS SECTIONS, ELEVATIONS, AND SUBGRADES. USE NARROW-TIME SPADING FORKS TO COMB SOIL AND EXPOSE ROOTS. DO NOT BREAK, TEAR, OR CHOP EXPOSED ROOTS. DO NOT USE MECHANICAL EQUIPMENT THAT RIPS, TEARS, OR PULLS ROOTS.
- UNIFORMLY GRADE AREAS TO A SMOOTH SURFACE, FREE OF IRREGULAR SURFACE CHANGES. COMPLY WITH COMPACTION REQUIREMENTS AND GRADE TO CROSS SECTIONS, LINES, AND ELEVATIONS INDICATED.
- PROVIDE A SMOOTH TRANSITION BETWEEN ADJACENT EXISTING GRADES AND NEW GRADES.
- CONTRACTOR SHALL GRADE EVENLY BETWEEN SPOT ELEVATIONS SHOWN.
- NO CUT OR FILL SLOPES MAY BE STEEPER THAN 2:1 (H:V) MAXIMUM.
- IN THE EVENT ADVERSE BEDDING PLANES ARE DISCOVERED DURING CONSTRUCTION REQUIRING SLOPE STABILIZATION TECHNIQUES, SUCH WORK SHALL BE APPROVED BY THE COUNTY ENGINEER UNDER A REVISED GRADING PLAN AND CHANGE ORDER.
- FINE GRADING AROUND STRUCTURES SHALL DRAIN AWAY FROM FOOTINGS, TO THE SATISFACTION OF THE COUNTY INSPECTOR, TO SWALES WITH 1% MINIMUM SLOPE TO APPROVED DRAINAGE POINTS OR NOTED OTHERWISE ON PLANS.
- ANY CHANGES IN THE WORK SHOWN HEREON SHALL BE SUBJECT TO THE APPROVAL OF THE COUNTY ENGINEER.
- NO STOCKPILING AND/OR IMPORT/EXPORT HAULING SHALL BE PERMITTED UNLESS APPROVED ON THE GRADING PERMIT.
- THE PERMITTEE SHALL EMPLOY A REGISTERED CIVIL ENGINEER OR SOIL ENGINEER TO PROVIDE CONSTANT ON-SITE GRADING SUPERVISION TO ASSURE COMPLIANCE WITH THE APPROVED PLANS.
- WHERE IMPORT MATERIALS ARE REQUIRED FOR USE ON SITE, THE SOILS ENGINEER SHOULD BE NOTIFIED AT LEAST 48 HOURS IN ADVANCE OF IMPORTING IN ORDER TO SAMPLE AND TEST MATERIALS FROM PROPOSED BORROW SITES.
- AREAS TO RECEIVE FILL OR FLATWORK SHALL BE CLEARED OF VEGETATION AND STRIPPED TO A SUFFICIENT DEPTH TO REMOVE MAJOR ROOT SYSTEMS. THE STRIPPED ORGANIC TOP SOIL MATERIAL MAY BE STOCK PILED FOR LATER USE IN LANDSCAPING AREAS.
- PERMANENT CUT SLOPES SHALL BE AT A MAXIMUM INCLINATION OF 2:1 (HORIZONTAL TO VERTICAL) OR SHALL BE RETAINED BY STRUCTURAL WALLS.
- FILLS PLACED ON SLOPING GRADES SHALL BE KEYED INTO FIRM SOIL AT THE BASE (OR RETAINED BY ENGINEERED WALLS), AND PROGRESSIVELY STEP-BENCHED UP THE SLOPE. THE GEOTECHNICAL ENGINEER SHALL INSPECT AND APPROVE THE SUBGRADE PREPARATION PRIOR TO PLACEMENT OF FILL. FILLS SHALL BE PLACED IN LEVEL LIFTS NO MORE THAN 8 INCHES IN THICKNESS, AND SHALL BE COMPACTED TO 95% RELATIVE COMPACTION UNDER ALL BUILDING AND PAVEMENT AREAS, AND TO 90% RELATIVE COMPACTION UNDER ALL OTHER AREAS. EXISTING SITE SOILS ARE SUITABLE AS FILL PROVIDED THEY ARE FREE OF ORGANIC MATERIAL AND ROCKS OR RUBBLE OVER 6 INCHES IN DIAMETER.
- DRAINAGE SYSTEM REQUIRE REGULAR MAINTENANCE TO ENSURE PROPER FUNCTIONING. CATCH BASINS AND DOWNSPOUT PIPES SHOULD BE FLUSHED REGULARLY (DEPENDANT ON THE RATE OF FALLING LEAF LITTER). IT IS CRITICAL THAT OUTLET DISSIPATORS/DRAINAGE BASINS BE INSPECTED AND FLUSHED APPLICABLE FACILITIES ON A REGULAR BASIS. IT IS RECOMMENDED THAT AN ACCURATE AS-BUILT PLAN OF THE DRAINAGE SYSTEMS BE PREPARED, AND THAT MAINTENANCE REQUIREMENTS BE DISCLOSED TO ALL FUTURE BUYERS OF THE PROPERTY.
- IT IS RECOMMENDED THAT A TEMPORARY SHORING SYSTEM BE CONSTRUCTED AROUND THE BASEMENT AREA, FOR THE SAFETY OF THE CONSTRUCTION WORKERS AND FOR THE PROTECTION OF THE NEIGHBORS' EXISTING STRUCTURES.
- PRIOR TO GRADING, THE PROPOSED STRUCTURE AND PAVEMENT AREAS SHOULD BE CLEARED OF ALL OBSTRUCTIONS, AND DELETERIOUS MATERIALS. THE EXISTING FOUNDATION AND PIPES SHOULD BE REMOVED. AFTER CLEARING, THESE AREAS SHOULD BE STRIPPED OF ALL ORGANIC TOPSOIL. THE PREDOMINANTLY ORGANIC MATERIALS GENERATED FROM THE STRIPPING SHOULD BE REMOVED FROM THE SITE.
- AFTER THE ORGANIC TOPSOIL HAS BEEN STRIPPED, THE PROPOSED PAD AND BASEMENT AREA CAN BE EXCAVATED. THE TOP 8 INCHES OF THE BASEMENT AND GARAGE SUBGRADE SOIL SHOULD BE SCARIFIED, WATERED OR AERATED AS NECESSARY TO BRING THE SOIL TO ABOUT 2 PERCENT ABOVE THE OPTIMUM MOISTURE CONTENT, THE SUBGRADE SHOULD THEN BE UNIFORMLY RECOMPACTED TO AT LEAST 90 PERCENT RELATIVE COMPACTION. RELATIVE COMPACTION IS BASED ON THE MAXIMUM DRY DENSITY AS DETERMINED BY ASTM D1557 LATEST VERSION LABORATORY TEST PROCEDURE.



**CONSTRUCTION NOTES:**

- GRAVEL BASIN 10'X5'X2' (SEE DETAIL 2 ON SHEET C005)
- PERVIOUS CONCRETE DRIVEWAY (SEE DETAIL 4 ON SHEET C005)
- RETAINING WALL (SEE STRUCTURAL PLAN)
- INSTALL 4" (SDR-35 PVC) NON-PERFORATED PIPE
- INSTALL 4" (SDR-35 PVC) PERFORATED SUBDRAIN PIPE (SEE DETAIL 5 ON SHEET C005 FOR SUBDRAIN PIPE BEHIND WALL)
- INSTALL STANDARTPARK CATCH BASIN OR APPROVED EQUAL (SEE DETAIL 1 ON SHEET C005)
- CONSTRUCT GRAVEL SWALE (SEE DETAIL 3 ON SHEET C005)
- CONNECT DOWNSPOUT FROM ROOF TO UNDERGROUND STORM DRAIN PIPE (SEE DETAIL 7 ON SHEET C005)
- SUBDRAIN PIPE TO BE CONNECTED TO CLEAN OUT RISER THAT EXTEND TO SURFACE (SEE DETAIL 6 ON SHEET C005)
- PERMEABLE WOOD DECK (SEE ARCHITECTURE'S PLANS)
- FILL CATCH POINT
- 1' SAWCUT & CONFORM
- CONSTRUCT DRIVEWAY APPROACH (SEE SAN MATEO COUNTY Std DETAILS D-1)
- CONSTRUCT SIDEWALK, CURB & GUTTER AND TRANSITION TO EXISTING (SEE SAN MATEO COUNTY Std DETAILS D-3)
- CUT DAYLIGHT
- CONNECT SUBDRAIN PIPES TO CATCH BASIN



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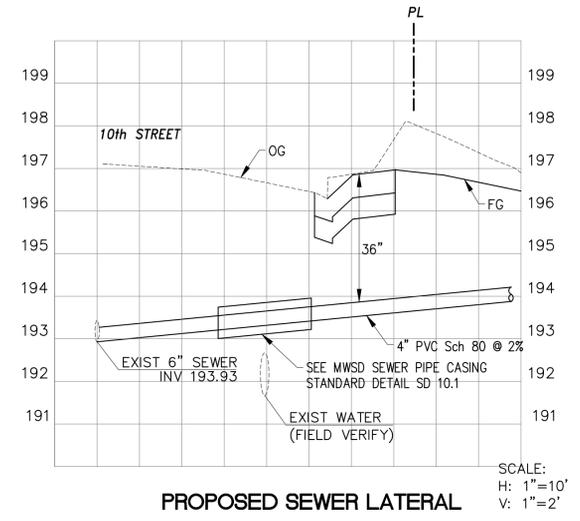
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APN: 036-031-280  
PROJECT ADDRESS: 340 10th Street, Montara, CA 94307  
PROJECT PHASE: **100% Schematic Design**  
DRAWN: CK CHECKED: CK  
ISSUE DATE: November 02, 2021  
DRAWING TITLE: GRADING AND DRAINAGE PLAN  
DRAWING NO: **C002**

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CONSTRUCTION NOTES:

- 1 TIE INTO EXISTING SEWER MAIN (SEE MWSD TYPICAL SIDE SEWER DETAIL SD-5)
- 2 TIE INTO EXISTING WATER MAIN (SEE MWSD 1" METERED SERVICE INSTALLATION DETAIL SD-01)
- 3 4" SEWER LATERAL PVC Sch 80 (MINIMUM 18" COVER, SEE PROFILE)
- 4 UNDERGROUND JOINT UTILITY LINE (FOR INFORMATION ONLY, SEE UTILITY COMPANIES PLANS)
- 5 DOMESTIC SERVICE POINT OF ENTRY
- 6 JOINT UTILITY LINE POINT OF ENTRY
- 7 SEWER LATERAL POINT OF ENTRY
- 8 TYPE K COPPER TUBING 1" DOMESTIC WATER LINE (MINIMUM 36" COVER)
- 9 INSTALL 1" WATER METER (SEE MWSD 1" METERED SERVICE INSTALLATION DETAIL SD-01)
- 10 INSTALL TYPE "A" BACKWATER PREVENTION DEVICE (SEE MWSD STANDARD CLEANOUT & BACKWATER PREVENTION DEVICE STANDARD DETAIL SD-6)




PROPOSED SEWER LATERAL  
SCALE:  
H: 1"=10'  
V: 1"=2'

SANITARY SEWER SYSTEMS CONSTRUCTION NOTES:

1. IT IS THE RESPONSIBILITY OF THE PROPERTY OWNER OR HIS CONTRACTOR TO LOCATE AND UNCOVER THE LATERAL STUB OR WYE INSTALLED TO SERVE THE PROPERTY. WHEN THE LATERAL STUB OR WYE CANNOT BE LOCATED, EVEN THOUGH THE DISTRICT'S RECORDS INDICATE SUCH A CONNECTION EXISTS, THE LATERAL SEWER MUST BE CONNECTED TO THE MAIN SEWER AT A LOCATION DESIGNATED BY THE DISTRICT AT THE EXPENSE OF THE PROPERTY OWNER AS REQUIRED IN SECTION 3-10 OF THIS SPECIFICATION. THE DISTRICT DOES NOT GUARANTEE THE PRESENCE OR LOCATION OF LATERAL STUBS OR WYES.
2. LATERAL SEWERS MUST BE LAID BY THE SHORTEST ROUTE FROM THE BUILDING PLUMBING OUTLET TO CONNECT TO THE MAIN SEWER AND MUST BE PERPENDICULAR TO THE PUBLIC RIGHT-OF-WAY WHEN POSSIBLE. ALL PIPES MUST BE LAID TO LINE AND GRADE. EACH LENGTH OF PIPE MUST BE LAID ON A FIRM BED AS DETAILED IN STANDARD DRAWING SD-4. AND MUST HAVE FULL BEARING FOR ITS ENTIRE LENGTH BETWEEN BELLS. WHEN APPLICABLE, AN ADEQUATE BELL HOLE MUST BE DUG AT THE END OF EACH PIPE LENGTH FOR MAKING THE JOINT. BLOCKING UNDER THE LATERAL SEWER WILL NOT BE PERMITTED. THE INSIDE EDGE OF ANY CUT PIPE MUST BE BEVELED, AND BOTH BELL AND SPIGOT MUST BE MARKED FOR PROPER INSPECTION AND CLEANED BEFORE THE JOINT IS MADE. CARE MUST BE TAKEN TO PREVENT FOREIGN MATERIALS FROM ENTERING THE PIPE. WATER MUST BE PUMPED FROM THE TRENCH WHILE THE PIPES ARE LAID AND THE JOINTS MADE. BACKFILL MUST BE CAREFULLY AND UNIFORMLY PLACED AROUND THE PIPE, WITH NO ROCKS OR CLODS TOUCHING THE PIPE. IN ROCKY AREAS, IMPORTED BEDDING MATERIAL MAY BE REQUIRED. PIPE MUST NOT BE COVERED UNTIL INSPECTED BY A DISTRICT REPRESENTATIVE.
3. PRIOR TO BACKFILLING, LATERAL SEWER INSTALLATIONS AND MODIFICATIONS MUST BE INSPECTED BY A DISTRICT REPRESENTATIVE OR ENGINEER (REPRESENTATIVE). WHEN REQUIRED, TESTS FOR WATERTIGHTNESS MUST BE DONE IN THE PRESENCE OF A DISTRICT REPRESENTATIVE. CONNECTIONS TO THE MAIN SEWER MUST BE DONE IN THE PRESENCE OF A DISTRICT REPRESENTATIVE. INSPECTIONS MUST BE SCHEDULED WITH THE DISTRICT GIVING THREE WORKING DAYS ADVANCE NOTICE. INSPECTIONS ARE NOT MADE ON SATURDAYS, SUNDAYS, OR HOLIDAYS.
4. EXCAVATION AND BACKFILLING. TRENCHES FOR LATERAL SEWERS WITHIN PUBLIC STREETS MUST BE EXCAVATED AND BACKFILLED AND THE PAVEMENT RESTORED IN STRICT ACCORDANCE WITH THE LAWS, ORDINANCES, AND REGULATIONS OF THE STATE OF CALIFORNIA, SAN MATEO COUNTY AND/OR AGENCY HAVING JURISDICTION OVER SAID STREET. THE DISTRICT, CITY AND/OR COUNTY RESERVES THE RIGHT TO REQUIRE COMPACTION TESTS ON TRENCH BACKFILL BY A SOILS ENGINEER. THE COST OF COMPACTION TESTS MUST BE PAID BY THE CONTRACTOR OR PROPERTY OWNER.
5. IMPERVIOUS CLAY TRENCH PLUGS MUST BE CONSTRUCTED IN THE PIPE ZONE BACKFILL AT INTERVALS OF APPROXIMATELY FIFTY (50) FEET, OR AS OTHERWISE DIRECTED BY A DISTRICT. IMPERVIOUS CLAY TRENCH PLUGS MUST: A) CONSIST OF DENSE CLAY MATERIAL FREE OF ROCKS AND VEGETATION, AND B) BE MOISTURE-CONDITIONED AND MECHANICALLY COMPACTED TO THE SAME DENSITY AS THE ADJOINING BACKFILL MATERIAL.
6. TRENCHES IN GROUND SLOPING GREATER THAN FIFTY PERCENT (50%) FROM THE HORIZONTAL MUST BE PROTECTED FROM EROSION BY PLACING RIP-RAP IN CEMENT MORTAR OR CONCRETE LAID FLUSH WITH THE SLOPE OVER THE BACKFILLED TRENCH, OR OTHER PROTECTIVE MEASURES MUST BE TAKEN AS DIRECTED BY A SOILS ENGINEER AND APPROVED BY THE DISTRICT. DRAINS WHICH ARE TWO INCHES IN DIAMETER MUST BE INSTALLED IN THE CONCRETE COVERING AT FIVE-FOOT INTERVALS ALONG THE TRENCH LINE. FOR TRENCHES IN SLOPES LESS THAN FIFTY PERCENT (50%) THE DISTRICT MAY REQUIRE THE USE OF REDWOOD TRENCH DAMS OR OTHER TYPES OF EROSION CONTROL.
7. UNLESS OTHERWISE DIRECTED BY THE DISTRICT, LATERAL SEWERS MUST BE TESTED BY PLUGGING AND FILLING WITH EITHER WATER OR COMPRESSED AIR TO FOUR (4) PSI, IN ACCORDANCE WITH THE DISTRICT STANDARD SEWER SPECIFICATIONS. FOR WATER TESTS, LEAKAGE MUST NOT EXCEED 20 GALLONS PER DAY PER INCH OF INTERNAL DIAMETER PER MILE OF SEWER LINE BEING TESTED (0.07 GALLONS PER HOUR PER 100 FEET OF 4-INCH DIAMETER PIPE). FOR AIR TESTS, THE PRESSURE MUST NOT DROP MORE THAN ONE PSI OVER A THREE-MINUTE PERIOD. TESTS MUST BE PERFORMED IN THE PRESENCE OF A DISTRICT REPRESENTATIVE.
8. PRESSURE SEWERS MUST BE TESTED UNDER A PRESSURE OF NOT LESS THAN 50 PSI WITHOUT LEAKAGE FOR A PERIOD OF FIFTEEN MINUTES. AIR TESTING IS NOT ALLOWED.
9. WHEN ENCOUNTERING SPECIAL CONDITIONS WHICH ARE NOT COVERED BY THE SPECIFICATIONS HEREIN OR THE DISTRICT STANDARD SPECIFICATIONS AND/OR CODE, A DISTRICT REPRESENTATIVE AND/OR THE DISTRICT ENGINEER WILL DIRECT THE CONTRACTOR OR PROPERTY OWNER IN THE REQUIRED PROCEDURES.

UTILITY NOTES:

1. UTILITY INFORMATION FROM PLANS AND MARKINGS WAS COMBINED WITH OBSERVED EVIDENCE OF UTILITIES FROM THE FIELD AND COUNTY/DISTRICT RECORDS TO DEVELOP A VIEW OF THE UNDERGROUND UTILITIES SHOWN HEREIN.
2. CONTRACTOR SHALL PROTECT EXISTING UTILITIES NOT DEEMED FOR REMOVAL.
3. ALL UTILITIES SHALL BE FURNISHED AND INSTALLED PER THE REQUIREMENTS OF THE SPECIFICATIONS, AND STANDARD DETAILS FROM MONTARA WATER AND SANITARY DISTRICT (MWSD).
4. ALL UTILITY PIPE BEDDING SHALL BE CONSTRUCTED PER THE REQUIREMENTS OF THE MONTARA WATER AND SANITARY DISTRICT (MWSD) STANDARD SPECIFICATIONS AND DETAILS.
5. ALL CONNECTIONS TO EXISTING UTILITIES SHALL BE PERFORMED PER THE REQUIREMENTS OF THE UTILITY DISTRICT. THE MONTARA WATER AND SANITARY DISTRICT ENGINEER MUST BE NOTIFIED AT LEAST 48 HOURS PRIOR TO ANY UTILITY WORK.
6. 24 HOURS NOTICE SHALL BE GIVEN TO THE UTILITY COMPANIES, AND THE DISTRICT, BEFORE THE BEGINNING OF ANY OPERATION INVOLVING THEIR FACILITIES OR SYSTEMS.
7. CONTRACTOR SHALL NOTIFY AND COORDINATE WITH THE APPROPRIATE UTILITY COMPANIES PRIOR TO THE REMOVAL OF INDICATED UTILITIES ON SITE. CONTRACTOR SHALL BE RESPONSIBLE FOR OBTAINING ANY PERMITS REQUIRED FOR DEMOLITION AND HAUL OFF FROM THE APPROPRIATE AUTHORITIES.
8. BUILDING CONTRACTOR SHALL BE RESPONSIBLE FOR COORDINATION WITH THE POWER COMPANY FOR THE INSTALLATION OF ELECTRICAL CONDUIT AND CONNECTION TO EXISTING POWER SOURCE.
9. ALL SURPLUS EXCAVATED MATERIAL FROM THE TRENCH SHALL BE DISPOSED OFF THE SITE BY CONTRACTOR.
10. COORDINATE EXACT TRENCHING, ROUTING, AND POINT OF TERMINATION WITH ALL UTILITY COMPANIES.
11. CONTRACTOR SHALL COORDINATE ANY DISRUPTIONS TO EXISTING UTILITY SERVICES WITH ADJACENT PROPERTY OWNERS.
12. ALL ELECTRIC, TV CABLE AND TELEPHONE SERVICE LINES SHALL BE INSTALLED ACCORDING TO THE APPROPRIATE UTILITY COMPANIES SPECIFICATIONS AS APPLICABLE.
13. ALL UTILITY DISCONNECTIONS SHALL BE COORDINATED WITH THE DESIGNATED UTILITY COMPANIES.
14. ALL TRENCH BACKFILL TO BE COMPACTED TO A MINIMUM OF 95 PERCENT OR AS INDICATED IN MWSD SPECIFICATIONS.
15. THE CONTRACTOR WILL BE RESPONSIBLE FOR PROVIDING AND MAINTAINING TRAFFIC CONTROL DEVICES SUCH AS BARRICADES, WARNING SIGNS, DIRECTIONAL SIGNS, FLAGMEN AND LIGHTS TO CONTROL THE MOVEMENT OF TRAFFIC WHERE NECESSARY. PLACEMENT OF THESE DEVICES SHALL BE APPROVED BY THE COUNTY ENGINEER PRIOR TO PLACEMENT. TRAFFIC CONTROL DEVICES SHALL CONFORM TO THE APPROPRIATE CALIFORNIA MUTCD (MANUAL ON UNIFORM TRAFFIC CONTROL DEVICES).
16. PRIOR TO INSTALLATION OF STORM OR SANITARY SEWER, WATER LATERAL OR ANY OTHER UTILITIES, THE CONTRACTOR SHALL EXCAVATE, VERIFY, AND DETERMINE ALL POINTS OF CONNECTION AND ALL UTILITY CROSSINGS AND INFORM THE OWNER AND THE ENGINEER OF ANY CONFLICTS OR REQUIRED DEVIATIONS FROM THE PLAN PRIOR TO CONSTRUCTION. NOTIFICATION SHALL BE MADE A MINIMUM OF 72 HOURS PRIOR TO CONSTRUCTION, THE ENGINEER AND ITS CLIENTS SHALL BE HELD HARMLESS IN THE EVENT THAT THE CONTRACTOR FAILS TO MAKE SUCH NOTIFICATION.
17. SEE UTILITY COMPANIES PLANS FOR ADDITIONAL INFORMATION.
18. NOTIFY UNDERGROUND SERVICE ALERT (USA) AT LEAST 48 HOURS PRIOR TO SITE WORK TO IDENTIFY LOCATION OF UNDERGROUND UTILITIES.

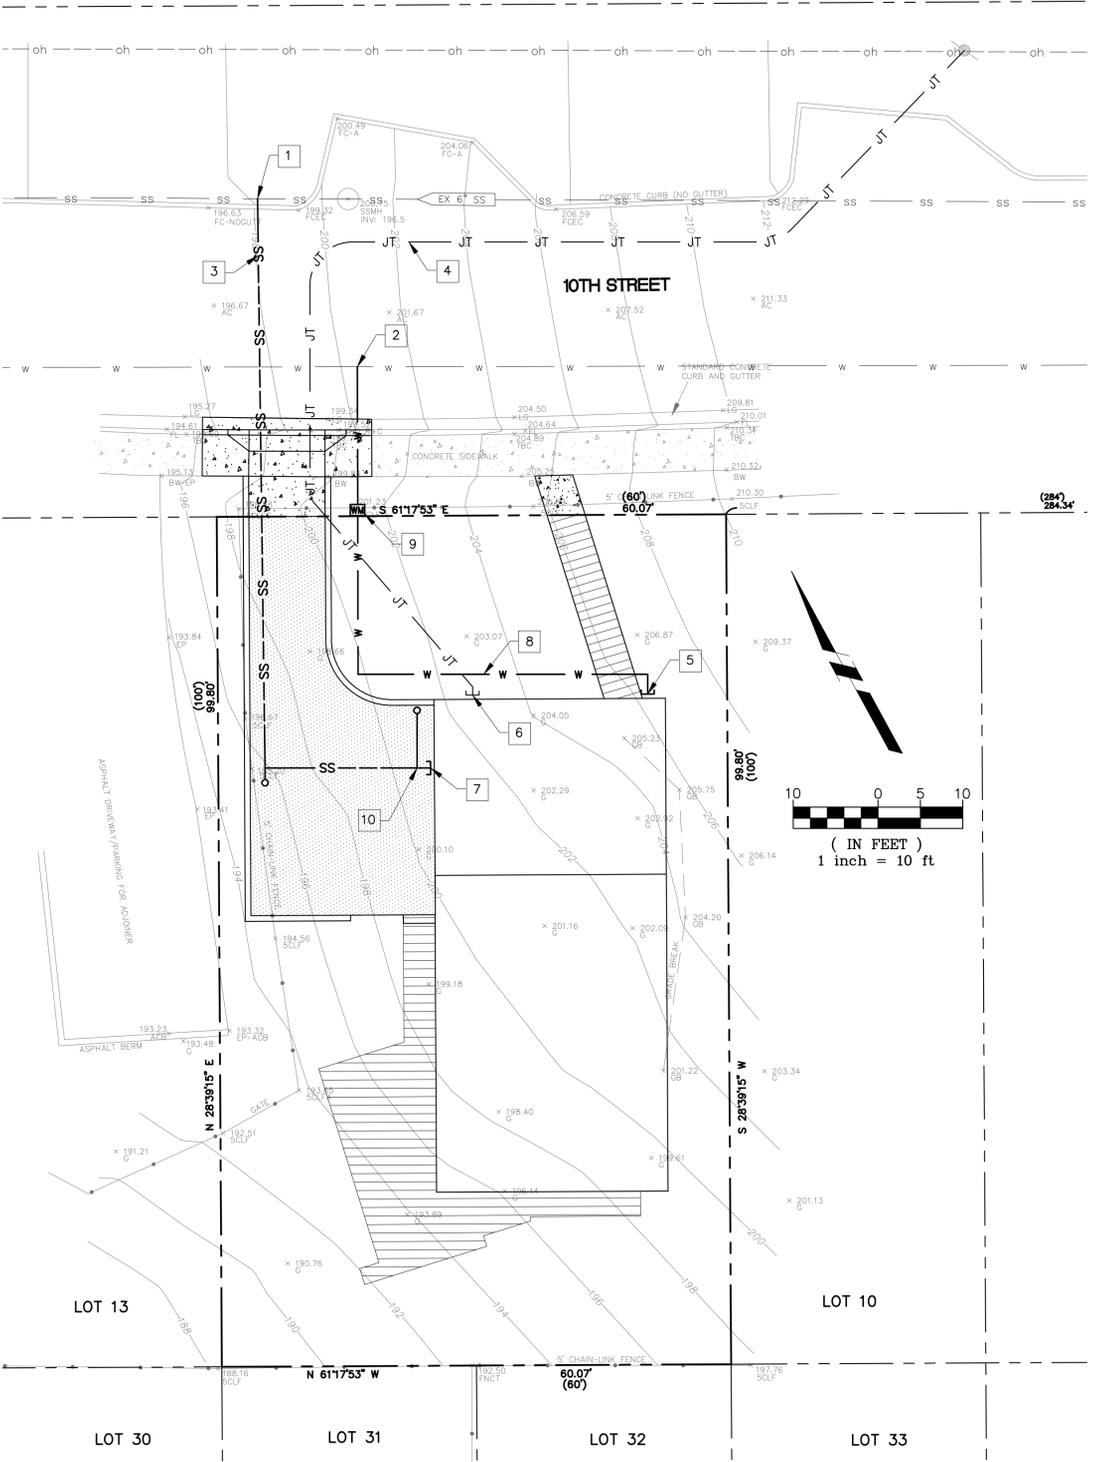

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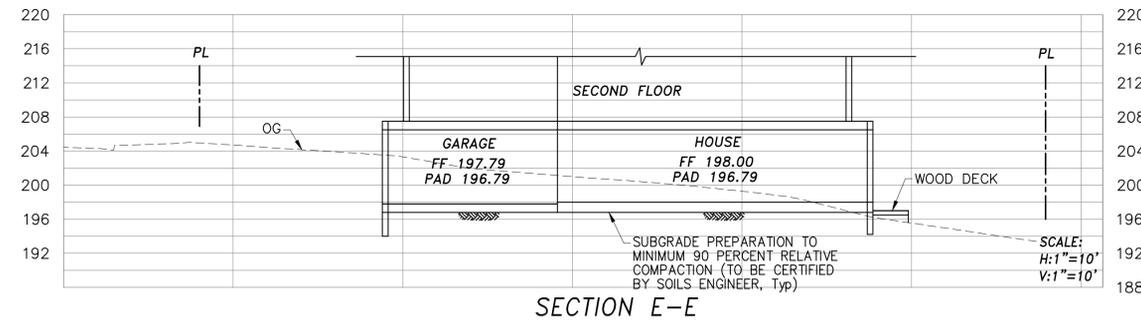
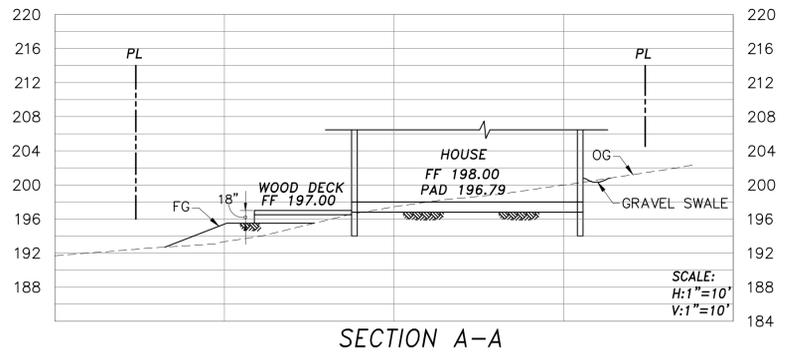
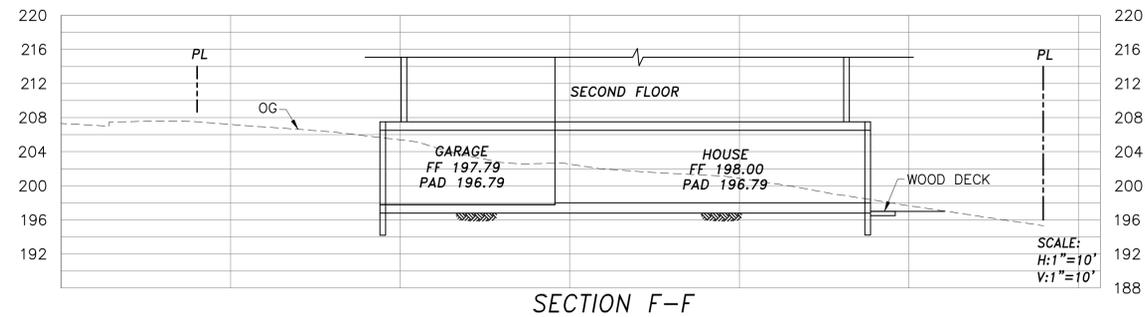
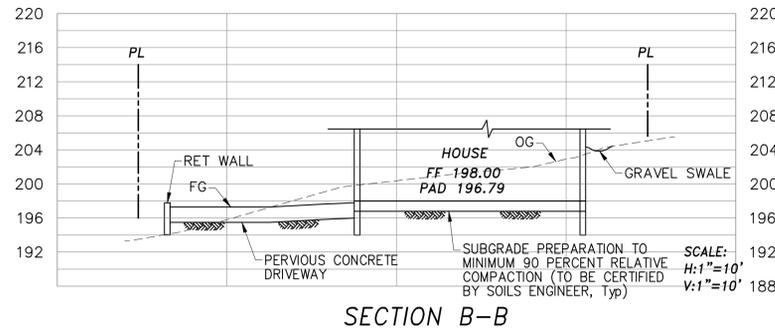
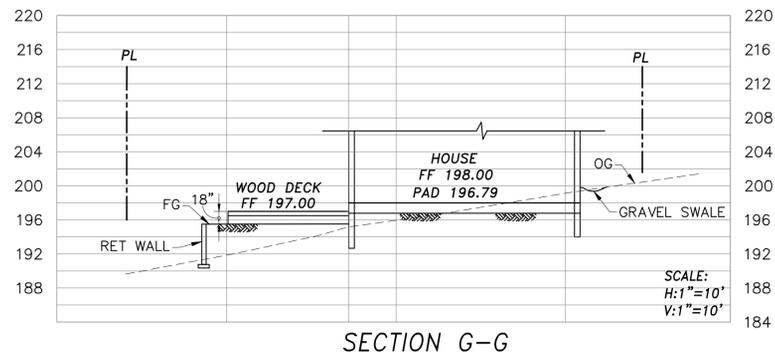
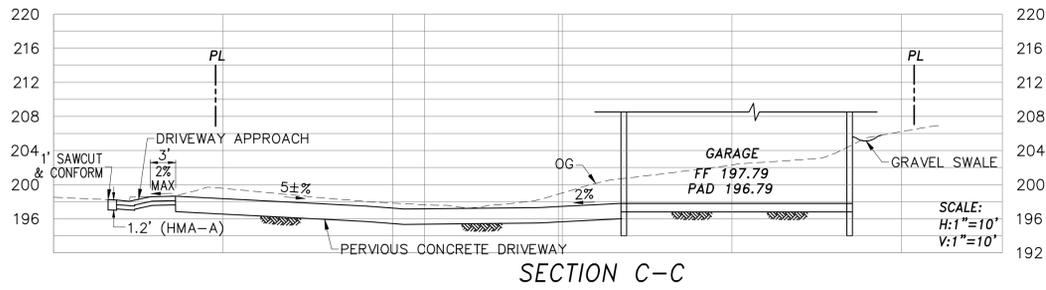
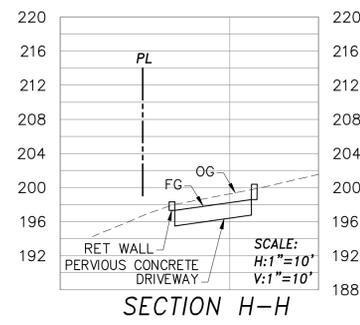
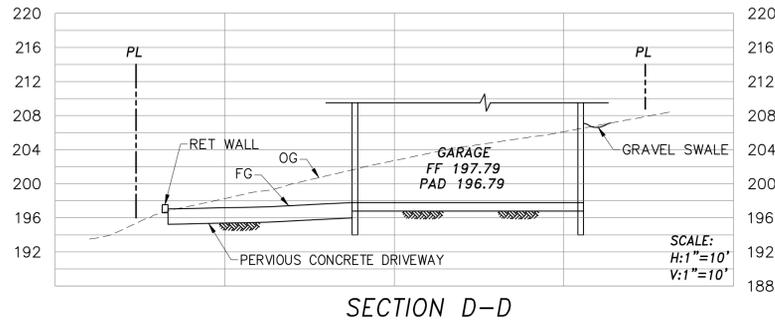


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DRAWN: CK CHECKED: CK  
ISSUE DATE: November 02, 2021  
DRAWING TITLE: UTILITY PLAN  
DRAWING NO: **C003**

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EMAIL: constructionsupport@designeverest.com




Know what's below.  
Call before you dig.


PROJECT NO: PROJECT NAME:  
**2101 House on a Hill**  
APN: 036-031-280  
PROJECT ADDRESS: 340 10th Street  
Montara, CA 94307  
PROJECT PHASE: **100% Schematic Design**  
DRAWN: CK CHECKED: CK  
ISSUE DATE: November 02, 2021  
DRAWING TITLE: CROSS SECTIONS  
DRAWING NO: **C004**

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REVISION:


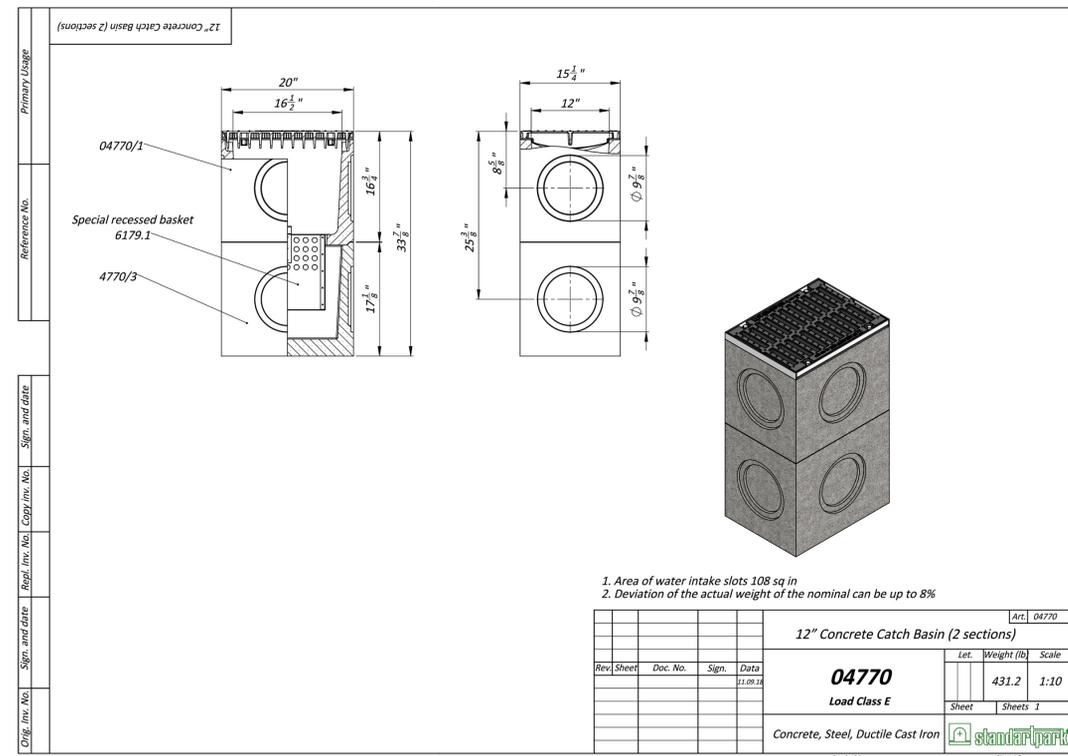


**CATCH BASIN**  
NO SCALE (1)



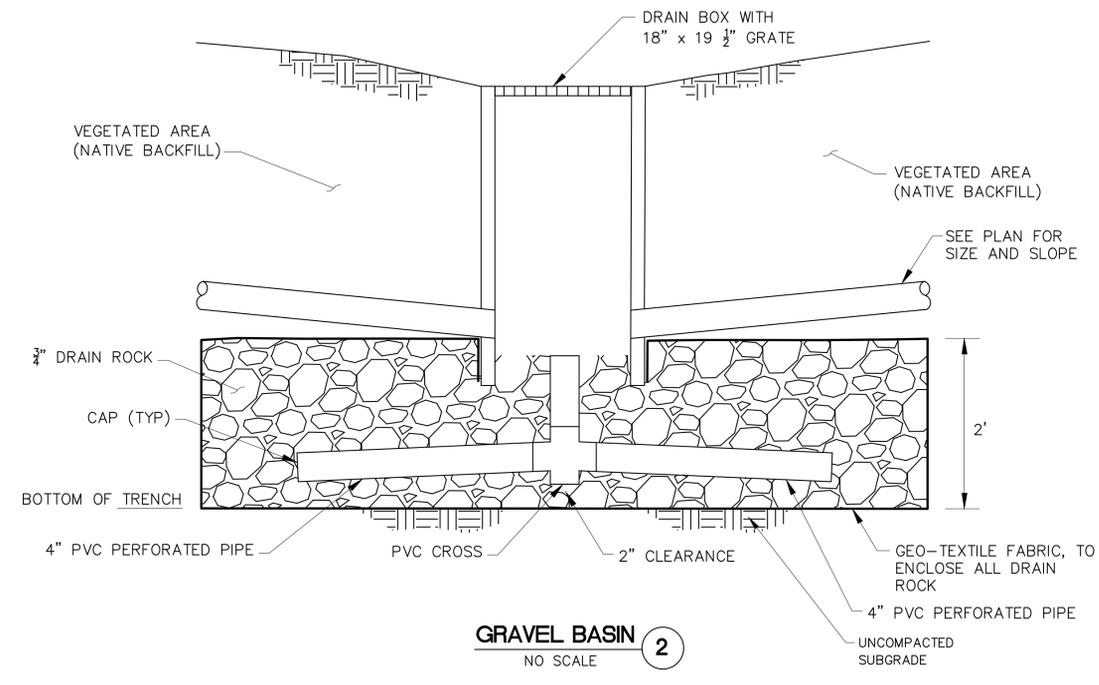


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NOTE: ALL PIPING USED SHOULD HAVE COUPLINGS THAT ARE GLUED OR HAVE RUBBER GASKET JOINTS TO ENSURE THAT THE PIPE SECTIONS WILL NOT SEPARATE.

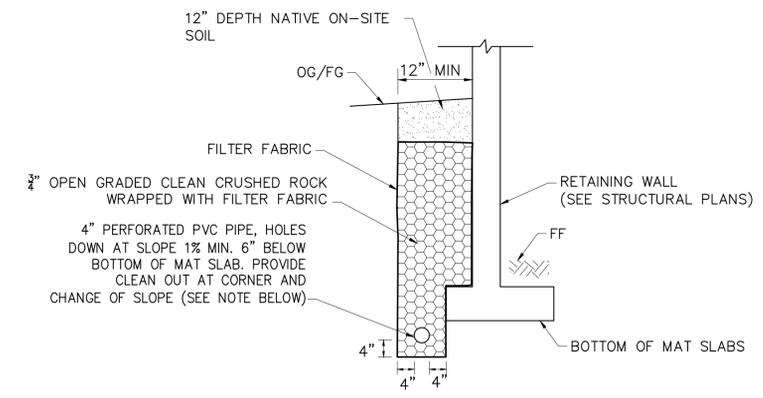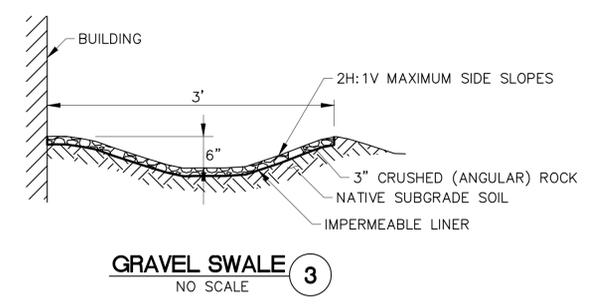

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**2101 House on a Hill**

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PROJECT ADDRESS: 340 10th Street  
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DRAWN: CK CHECKED: CK
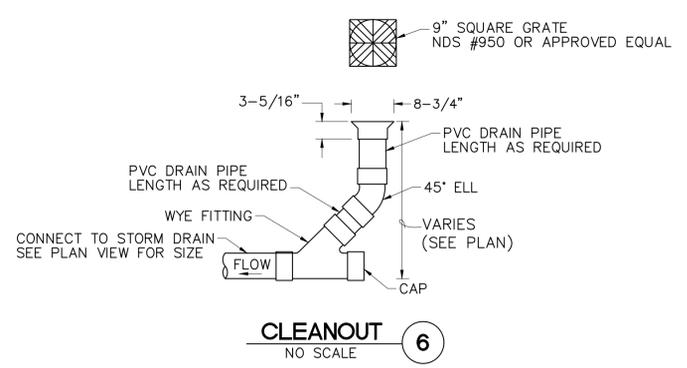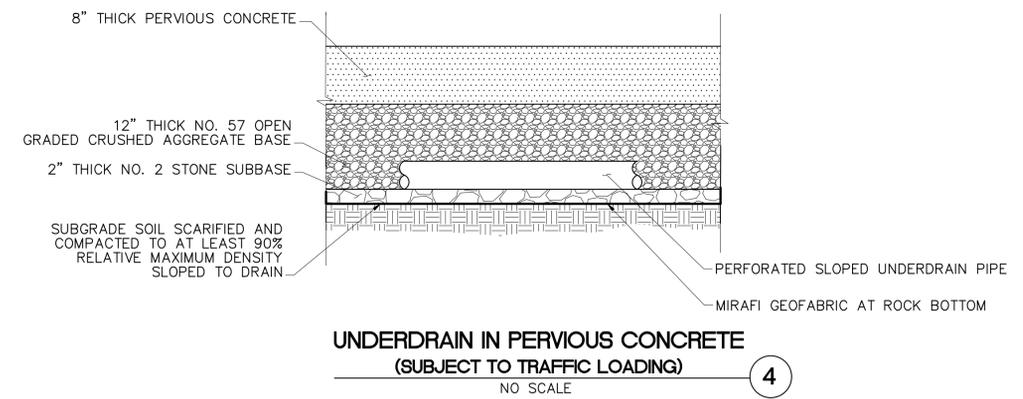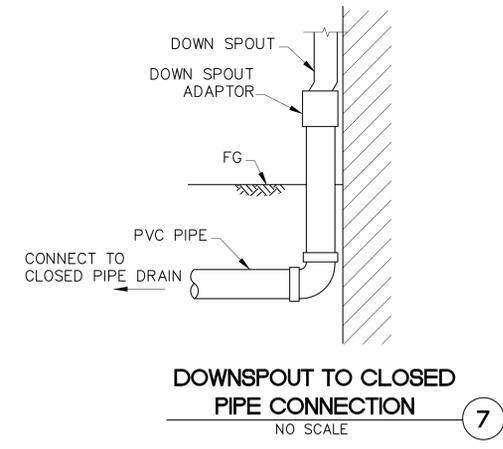
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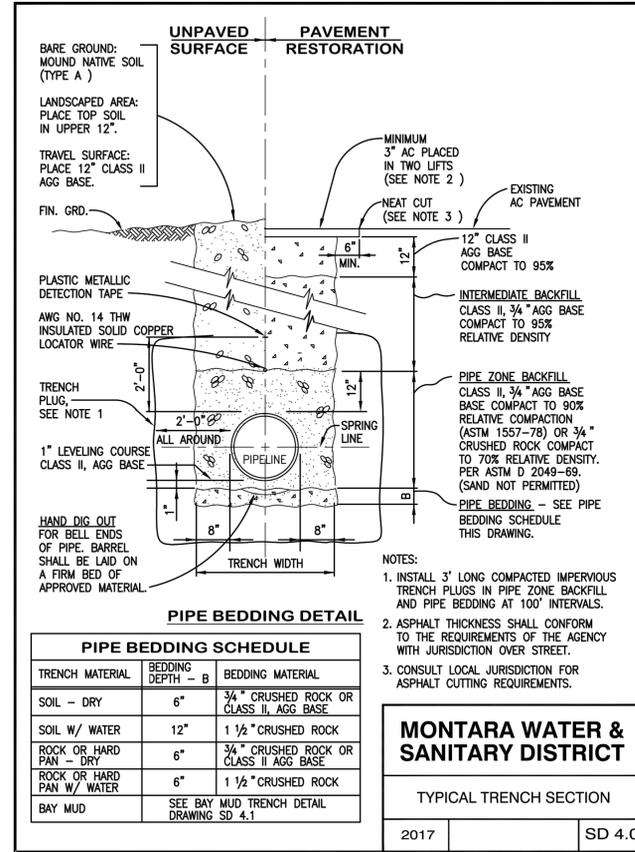
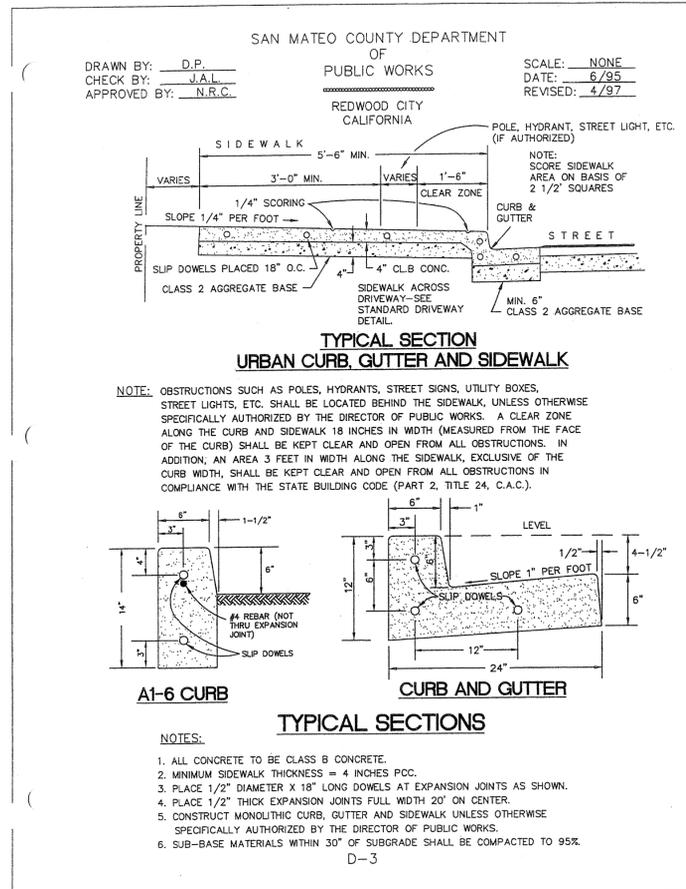
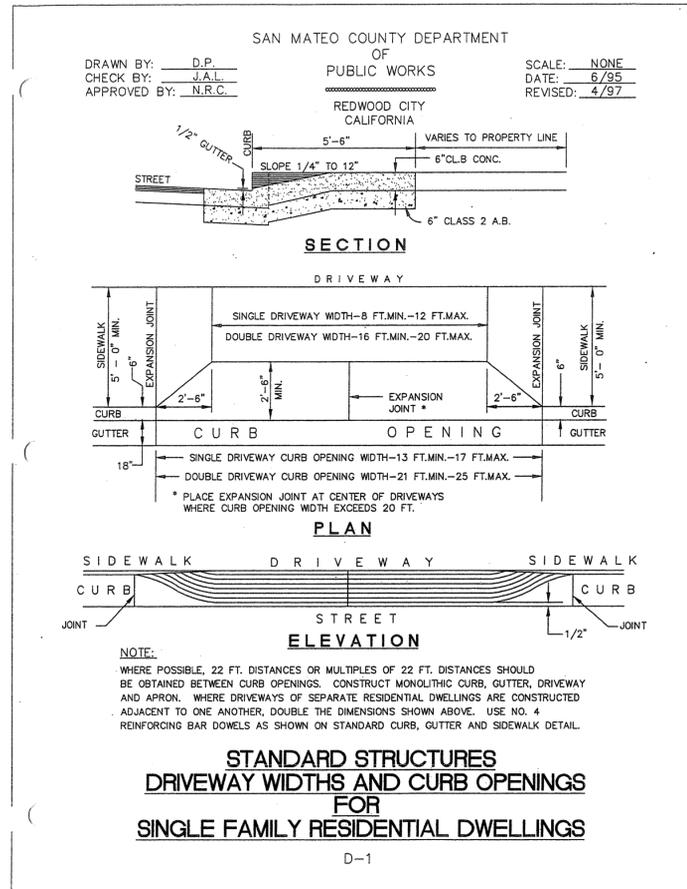
DRAWING TITLE: CONSTRUCTION DETAILS

DRAWING NO: **C005**

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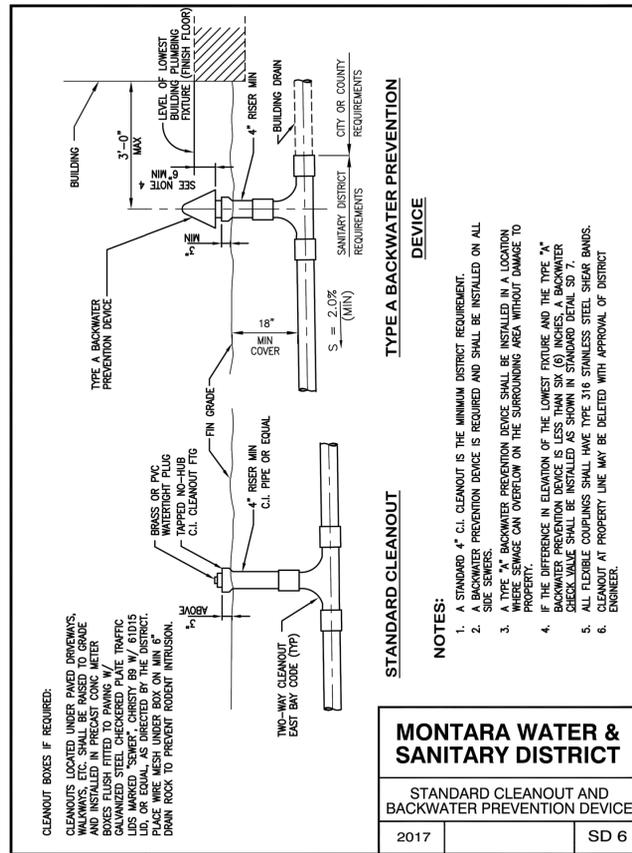
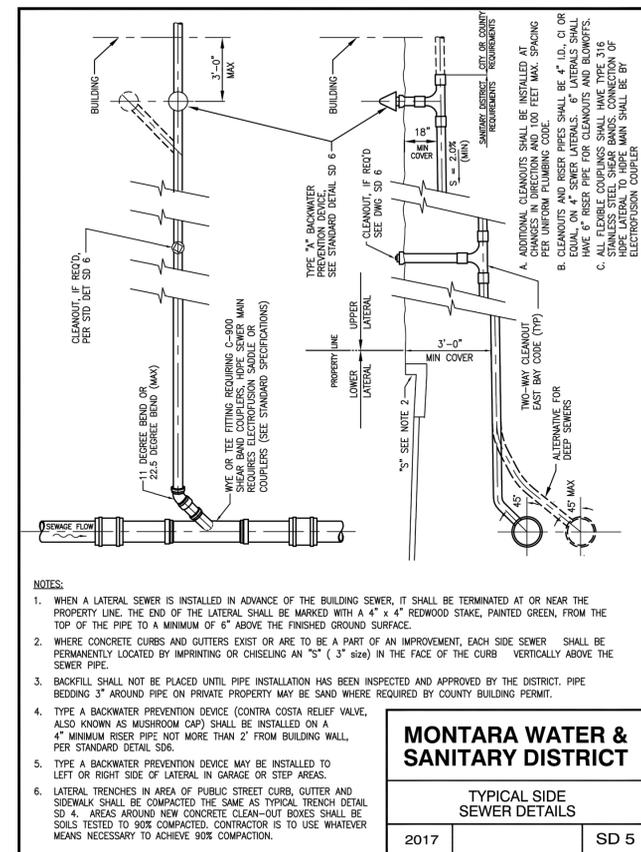


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**2101 House on a Hill**

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PROJECT PHASE: **100% Schematic Design**



DRAWN: CK CHECKED: CK

ISSUE DATE: November 02, 2021

DRAWING TITLE: CONSTRUCTION DETAILS


DRAWING NO: **C006**

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PROJECT NO: PROJECT NAME:  
**2101 House on a Hill**  
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 PROJECT PHASE: **100% Schematic Design**  
 DRAWN: CK CHECKED: CK  
 ISSUE DATE: November 02, 2021  
 DRAWING TITLE: CONSTRUCTION DETAILS  
 DRAWING NO: **C007**
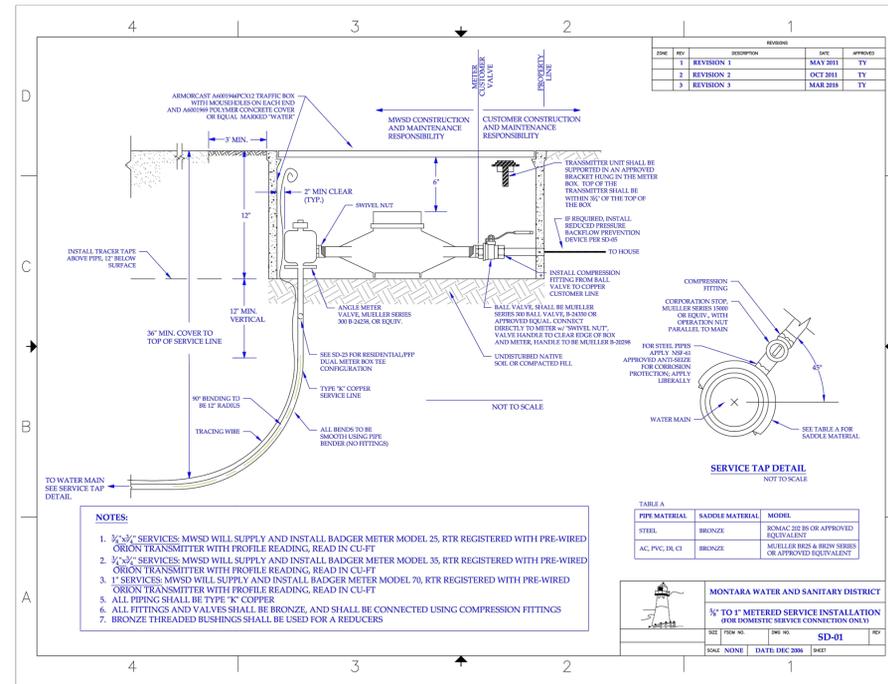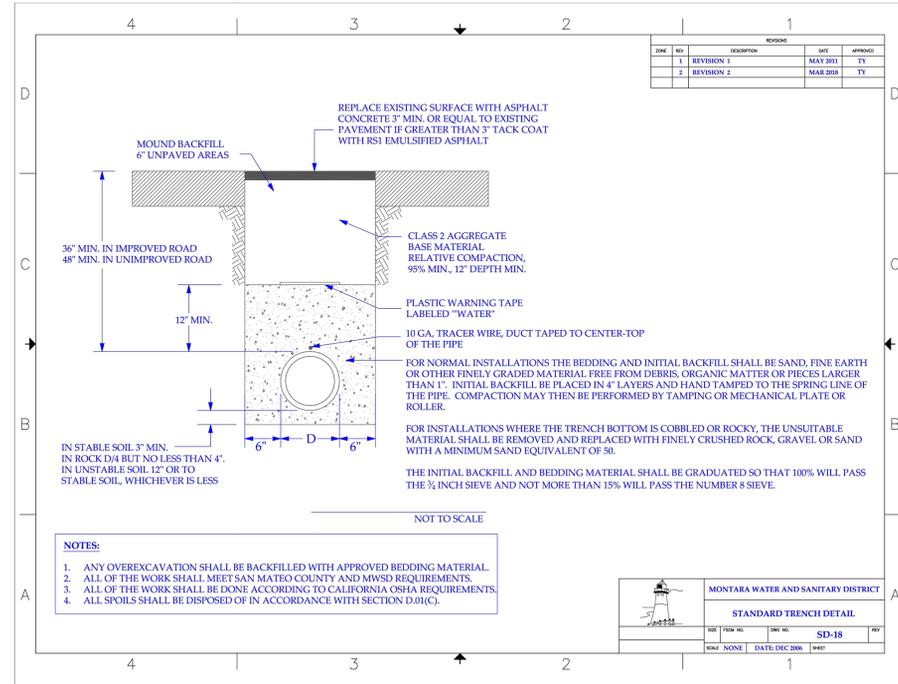
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**EROSION CONTROL NOTES:**

- A. ALL GRADING, EROSION AND SEDIMENT CONTROL AND RELATED WORK UNDERTAKEN ON THIS SITE IS SUBJECT TO ALL TERMS AND CONDITIONS OF THE CITY GRADING ORDINANCE AND MADE A PART HEREOF BY REFERENCE.
- B. THE CONTRACTOR WILL BE LIABLE FOR ANY AND ALL DAMAGES TO ANY PUBLICLY OWNED AND MAINTAINED ROAD CAUSED BY THE AFORESAID CONTRACTOR'S GRADING ACTIVITIES, AND SHALL BE RESPONSIBLE FOR THE CLEANUP OF ANY MATERIAL SPILLED ON ANY PUBLIC ROAD ON THE HAUL ROUTE.
- C. THE EROSION CONTROL MEASURES ARE TO BE OPERABLE DURING THE RAINY SEASON, OCTOBER FIRST TO APRIL FIFTEENTH. EROSION CONTROL PLANTING IS TO BE COMPLETED BY OCTOBER FIRST. NO GRADING OR UTILITY TRENCHING SHALL OCCUR BETWEEN OCTOBER FIRST AND APRIL FIFTEENTH UNLESS AUTHORIZED BY THE COUNTY ENGINEER.
- D. ALL EROSION CONTROL MEASURES SHALL BE MAINTAINED UNTIL DISTURBED AREAS ARE STABILIZED AND CHANGES TO THIS EROSION AND SEDIMENT CONTROL PLAN SHALL BE MADE TO MEET FIELD CONDITIONS ONLY WITH THE APPROVAL OF OR AT THE DIRECTION OF THE SOILS ENGINEER.
- E. ALL EROSION CONTROL FACILITIES MUST BE INSPECTED AND REPAIRED AT THE END OF EACH WORKING DAY DURING THE RAINY SEASON.
- F. A CONSTRUCTION ENTRANCE SHALL BE PROVIDED AT ANY POINT OF EGRESS FROM THE SITE TO ROADWAY. A CONSTRUCTION ENTRANCE SHOULD BE COMPOSED OF COARSE DRAIN ROCK (2" TO 3") MINIMUM DIAMETER AT LEAST EIGHT INCHES THICK BY FIFTY (50) FEET LONG BY TWENTY (20) FEET WIDE UNLESS SHOWN OTHERWISE ON PLAN AND SHALL BE MAINTAINED UNTIL THE SITE IS PAVED.
- G. WATER UTILIZED IN THE STABILIZATION MATERIAL SHALL BE OF SUCH QUALITY THAT IT WILL PROMOTE GERMINATION AND STIMULATE GROWTH OF PLANTS. IT SHALL BE FREE OF POLLUTANT MATERIALS AND WEED SEED.
- H. STABILIZATION MATERIALS SHALL BE APPLIED AS SOON AS PRACTICABLE AFTER COMPLETION OF GRADING OPERATIONS AND PRIOR TO THE ONSET OF WINTER RAINS, OR AT SUCH OTHER TIME AS DIRECTED BY THE CITY ENGINEER. THE MATERIAL SHALL BE APPLIED BEFORE INSTALLATION OF OTHER LANDSCAPING MATERIALS SUCH AS TREES, SHRUBS AND GROUND COVERS.
- I. THE STABILIZATION MATERIAL SHALL BE APPLIED WITHIN 4-HOURS AFTER MIXING, MIXED MATERIAL NOT USED WITHIN 4-HOURS SHALL BE REMOVED FROM THE SITE.
- J. THE CONTRACTOR SHALL MAINTAIN THE SOIL STABILIZATION MATERIAL AFTER PLACEMENT. THE CITY ENGINEER MAY REQUIRE SPRAY APPLICATION OF WATER OF OTHER MAINTENANCE ACTIVITIES TO ASSURE THE EFFECTIVENESS OF THE STABILIZATION PROCESS. APPLICATION OF WATER SHALL BE ACCOMPLISHED USING NOZZLES THAT PRODUCE A SPRAY THAT DOES NOT CONCENTRATE OR WASH AWAY THE STABILIZATION MATERIALS.
- K. THE FACILITIES SHOWN ON THIS PLAN ARE DESIGNED TO CONTROL EROSION AND SEDIMENT DURING THE RAINY SEASON. GRADING OPERATIONS DURING RAINY SEASON, WHICH LEAVE DENUDED SLOPES SHALL BE PROTECTED WITH EROSION CONTROL MEASURES IMMEDIATELY FOLLOWING GRADING OF THE SLOPES.
- L. CONSTRUCTION ENTRANCES SHALL BE INSTALLED PRIOR TO COMMENCEMENT OF GRADING. ALL CONSTRUCTION TRAFFIC ENTERING ONTO THE PAVED ROADS MUST CROSS THE STABILIZED CONSTRUCTION ENTRANCEWAYS.
- M. CONTRACTOR SHALL MAINTAIN STABILIZED ENTRANCE AT EACH VEHICLE ACCESS POINT TO EXISTING PAVED STREETS. ANY MUD OR DEBRIS TRACKED ONTO PUBLIC STREETS SHALL BE REMOVED DAILY AND AS REQUIRED BY THE COUNTY.
- N. WHEN NECESSARY, WHEELS SHALL BE CLEANED TO REMOVE SEDIMENT PRIOR TO ENTRANCE ONTO PUBLIC RIGHT-OF-WAY. WHEN WASHING IS REQUIRED, IT SHALL BE DONE ON AN AREA STABILIZED WITH CRUSHED STONE WHICH DRAINS INTO AN APPROVED SEDIMENT TRAP OR SEDIMENT BASIN. ALL SEDIMENT SHALL BE PREVENTED FROM ENTERING ANY STORM DRAIN, DITCH OR WATERCOURSE THROUGH USE OF SAND BAGS, GRAVEL, BOARDS, OR OTHER APPROVED METHODS.
- O. STRAW MULCH OR FIBER MATTE SHALL BE SUFFICIENTLY AVAILABLE ON-SITE DURING THE GRADING PERIOD READY TO BE INSTALLED ON FRESH SLOPES THAT MAY BE ERODED DURING STORMY WEATHER.
- P. INLET PROTECTION SHALL BE INSTALLED AT OPEN INLETS TO PREVENT SEDIMENT FROM ENTERING THE STORM DRAIN SYSTEM. INLETS NOT USED IN CONJUNCTION WITH EROSION CONTROL ARE TO BE BLOCKED TO PREVENT ENTRY OF SEDIMENT.
- Q. THIS EROSION AND SEDIMENT CONTROL PLAN MAY NOT COVER ALL THE SITUATIONS THAT MAY ARISE DURING CONSTRUCTION DUE TO UNANTICIPATED FIELD CONDITIONS. VARIATIONS AND ADDITIONS MAY BE MADE TO THIS PLAN IN THE FIELD. NOTIFY THE COUNTY REPRESENTATIVE OF ANY FIELD CHANGES.
- R. CLEANOUT THE CONCRETE DITCH AT COMPLETION OF THE PROJECT.
- S. SITE CLEARING AND EARTH-MOVING ACTIVITIES ARE ONLY ALLOWED DURING DRY WEATHER. EROSION AND SEDIMENTS CONTROL PRACTICES SHALL BE INSTALLED AND IMPLEMENTED PRIOR TO EARTH-MOVING ACTIVITIES AND CONSTRUCTION.

**MAINTENANCE NOTES:**

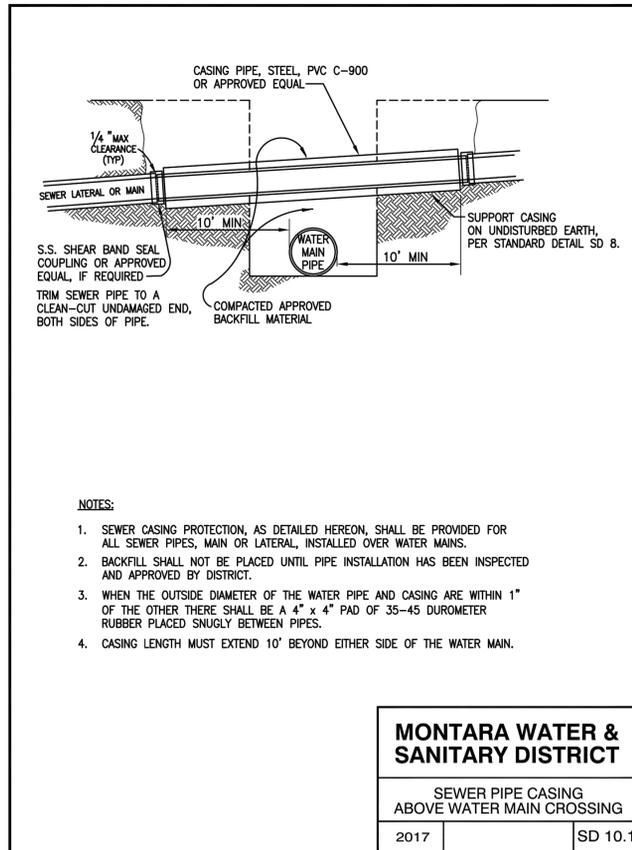- 1. REPAIR DAMAGES CAUSED BY SOIL EROSION OR CONSTRUCTION AT THE END OF EACH WORKING DAY.
- 2. SWALES SHALL BE INSPECTED PERIODICALLY AND MAINTAINED AS NEEDED.
- 3. SEDIMENT TRAPS, BERMS, AND SWALES ARE TO BE INSPECTED AFTER EACH STORM AND REPAIRS MADE AS NEEDED.
- 4. SEDIMENT SHALL BE REMOVED AND SEDIMENT TRAPS RESTORED TO ITS ORIGINAL DIMENSIONS WHEN SEDIMENT HAS ACCUMULATED TO A DEPTH OF ONE FOOT.
- 5. SEDIMENT REMOVED FROM TRAP SHALL BE DEPOSITED IN A SUITABLE AREA AND IN SUCH A MANNER THAT IT WILL NOT ERODE.
- 6. RILLS AND GULLIES MUST BE REPAIRED.

**NON-STORM WATER MANAGEMENT**

- 1. CONTRACTOR SHALL IMPLEMENT MEASURES TO CONTROL ALL NON-STORM WATER DISCHARGES DURING CONSTRUCTION.
- 2. CONTRACTOR SHALL WASH VEHICLES IN SUCH A MANNER AS TO PREVENT NON-STORM WATER DISCHARGES TO SURFACE WATERS OR MS4 DRAINAGE SYSTEM.
- 3. CONTRACTOR SHALL CLEAN STREETS IN SUCH A MANNER AS TO PREVENT UNAUTHORIZED NON-STORM WATER DISCHARGES FROM REACHING SURFACE WATER OR MS4 DRAINAGE SYSTEMS.

**DUST CONTROL**

- 1. THE CONSTRUCTION ACTIVITIES WILL GENERATE DUST AND PARTICULATE MATTER. PRIOR TO THE ISSUANCE OF A GRADING PERMIT, A DUST MITIGATION PLAN SHALL BE SUBMITTED TO THE CITY FOR REVIEW AND APPROVAL. THE PLAN SHALL SPECIFY THE METHODS OF CONTROL THAT WILL BE UTILIZED, DEMONSTRATE THE AVAILABILITY OF NEEDED EQUIPMENT AND PERSONNEL, AND IDENTIFY A RESPONSIBLE INDIVIDUAL WHO CAN AUTHORIZE THE IMPLEMENTATION OF ADDITIONAL MEASURES, IF NEEDED. THE CONSTRUCTION DUST MITIGATION PLAN SHALL, AT MINIMUM, INCLUDE THE FOLLOWING:
  - A. THE PROVISION OF EQUIPMENT AND STAFFING FOR WATERING OF ALL EXPOSED OR DISTURBED SOIL SURFACES AT LEAST TWICE DAILY, INCLUDING WEEKENDS AND HOLIDAYS. AN APPROPRIATE DUST PALLIATIVE OR SUPPRESSANT ADDED TO WATER BEFORE THE APPLICATION SHOULD BE UTILIZED.
  - B. WATERING OR COVERING OF STOCKPILES OF DEBRIS, SOIL, SAND OR OTHER MATERIALS THAT CAN BE BLOWN BY THE WIND.
  - C. THE REGULAR SWEEPING OF CONSTRUCTION AREAS AND ADJACENT STREETS OF ALL MUD AND DEBRIS, SINCE THIS MATERIAL CAN BE PULVERIZED AND LATER RE-SUSPENDED BY VEHICLE TRAFFIC.
  - D. THE ENFORCEMENT OF A SPEED LIMIT OF 15 MILES PER HOUR FOR ALL CONSTRUCTION VEHICLES WHEN OFF-PAVEMENT.
  - E. ALL MATERIALS TRANSPORTED BY TRUCK WILL BE COVERED OR WETTED DOWN.
  - F. ALL INACTIVE PORTIONS OF THE SITE WILL BE WATERED WITH AN APPROPRIATE DUST SUPPRESSANT, COVERED OR SEEDED.
  - G. SUSPENSION OF EARTHMOVING OR OTHER DUST-PRODUCING ACTIVITIES DURING PERIODS OF HIGH WINDS WHEN DUST CONTROL MEASURES ARE UNABLE TO AVOID VISIBLE DUST PLUMES.
- 2. COUNTY INSPECTOR MAY ADD/MODIFY EROSION CONTROL MEASURES AS REQUIRED.


**HAZARDOUS MATERIALS AND WASTES MANAGEMENT:**

USE THIS BMP WHEN PROJECTS INVOLVE THE STORAGE AND USE OF HAZARDOUS MATERIALS, AND THE GENERATION OF WASTE BYPRODUCTS FROM THE FOLLOWING:

- PETROLEUM PRODUCTS SUCH AS OILS, FUELS, GREASES, COLD MIX AND TARS
- GLUES, ADHESIVES AND SOLVENTS
- HERBICIDES, PESTICIDES AND FERTILIZERS
- PAINTS, STAINS AND CURING COMPOUNDS
- OTHER HAZARDOUS OR TOXIC SUBSTANCES

**HAZARDOUS MATERIALS AND WASTES SHALL BE MANAGED IN ACCORDANCE WITH THE FOLLOWING PROCEDURES:**

- EARTH BERMS
- MINIMIZE THE AMOUNT OF HAZARDOUS MATERIALS STORED AT THE CONSTRUCTION SITE AND THE PRODUCTION AND GENERATION OF HAZARDOUS WASTE AT THE CONSTRUCTION SITE.
  - COVER OR CONTAINERIZE AND PROTECT FROM VANDALISM ANY HAZARDOUS MATERIALS AND WASTE.
  - CLEARLY MARK ALL HAZARDOUS MATERIALS AND WASTE. PLACE HAZARDOUS WASTE CONTAINERS IN SECONDARY CONTAINMENT SYSTEMS IF STORED AT THE CONSTRUCTION SITE.
  - STOCKPILED COLD MIX SHOULD BE PLACED ON AND COVERED WITH PLASTIC.
  - DO NOT MIX WASTE MATERIALS, BECAUSE THIS COMPLICATES OR INHIBITS DISPOSAL AND RECYCLING OPTIONS AND CAN RESULT IN DANGEROUS CHEMICAL REACTIONS.
  - STORM WATER THAT COLLECTS WITHIN SECONDARY CONTAINMENT STRUCTURES MUST BE INSPECTED PRIOR TO BEING DISCHARGED TO ENSURE NO POLLUTANTS ARE PRESENT. CONTAMINATED STORM WATER IS NOT ALLOWED TO BE DISCHARGED AND SHOULD BE DISPOSED OF IN ACCORDANCE WITH ALL APPLICABLE LAWS AND REGULATIONS.
  - SPILLS CANNOT BE DISCHARGED FROM A SECONDARY CONTAINMENT SYSTEM.
  - HAZARDOUS WASTE MUST BE SEGREGATED FROM OTHER SOLID WASTE AND DISPOSED OF PROPERLY.
  - IN ADDITION TO FOLLOWING THIS BMP, EMPLOYEES AND CONTRACTORS ARE RESPONSIBLE FOR COMPLIANCE WITH FEDERAL, STATE, AND LOCAL LAWS REGARDING STORAGE, HANDLING, TRANSPORTATION, AND DISPOSAL OF HAZARDOUS WASTE.

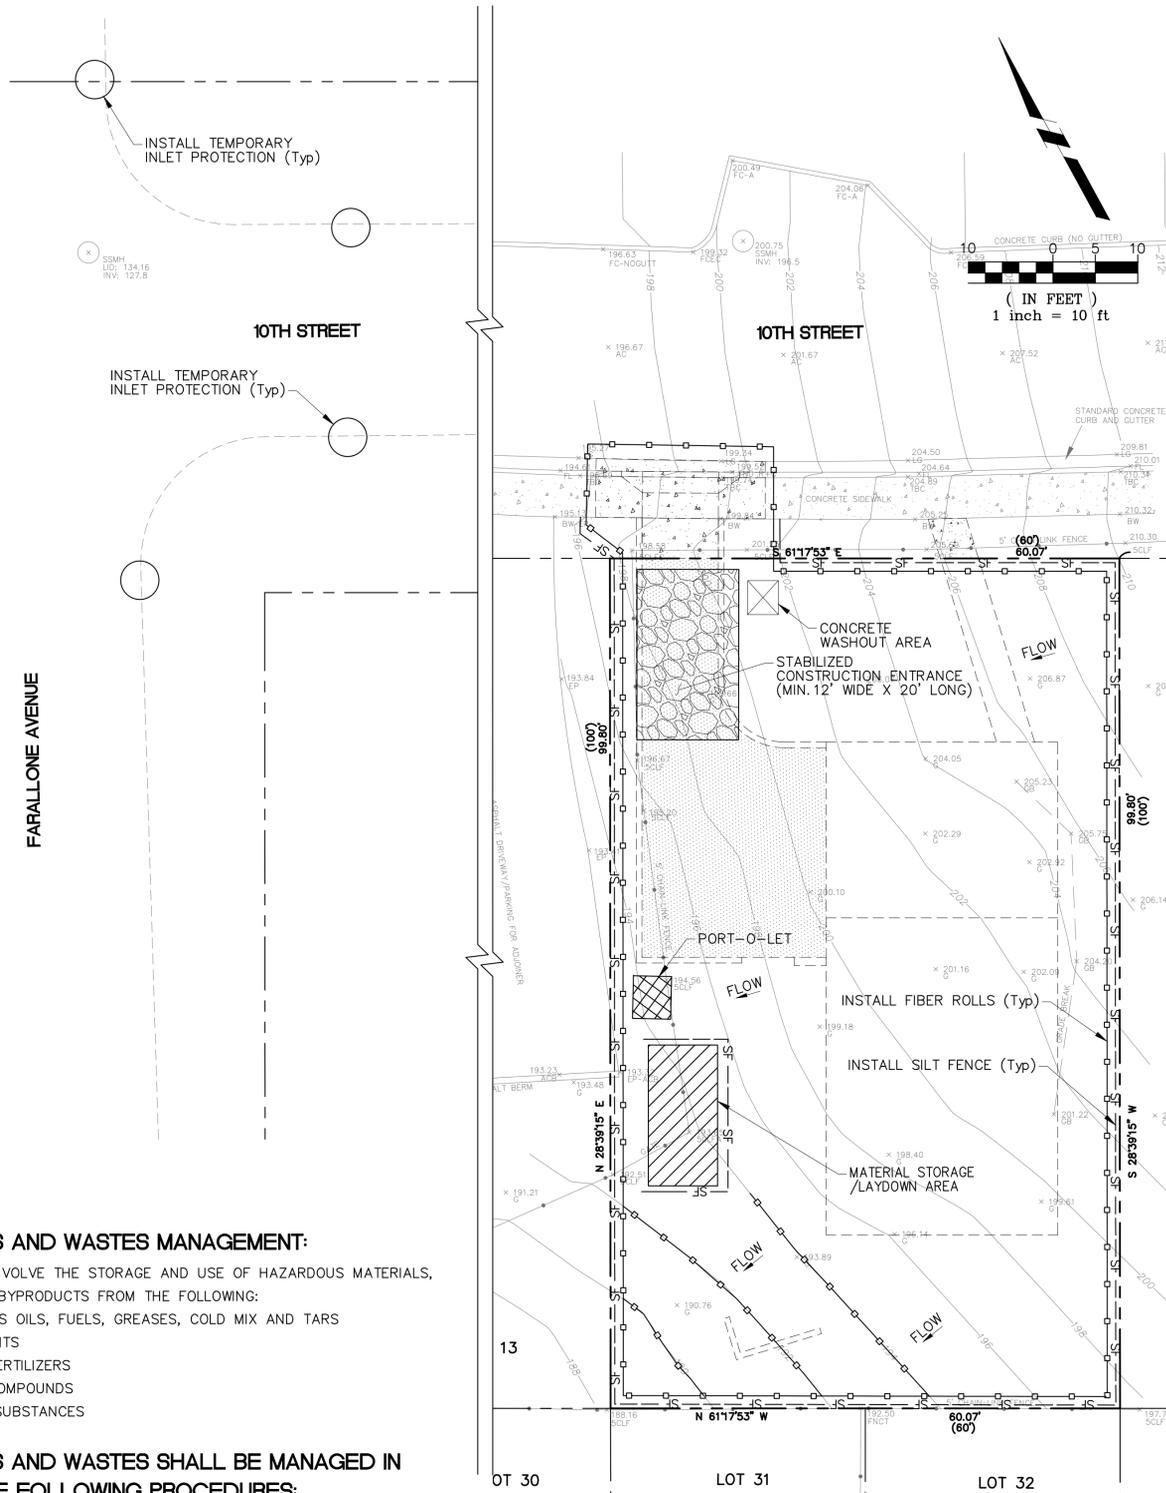

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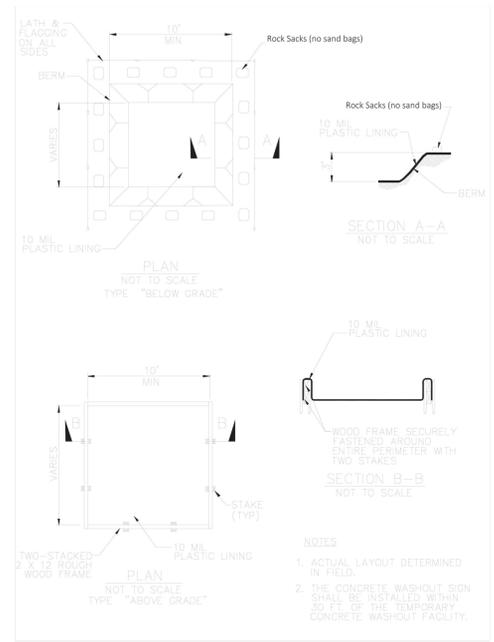
365 FLOWER LANE  
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PROJECT NO: PROJECT NAME:  
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APN: 036-031-280  
PROJECT ADDRESS: 340 10th Street, Montara, CA 94307  
PROJECT PHASE: **100% Schematic Design**  
DRAWN: CK CHECKED: CK  
ISSUE DATE: November 02, 2021  
DRAWING TITLE: EROSION AND SEDIMENT CONTROL PLAN  
DRAWING NO: **C008**


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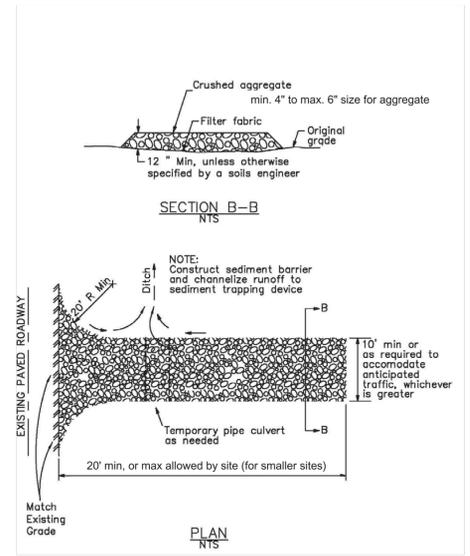
**Concrete Waste Management WM-8**




**Fiber Rolls SE-5**




**Stabilized Construction Entrance/Exit TC-1**

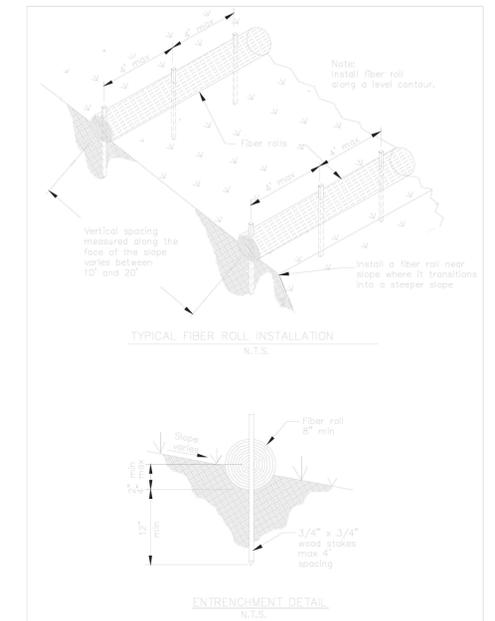


**Stockpile Management (SP)**

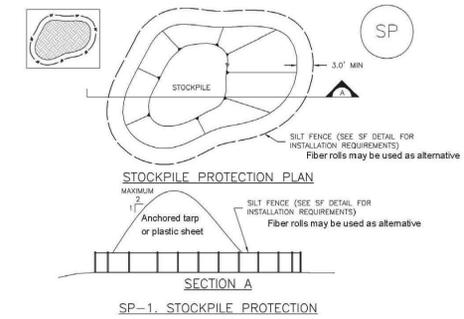


**SE-1 Silt Fence**

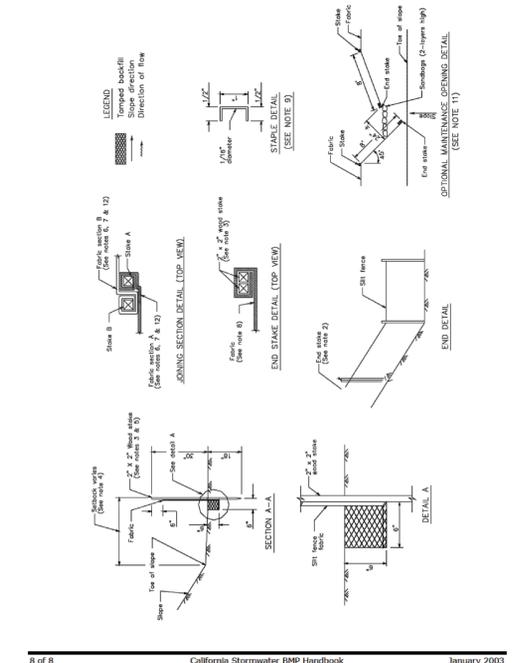



**Storm Drain Inlet Protection SE-10**

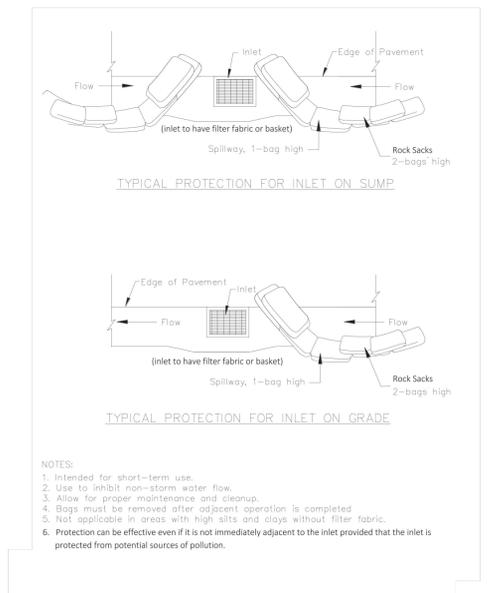

**Storm Drain Inlet Protection SE-10**

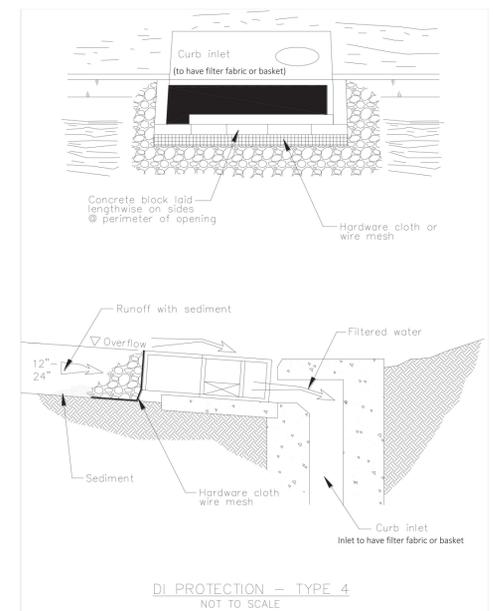

**Silt Fence SE-1**

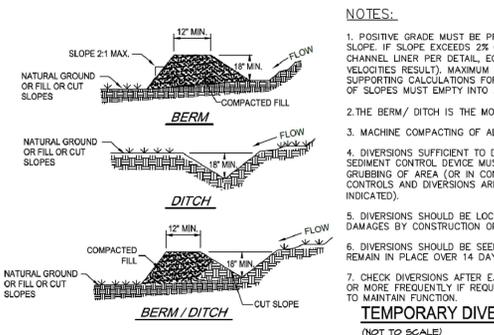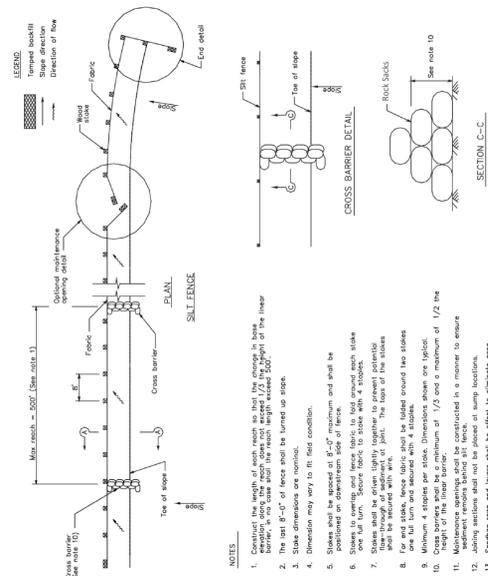

**TEMPORARY DIVERSION BERM / DITCH (NOT TO SCALE)**

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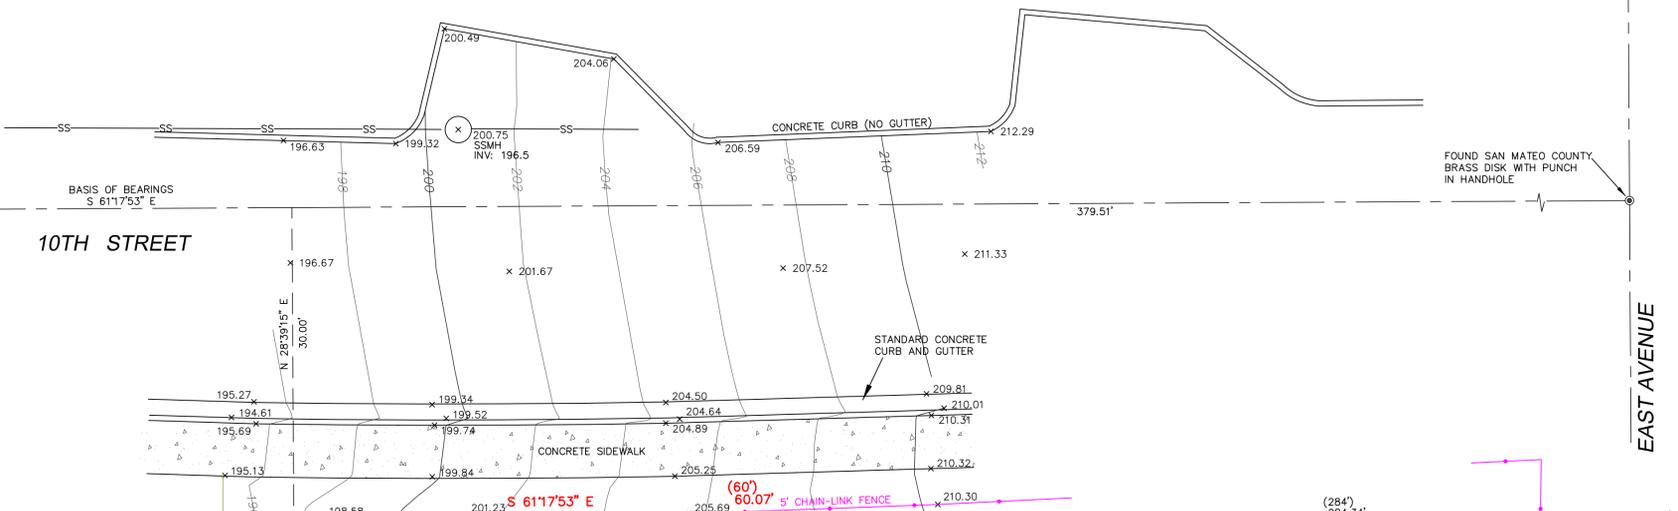
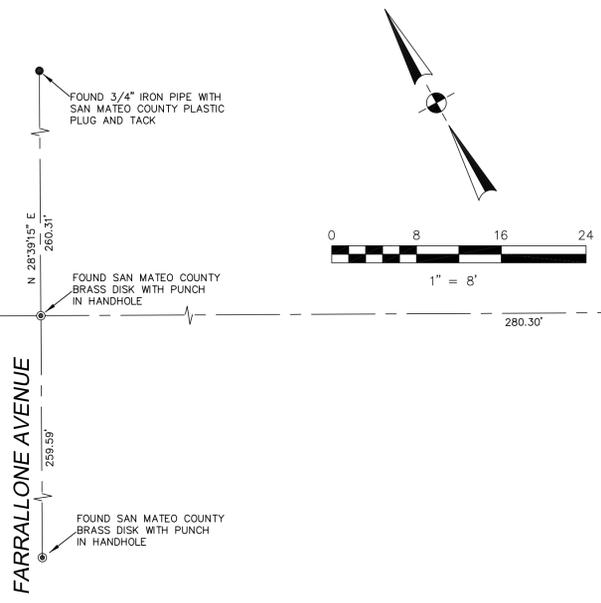
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PROJECT PHASE: **100% Schematic Design**  
DRAWN: CK CHECKED: CK  
ISSUE DATE: November 02, 2021  
DRAWING TITLE: EROSION AND SEDIMENT CONTROL DETAILS  
DRAWING NO: **C009**

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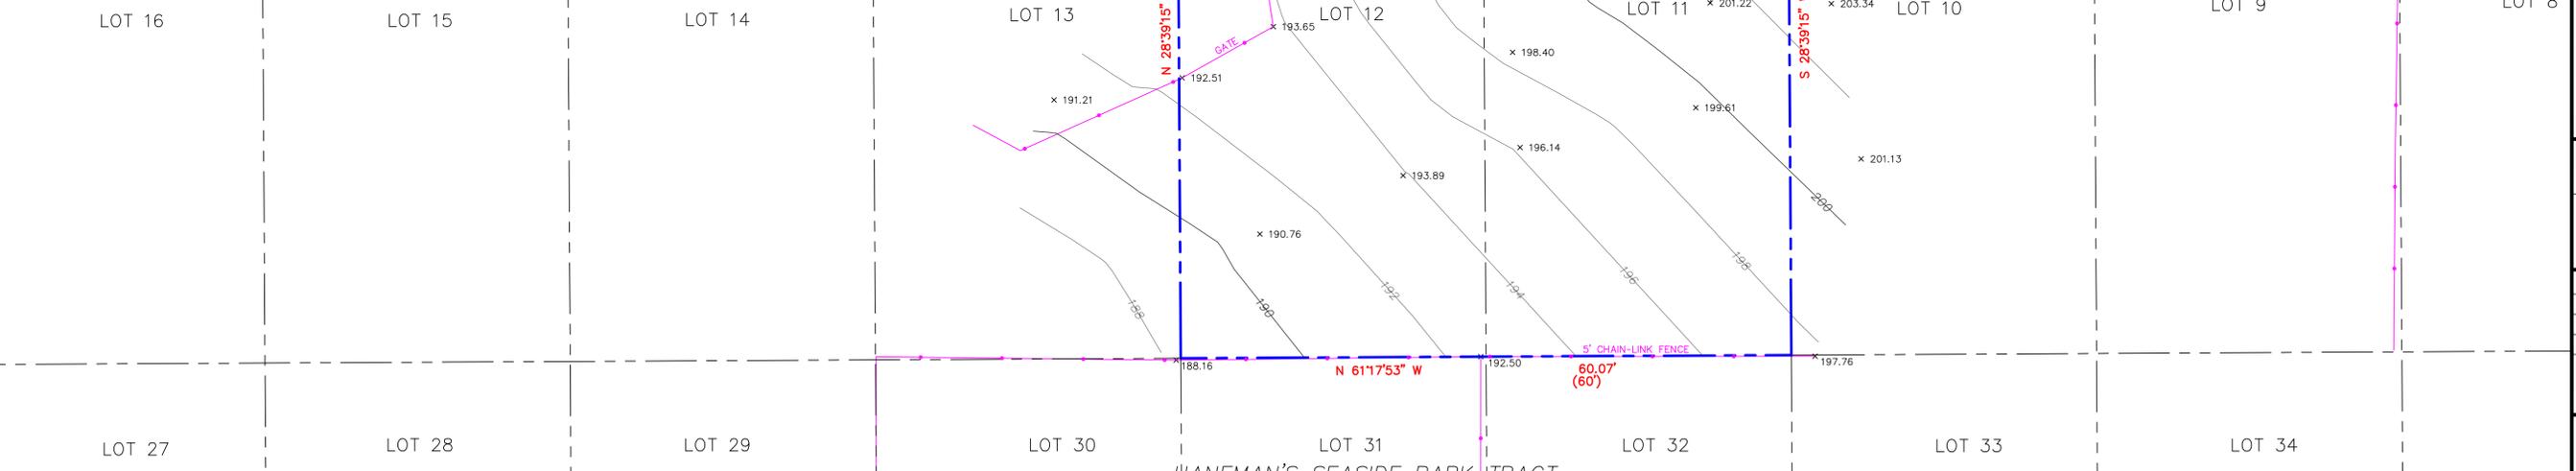
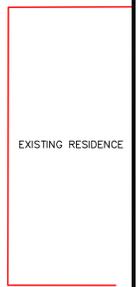
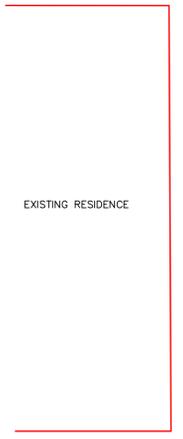
**BASIS OF BEARINGS**  
 THE BEARING, SOUTH 61°17'53" EAST, OF THE CENTERLINE OF 10TH STREET, AS SHOWN ON THAT CERTAIN RECORD OF SURVEY WHICH WAS FILED FOR RECORD IN BOOK 23 OF LLS MAPS PAGE 87 ON JUNE 20, 2002, SAN MATEO COUNTY RECORDS., WAS USED AS THE BASIS OF BEARINGS FOR THIS SURVEY.

**BENCHMARK**  
 ELEVATIONS SHOWN HEREON ARE BASED UPON NGVD 29 ("MEAN SEA LEVEL") DATUM. SITE BENCHMARK IS THE SANITARY SEWER MANHOLE LID WITH AN ELEVATION OF 200.75 FEET.


**NOTES:**  
 BGT RELIED UPON A LAWYERS TITLE COMPANY PRELIMINARY TITLE REPORT, ORDER NO. 0051900303, AS TITLE REFERENCE. NO EASEMENTS WERE REFERENCED WITHIN SAID REPORT.

UTILITIES SHOWN HEREON TAKEN FROM VISUAL SURFACE EVIDENCE AND SHOULD BE CONSIDERED AS APPROXIMATE ONLY. ACTUAL LOCATIONS OF UTILITIES MAY VARY. TRUE LOCATION OF UTILITIES CAN ONLY BE OBTAINED BY EXPOSING THE UTILITY.

SURVEY PERFORMED BY: BGT LAND SURVEYING  
 www.bgtsurveying.com  
 DATE OF FIELD SURVEY: SEPTEMBER 13, 2019  
 JOB NUMBER: 19-143




HANEMAN'S SEASIDE PARK TRACT  
 BOOK 4 MAPS 63  
 BLOCK 28

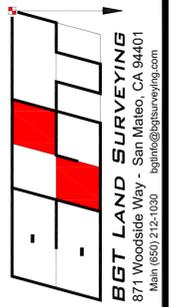

**BOUNDARY AND TOPOGRAPHIC SURVEY**  
 LOTS 11-12, BLOCK 28, "HANEMAN'S SEASIDE PARK TRACT" (BOOK 4 MAPS 63)  
**VACANT LOTS 11 & 12, 10TH STREET**  
 MONTARA, COUNTY OF SAN MATEO, CALIFORNIA

|   |
|---|
| Assessor Parcel Number:<br>036-031-280                                      |
| Prepared For:<br>FULLI<br>1855 SUNSHINE VALLEY ROAD<br>MOSS BEACH, CA 94038 |
| Date: SEPT. 2019  |
| Scale: 1" = 8'  |
| Contour Interval: 2'  |
| Drawn by: LHL   |
| Revisions:  |
| <b>SU-1</b>   |
| Job No. 19-143  |



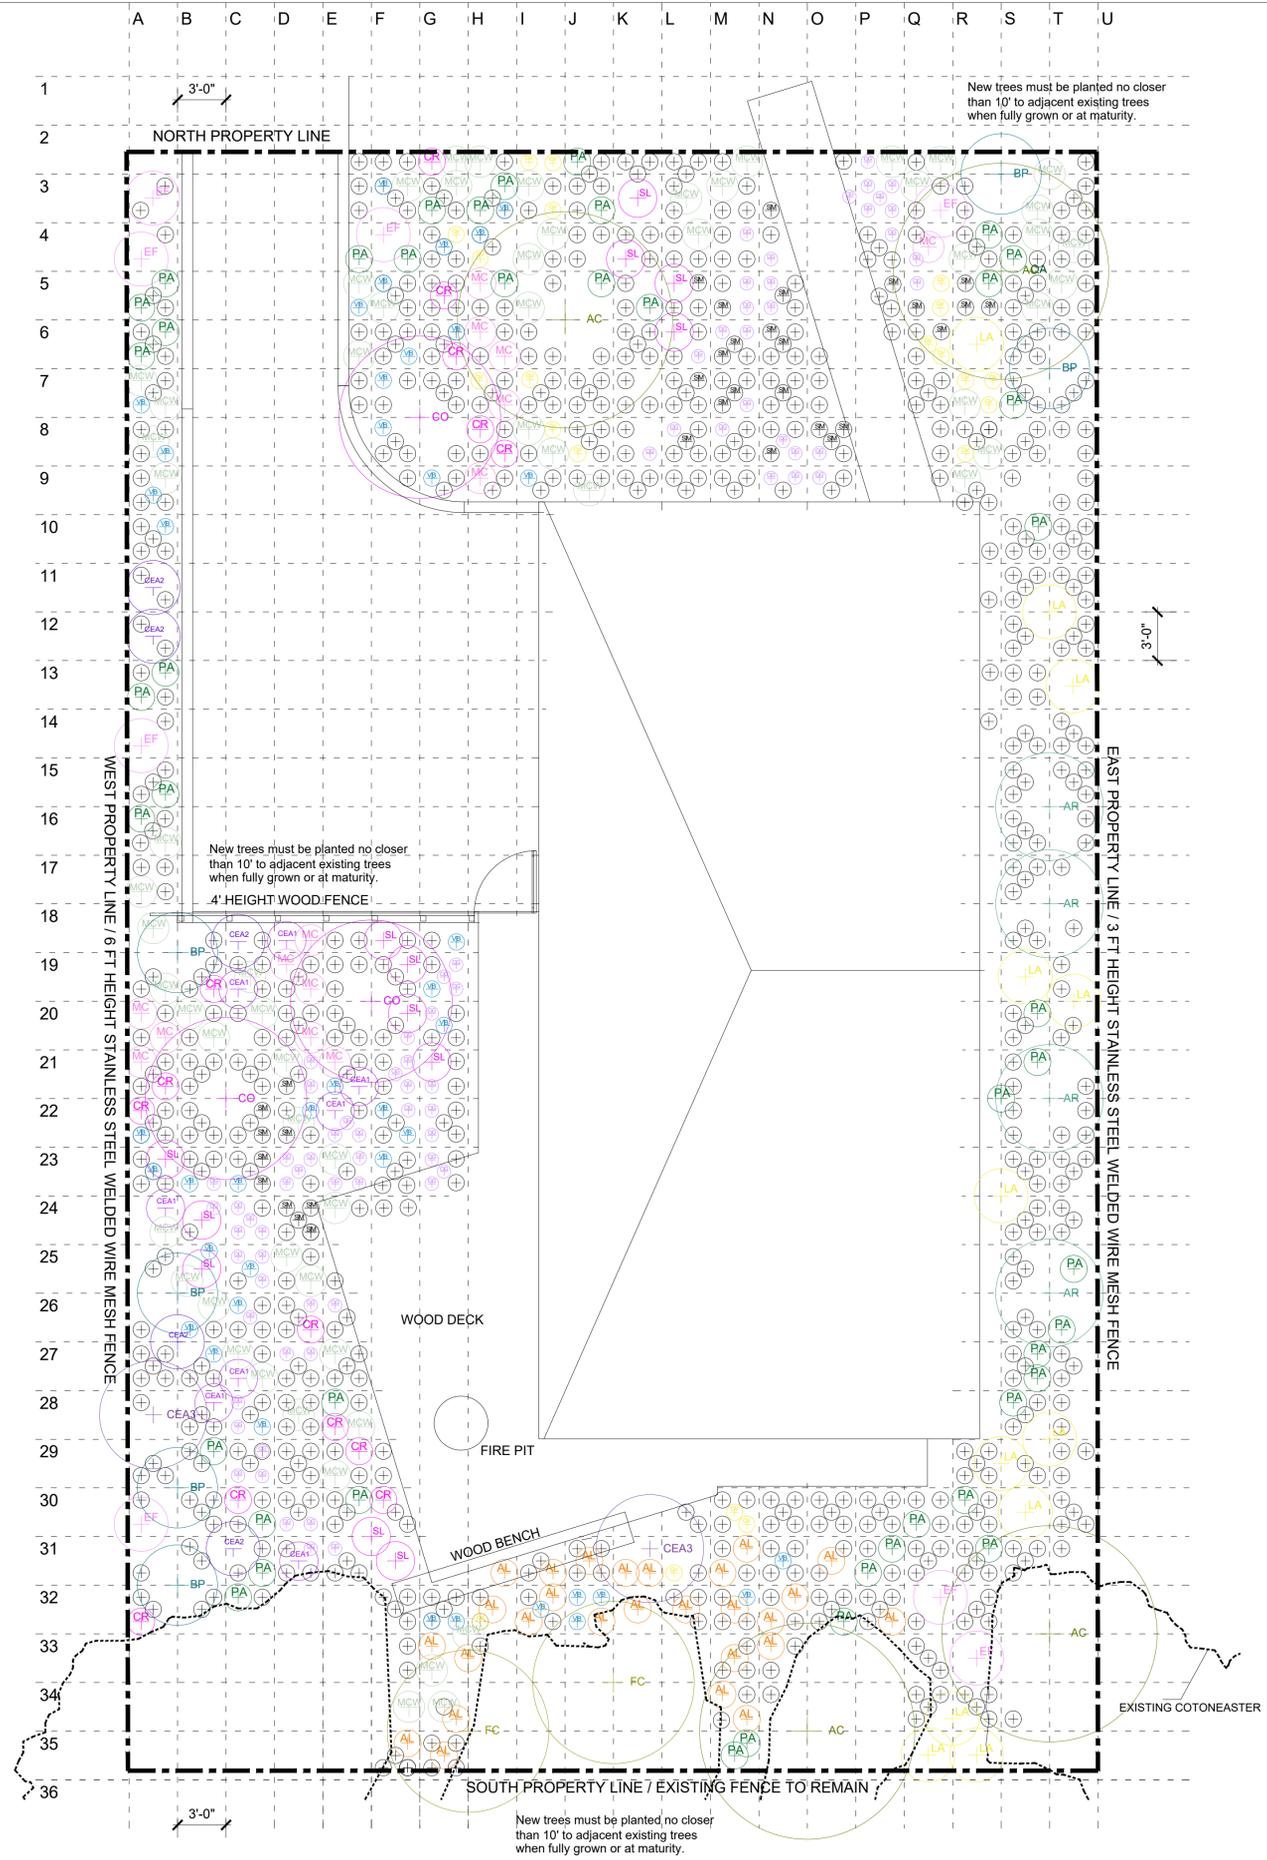

TREES

- 

**02. California Buckeye**  
*Aesculus californica*  
Water Use: Very Low  
Sun Exp: Full sun - Part shade  
Dimensions: 13 to 40 ft Tall, 10 to 40 ft Wide  
Quantity: 4  
Code: AC
- 

**03. Western Redbud**  
*Cercis occidentalis*  
Water Use: Very Low  
Sun Exp: Full sun - Part shade  
Dimensions: 10 to 20 ft Tall, 10 to 15 ft Wide  
Quantity: 3  
Code: CO
- 

**04. Fig Black Mission**  
*Ficus carica* "Black Mission"  
Water Use: Moderate / Medium  
Sun Exp: Full sun - Part shade  
Dimensions: 20 to 35 ft Tall, 20 to 35 ft Wide  
Quantity: 2  
Code: FC
- 

**05. Coyote Brush**  
*Baccharis pilularis*  
Water Use: Low  
Sun Exp: Full sun - Part shade  
Dimensions: 1.5 to 10 ft Tall, 12 ft Wide  
Quantity: 6  
Code: BP
- 

**06A. Ceanothus**  
*C. griseus horizontalis* (Carmel Creeper)  
Water Use: Low  
Sun Exp: Part shade  
Dimensions: 3 to 15 ft Tall, 4 to 15 ft Wide  
Quantity: 8  
Code: CEA1
- 

**06B. Ceanothus**  
*C. gloriosus exaltatus* (Point Reyes)  
Water Use: Low  
Sun Exp: Part shade  
Dimensions: 3 to 7 ft Tall, 3 to 7 ft Wide  
Quantity: 5  
Code: CEA2
- 

**06C. Ceanothus**  
*C. impressus* (Santa Barbara)  
Water Use: Low  
Sun Exp: Full sun - Part shade  
Dimensions: 4 to 6 ft Tall, 4 to 6 ft Wide  
Quantity: 2  
Code: CEA3
- 

**07. Mariposa Manzanita**  
*Arctostaphylos viscosa* ssp. *mariposa*  
Water Use: Very low  
Sun Exp: Full sun - Part shade  
Dimensions: 8 to 10 ft Tall, 8 to 10 ft Wide  
Quantity: 5  
Code: AR
- 

**08. Coastal Bush Lupine**  
*Lupinus arboreus*  
Water Use: Low  
Sun Exp: Full sun  
Dimensions: 3.5 to 7 ft Tall, 4 ft Wide  
Quantity: 12  
Code: LA
- 

**09. Purple Sage**  
*Salvia leucophylla*  
Water Use: Low  
Sun Exp: Full sun  
Dimensions: 3 to 4 ft Tall, 6 to 8 ft Wide  
Quantity: 13  
Code: SL
- 

**10. California Buckwheat**  
*Eriogonum fasciculatum*  
Water Use: Very Low  
Sun Exp: Full sun  
Dimensions: 1 to 6 ft Tall, 3 ft Wide  
Quantity: 8  
Code: EF
- 

**11. Calandrina**  
*Calandrina grandiflora*  
Water Use: Low  
Sun Exp: Full sun - Part shade  
Dimensions: 1 to 3 ft Tall, 2 to 3 ft Wide  
Quantity: 79  
Code: CG
- 

**12. Red Valerian**  
*Centranthus ruber*  
Water Use: Very low  
Sun Exp: Full sun  
Dimensions: 2 to 3 ft Tall, 2 ft Wide  
Quantity: 14  
Code: CR
- 

**13. Dwarf Little One**  
*Verbena bonariensis*  
Water Use: Very low  
Sun Exp: Full sun - Part Shade  
Dimensions: 2 to 4 ft Tall, 1.5 to 3 ft Wide  
Quantity: 41  
Code: VB
- 

**14. Threadleaf Coreopsis**  
*Coreopsis verticillata* cvs.  
Water Use: Low  
Sun Exp: Full sun  
Dimensions: 1 to 2 ft Tall, 3 ft Wide  
Quantity: 21  
Code: CGS
- 

**15. Blue Grama**  
*Bouteloua gracilis*  
Water Use: Low  
Sun Exp: Full sun - Part Shade  
Dimensions: 0.5 to 2 ft Tall, 2 ft Wide  
Quantity: 722  
Code: BG
- 

**16. Pink Muhlygrass**  
*Muhlenbergia capillaris*  
Water Use: Low  
Sun Exp: Full sun - Part Shade  
Dimensions: 2 to 3 ft Tall, 2 to 3 ft Wide  
Quantity: 14  
Code: MC
- 

**17. White Cloud Muhlygrass**  
*Muhlenbergia capillaris* "White Cloud"  
Water Use: Low  
Sun Exp: Full sun - Part Shade  
Dimensions: 3 to 4 ft Tall, 3 to 4 ft Wide  
Quantity: 62  
Code: MCW
- 


**18. Fountain Grass**  
*Pennisetum alopecuroides* "Hameln"  
Water Use: Low  
Sun Exp: Full sun - Part Shade  
Dimensions: 1.5 to 2.5 ft Tall, 1.5 to 2.5 ft Wide  
Quantity: 45  
Code: PA
- 

**19. New Zealand Wind Grass**  
*Anemathole lessoniana*  
Water Use: Moderate / Medium  
Sun Exp: Full sun - Part Shade  
Dimensions: 2 to 3 ft Tall, 2 to 3 ft Wide  
Quantity: 27  
Code: AL
- 

**20. Blue Chalksticks**  
*Senecio mandraliscae*  
Water Use: Low  
Sun Exp: Full sun - Part Shade  
Dimensions: 12 to 18 in. Tall, 18 to 24 in. Wide  
Quantity: 33  
Code: SM

- Recirculating water systems shall be used for water features
- A minimum 3-inch layer of mulch shall be applied on all exposed soil surfaces of planting areas except turf areas, creeping or rooting groundcovers, or direct seeding applications where mulch is contraindicated.
- For soils less than 6% organic matter in the top 6 inches of soil, compost at a rate of a minimum of four cubic yards per 1,000 square feet of permeable area shall be incorporated to a depth of six inches into the soil.
- At the time of final inspection, the permit applicant must provide the owner of the property with a certificate of completion, certificate of installation, irrigation schedule of landscape and irrigation maintenance.
- Unless contradicted by a soil test, compost at a rate of a minimum of four cubic yards per 1,000 square feet of permeable area shall be incorporated to a depth of six inches into the soil.
- A diagram of the irrigation plan showing hydrozones shall be kept with the irrigation controller for subsequent management purposes
- A Certificate of Completion shall be filled out and certified by either the designer of the landscape plans, irrigation plans, or the licensed landscape contractor for the project.
- An irrigation audit report shall be completed at the time of final inspection.
- Trees located within the defensible space (30 feet from structure) shall be pruned to remove dead and dying portions, and limbed up 6 feet above the ground.
- New trees planted in the defensible space shall be located no closer than 10' to adjacent trees when fully grown or at maturity.
- Remove that portion of any existing trees, which extends within 10 feet of the outlet of a chimney or stovepipe or is within 5' of any structure. Maintain any tree adjacent to or overhanging a building free of dead or dying wood.


COUNTY APPROVAL STAMP

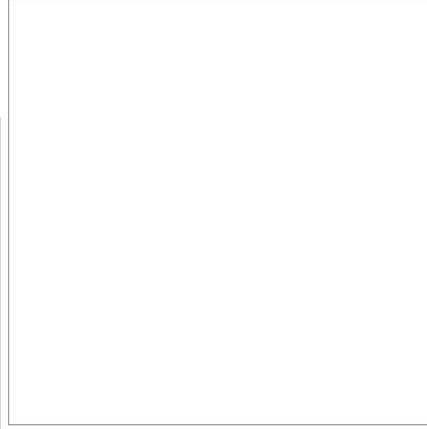

I agree to comply with the requirements of the water efficient landscape ordinance and submit a complete Landscape Documentation Package  
 Tomas McKay, May 6th, 2021

REVISION:

**FOR REVIEW & FILING  
NOT FOR CONSTRUCTION**

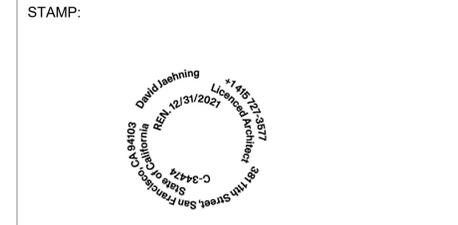

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**David Jaehning Architect**  
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IRRIGATION:  
 Russell D Mitchel Associates, Inc.  
 2760 Camino Diablo, Walnut Creek, CA 94597

CLIENT:  
**Irene Chan-Jones and Bill Jones**  
 100 Burlwood Drive, San Francisco, CA 94127

PROJECT NO: PROJECT NAME:  
**2101 House on a Hill**

PROJECT ADDRESS:  
 340 10th Street  
 Montara, CA 94037

PROJECT PHASE: **100% Schematic Design**

DRAWN: TMc CHECKED DJ

ISSUE DATE: 02/14/2022 12:00 PM

DRAWING TITLE: **LANDSCAPE PLANTING PLAN**

DRAWING NO: **L002**

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# IRRIGATION NOTES

- THESE IRRIGATION DRAWINGS ARE DIAGRAMMATIC AND INDICATIVE OF THE WORK TO BE INSTALLED. ALL PIPING, VALVES, AND OTHER IRRIGATION COMPONENTS MAY BE SHOWN WITHIN PAVED AREAS FOR GRAPHIC CLARITY ONLY AND ARE TO BE INSTALLED WITHIN PLANTING AREAS. DUE TO THE SCALE OF THE DRAWINGS, IT IS NOT POSSIBLE TO INDICATE ALL OFFSETS, FITTINGS, SLEEVES, CONDUIT, AND OTHER ITEMS WHICH MAY BE REQUIRED. INVESTIGATE THE STRUCTURAL AND FINISHED CONDITION AFFECTING THE CONTRACT WORK INCLUDING OBSTRUCTIONS, GRADE DIFFERENCES OR AREA DIMENSIONAL DIFFERENCES. IN THE EVENT OF FIELD DISCREPANCY WITH CONTRACT DOCUMENTS, PLAN THE INSTALLATION WORK ACCORDINGLY BY NOTIFICATION AND APPROVAL OF THE OWNER'S AUTHORIZED REPRESENTATIVE AND ACCORDING TO THE CONTRACT SPECIFICATIONS. NOTIFY AND COORDINATE IRRIGATION CONTRACT WORK WITH APPLICABLE CONTRACTORS FOR THE LOCATION AND INSTALLATION OF PIPE, CONDUIT OR SLEEVES THROUGH OR UNDER WALLS, ROADWAYS, PAVING AND STRUCTURES BEFORE CONSTRUCTION. IN THE EVENT THESE NOTIFICATIONS ARE NOT PERFORMED, THE CONTRACTOR ASSUMES FULL RESPONSIBILITY FOR REQUIRED REVISIONS.
- THE CONTRACTOR SHALL COMPLY WITH ALL APPLICABLE CODES, STANDARDS, AND REGULATIONS. ALL WORK AND MATERIALS SHALL BE IN FULL ACCORDANCE WITH THE LATEST RULES AND REGULATIONS OF THE NATIONAL ELECTRIC CODE; THE UNIFORM PLUMBING CODE, PUBLISHED BY THE WESTERN PLUMBING OFFICIALS ASSOCIATION; AND OTHER STATE OR LOCAL LAWS OR REGULATIONS. NOTHING IN THESE DRAWINGS IS TO BE CONSTRUED TO PERMIT WORK NOT CONFORMING TO THESE CODES OR REGULATIONS. THE CONTRACTOR SHALL FURNISH WITHOUT ANY EXTRA CHARGE, ANY ADDITIONAL MATERIAL AND LABOR WHEN REQUIRED BY THE COMPLIANCE WITH THESE CODES AND REGULATIONS.
- THE CONTRACTOR SHALL COORDINATE INSTALLATION OF IRRIGATION SYSTEM WITH LAYOUT AND INSTALLATION OF THE PLANT MATERIALS TO INSURE THAT THERE WILL BE COMPLETE AND UNIFORM IRRIGATION COVERAGE OF PLANTING IN ACCORDANCE WITH THESE DRAWINGS, AND CONTRACT DOCUMENTS. THE IRRIGATION LAYOUT SHALL BE CHECKED BY THE CONTRACTOR AND OWNER'S AUTHORIZED REPRESENTATIVE PRIOR TO CONSTRUCTION TO DETERMINE IF ANY CHANGES, DELETIONS, OR ADDITIONS ARE REQUIRED. IRRIGATION SYSTEM SHALL BE INSTALLED AND TESTED PRIOR TO INSTALLATION OF PLANT MATERIAL.
- THE INTENT OF THIS IRRIGATION SYSTEM IS TO PROVIDE THE MINIMUM AMOUNT OF WATER REQUIRED TO SUSTAIN GOOD PLANT HEALTH.
- IT IS THE RESPONSIBILITY OF THE MAINTENANCE CONTRACTOR AND/OR OWNER TO PROGRAM THE IRRIGATION CONTROLLER(S) TO PROVIDE THE MINIMUM AMOUNT OF WATER NEEDED TO SUSTAIN GOOD PLANT HEALTH. THIS INCLUDES MAKING ADJUSTMENTS TO THE PROGRAM FOR SEASONAL WEATHER CHANGES, PLANT MATERIAL, WATER REQUIREMENTS, MOUNDS, SLOPES, SUN, SHADE AND WIND EXPOSURE.
- IT IS THE RESPONSIBILITY OF A LICENSED ELECTRICAL CONTRACTOR TO PROVIDE 120 VOLT A.C. (2.5 AMP DEMAND PER CONTROLLER) ELECTRICAL SERVICE TO THE CONTROLLER LOCATION(S). IT IS THE RESPONSIBILITY OF THE IRRIGATION CONTRACTOR TO COORDINATE THE ELECTRICAL SERVICE STUB-OUT TO THE CONTROLLER(S). PROVIDE PROPER GROUNDING PER CONTROLLER MANUFACTURER'S INSTRUCTIONS AND IN ACCORDANCE WITH LOCAL CODES.
- SCHEDULE A MEETING WHICH INCLUDES REPRESENTATIVES OF THE IRRIGATION CONTROLLER MANUFACTURER, THE MAINTENANCE CONTRACTOR, THE OWNER AND THE IRRIGATION CONTRACTOR AT THE SITE FOR INSTRUCTION ON THE PROPER PROGRAMMING AND OPERATION OF THE IRRIGATION CONTROLLER.
- INSTALL 3" DETECTABLE TAPE ABOVE ALL PRESSURIZED MAIN LINES AS DETAILED. USE CHRISTY MODEL #TA-DT-3-BIRR FOR POTABLE IRRIGATION SYSTEMS OR #TA-DT-3-PRW FOR RECYCLED IRRIGATION WATER SYSTEMS.
- PROVIDE EACH IRRIGATION CONTROLLER WITH ITS OWN INDEPENDENT LOW VOLTAGE COMMON GROUND WIRE.
- IRRIGATION CONTROL WIRES: SOLID COPPER WITH U.L. APPROVAL FOR DIRECT BURIAL IN GROUND. COMMON GROUND WIRE: SIZE #12-1 WIRE WITH A WHITE INSULATING JACKET. CONTROL WIRE SERVING REMOTE CONTROL VALVES: SIZE #14-1 WIRE WITH INSULATING JACKET OF COLOR OTHER THAN WHITE. SPLICES SHALL BE MADE WITH 3M-DBY SEAL PACKS OR APPROVED EQUAL.
- SPLICING OF LOW VOLTAGE WIRES IS PERMITTED IN VALVE BOXES ONLY. LEAVE A 36" LONG, 1" DIAMETER COIL OF EXCESS WIRE AT EACH SPLICE AND A 36" LONG EXPANSION LOOP EVERY 100 FEET ALONG WIRE RUN. TAPE WIRES TOGETHER EVERY TEN FEET. DO NOT TAPE WIRES TOGETHER WHERE CONTAINED WITHIN SLEEVING OR CONDUIT.
- INSTALL BLACK PLASTIC VALVE BOXES WITH BOLT DOWN, NON HINGED COVER MARKED "IRRIGATION CONTROL VALVE". BOX BODY SHALL HAVE KNOCK OUTS. ACCEPTABLE VALVE BOX MANUFACTURER'S INCLUDE NDS, CARSON OR APPROVED EQUAL.

- THE CONTRACTOR SHALL LABEL CONTROL LINE WIRE AT EACH REMOTE CONTROL VALVE WITH A 2 1/4" X 2 3/4" POLYURETHANE I.D. TAG, INDICATING IDENTIFICATION NUMBER OF VALVE (CONTROLLER AND STATION NUMBER). ATTACH LABEL TO CONTROL WIRE. THE CONTRACTOR SHALL PERMANENTLY STAMP ALL VALVE BOX LIDS WITH APPROPRIATE IDENTIFICATION AS NOTED IN CONSTRUCTION DETAILS.
- FLUSH AND ADJUST IRRIGATION OUTLETS AND NOZZLES FOR OPTIMUM PERFORMANCE AND TO PREVENT OVER SPRAY ONTO WALKS, ROADWAYS, AND/OR BUILDINGS. SELECT THE BEST DEGREE OF THE ARC AND RADIUS TO FIT THE EXISTING SITE CONDITIONS AND THROTTLE THE FLOW CONTROL AT EACH VALVE TO OBTAIN THE OPTIMUM OPERATING PRESSURE FOR EACH CONTROL ZONE.
- WHERE IT IS NECESSARY TO EXCAVATE ADJACENT TO EXISTING TREES, USE CAUTION TO AVOID INJURY TO TREES AND TREE ROOTS. EXCAVATE BY HAND IN AREAS WHERE TWO (2) INCH AND LARGER ROOTS OCCUR. BACK FILL TRENCHES ADJACENT TO TREE WITHIN TWENTY-FOUR (24) HOURS. WHERE THIS IS NOT POSSIBLE, SHADE THE SIDE OF THE TRENCH ADJACENT TO THE TREE WITH WET BURLAP OR CANVAS.
- THE IRRIGATION SYSTEM DESIGN IS BASED ON THE MINIMUM OPERATING PRESSURE SHOWN ON THE IRRIGATION DRAWINGS. VERIFY WATER PRESSURE PRIOR TO CONSTRUCTION. REPORT ANY DIFFERENCE BETWEEN THE WATER PRESSURE INDICATED ON THE DRAWINGS AND THE ACTUAL PRESSURE READING AT THE IRRIGATION POINT OF CONNECTION TO THE OWNER'S AUTHORIZED REPRESENTATIVE.
- IRRIGATION DEMAND: REFER TO PLANS.
- THE EXISTING MAIN LINE SHOWN ON THE DRAWINGS IS DIAGRAMMATIC. VERIFY AND LOCATE EXISTING MAIN LINE IN FIELD. REPORT TO ARCHITECT IN WRITING ANY DEVIATION OF EXISTING MAIN LINE LOCATION FROM THAT SHOWN ON THE DRAWINGS.
- PIPE THREAD SEALANT COMPOUND SHALL BE RECTOR SEAL #5.
- THE LANDSCAPE CONTRACTOR SHALL BE RESPONSIBLE FOR MINOR CHANGES IN THE IRRIGATION LAYOUT DUE TO OBSTRUCTIONS NOT SHOWN ON THE IRRIGATION DRAWINGS SUCH AS LIGHTS, FIRE HYDRANTS, SIGNS, ELECTRICAL ENCLOSURES, ETC.
- WHEN WORK OF THIS SECTION HAS BEEN COMPLETED AND SUCH OTHER TIMES AS MAY BE DIRECTED, REMOVE ALL TRASH, DEBRIS, SURPLUS MATERIALS AND EQUIPMENT FROM SITE.
- CONTRACTOR SHALL BE RESPONSIBLE FOR SUPPLEMENTAL HAND WATERING OF ALL PLANT MATERIAL WITHIN DRIPLINE AREAS UNTIL THE PLANTS ARE SUFFICIENTLY ESTABLISHED.
- CONTRACTOR SHALL PROVIDE COMPLETE CONTROLLER HYDROZONES CHARTS AND PLACE WITHIN CONTROLLER ENCLOSURE AFTER AS-BUILT DRAWINGS HAVE BEEN COMPLETED, REVIEWED AND APPROVED BY THE CITY LANDSCAPE ARCHITECT.
- A CERTIFICATE OF COMPLETION SHALL BE FILLED OUT AND CERTIFIED BY EITHER LA, DESIGNER, OF THE PLANTING/ THE LICENSED LANDSCAPE CONTRACTOR FOR THE PROJECT.
- AT THE TIME OF FINAL INSPECTION, THE PERMIT APPLICANT MUST PROVIDE THE OWNER OF THE PROPERTY WITH A CERTIFICATE OF COMPLETION, CERTIFICATE OF INSTALLATION, IRRIGATION SCHEDULE OF LANDSCAPE AND IRRIGATION MAINTENANCE, ALL THESE SHALL BE COMPLETED BY LANDSCAPE CONTRACTOR.


"A Landscape Irrigation Audit is require. This Audit must be completed by a Certified Landscape Irrigation Auditor, not the designer or installer. The Audit must be submitted to the Building Department, with Certificate of Completion (Appendix C) as required by the Department of Water Resources, prior to scheduling a Final Inspection of the Water Efficient Landscape permit."

WATER CONSERVATION STATEMENT  
 RUSSELL D MITCHELL AND ASSOCIATES, INC. (RMA) HAVE COMPLIED WITH THE CRITERIA OF THE MODEL WATER EFFICIENT LANDSCAPE ORDINANCE AND APPLIED THEM ACCORDINGLY FOR THE EFFICIENT USE OF WATER IN THE LANDSCAPE DESIGN PLAN.  
  
 JOSE L. CRUZ  
 IRRIGATION CONSULTANT-PROJECT MANAGER

# IRRIGATION LEGEND

| SYMBOL | NUMBER        | DESCRIPTION  | NOZZLE GPM | OPERATING PSI | OPERATING RADIUS (FEET) |
|--------|---------------|--|------------|---------------|-------------------------|
|        | DB-04-PC-CV   | TORO BUBBLE (SHRUB) MIN. 1 PER SHRUB   | 0.066      | 30            | TRICKLE                 |
|        | HDL-04-CV     | ON GRADE HUNTER HDL DRIP RING FOR TREES (3 RINGS PER TREE) SEE DETAIL  | 0.10       | 30            | TRICKLE                 |
|        | ICV-100       | HUNTER REMOTE CONTROL VALVE  |            |               |                         |
|        | ICZ-101       | HUNTER REMOTE CONTROL VALVE DRIPZONE KIT   |            |               |                         |
|        | PLD-BV        | HUNTER MANUAL FLUSH VALVE  |            |               |                         |
|        | ECO-ID        | HUNTER ECO-INDICATOR   |            |               |                         |
|        | T-580-A-1.25" | NIBCO BRASS BALL VALVE   |            |               |                         |
|        | ICV-101G      | HUNTER MASTER VALVE (NORMALLY CLOSED)  |            |               |                         |
|        | HC-100-FLOW   | HUNTER FLOW METER-PRIVATE METER  |            |               |                         |
|        | 975XLSEU-1"   | WILKINS REDUCED PRESSURE BACKFLOW ASSEMBLY   |            |               |                         |
|        | PHC-600i      | HUNTER PRO-HC (6-24) STATION CONTROLLER IN A PLASTIC WALL MOUNTED ENCLOSURE.   |            |               |                         |
|        | WR-CLIK       | HUNTER WIRELESS RAIN-CLIK SYSTEM. AUTOMATICALLY SHUTS THE SYSTEM OFF AS SOON AS IT STARTS RAINING  |            |               |                         |
|        | KC OR KSC     | NDS KSC SERIES CHECK VALVE FOR UPHILL FLOW DIRECTION OR KC SERIES SPRING CHECK VALVE FOR DOWNHILL FLOW DIRECTION (LINE SIZE)   |            |               |                         |
|        |               | CONTROLLER AND STATION NUMBER  |            |               |                         |
|        |               | REMOTE CONTROL VALVE SIZE (IN INCHES)  |            |               |                         |
|        |               | FLOW (GPM)   |            |               |                         |
|        |               | WATER USE CLASSIFICATION OF ZONE   |            |               |                         |
|        |               | APPLICATION RATE (IN/HR) or DRIPLINE SPACING   |            |               |                         |
|        |               | AREA (SQ. FT.)   |            |               |                         |
|        |               | ASSOCIATED REMOTE CONTROL VALVE  |            |               |                         |
|        |               | MAIN LINE: 1.5" THROUGHOUT; 1120-SCHEDULE 40 PVC PLASTIC PIPE WITH SCHEDULE 40 PVC SOLVENT WELD FITTINGS. 18" COVER.   |            |               |                         |
|        |               | LATERAL LINE: 3/4" AND LARGER; SCHEDULE 40 PVC PLASTIC PIPE WITH SCHEDULE 40 PVC SOLVENT WELD FITTINGS. 12" COVER.   |            |               |                         |
|        |               | DRIPLINE LATERAL LINE: 3/4" AND LARGER; 1120-SCHEDULE 40 PVC PLASTIC PIPE WITH SCHEDULE 40 PVC SOLVENT WELD FITTINGS. 12" COVER.   |            |               |                         |
|        |               | SLEEVING: SCHEDULE 40 PVC PLASTIC PIPE. COVER TO BE AS INDICATED IN SPECIFICATIONS OR AS INDICATED ABOVE FOR PIPE DEPTH OF COVER.  |            |               |                         |
|        |               | DRIPLINE REMOTE CONTROL VALVE  |            |               |                         |
|        |               | DRIP ZONE: HUNTER HDL SERIES DRIPLINE WITH BUILT IN PRESSURE COMPENSATION AND CHECK VALVE, PART #HDL-06-12-250-CV. USE PLD FITTINGS. TUBING TO BE INSTALLED 4" BELOW GRADE IN A 12" O.C. GRID ACCORDING TO DETAILS. SIZE EXHAUST HEADERS AS FOLLOWS: 1": 0-10 GPM, 1.25": 11-20 GPM. ALL EXHAUST HEADERS SHALL BE 1" SCH 40 PVC OR 1" SCH 40 FLEXIBLE PVC. USE SCH. 40 PVC SOLVENT WELD FITTINGS. EXTEND PVC HEADERS TO THE ENDS OF ALL DRIP ZONES TO BALANCE FLOW IF REQUIRED. SEE DETAILS FOR FURTHER INFORMATION. |            |               |                         |
|        |               | DRIPLINE REMOTE CONTROL VALVE  |            |               |                         |
|        |               | APPROXIMATE CONNECTION POINT BETWEEN DRIPLINE TUBING AND PVC SUPPLY WHEN DRIP ZONE IS LESS THAN 3 GPM AND NO PVC SUPPLY/EXHUST HEADERS ARE NEEDED. REFER TO DRIPLINE TUBING CONNECTION DETAIL FOR MORE INFORMATION.  |            |               |                         |

## COUNTY APPROVAL STAMP

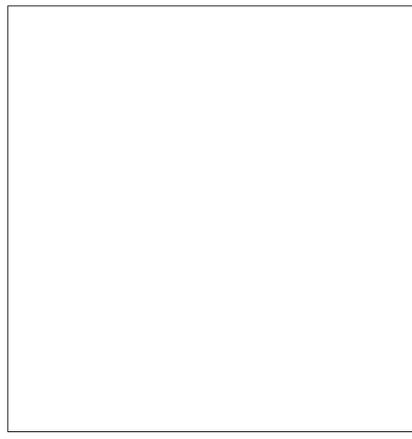

REVISION:

---

**FOR REVIEW & FILING**  
**NOT FOR CONSTRUCTION**

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 2760 Camino Diablo, Walnut Creek, CA 94597

CLIENT:  
**Irene Chan-Jones and Bill Jones**  
 100 Burlwood Drive, San Francisco, CA 94127

PROJECT NO: PROJECT NAME:  
**2101 House on a Hill**  
 APN: 036-031-280  
 PROJECT ADDRESS: 10th St Montara, CA 94037  
 PROJECT PHASE: **100% Schematic Design**  
 DRAWN: Jose Cruz CHECKED:  
 ISSUE DATE: 6/30/2021


DRAWING TITLE: **IRRIGATION NOTES AND LEGEND**  
 DRAWING NO: **IR-12**

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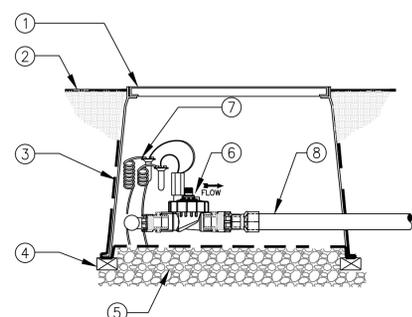
*Irrigation Consultant:*  
**Russell D. Mitchell Associates, Inc.**  
 2760 Camino Diablo  
 Walnut Creek, CA 94597  
 tel 925.939.3985 ♦ fax 925.932.5671  
 www.mairrigation.com



- ① SCH 40 PVC 90° ELBOW (SxS) FROM PVC MAIN LINE BELOW.
- ② SCH 40 PVC PIPE. LENGTH AS REQUIRED.
- ③ SCH 80 PVC MALE ADAPTER.
- ④ CARSON 1220 RECTANGULAR VALVE BOX WITH LID. INSTALL PER REMOTE CONTROL VALVE DETAIL.
- ⑤ NDS 1"LO-TORQ BALL VALVE THREADED (PART #LT-1000-T)
- ⑥ DURA 1"x1" THREADED ADAPTER (PART #08303) 6 TOTAL.
- ⑦ DURA 1" MULTI-PORT MANIFOLD (PART #301-010-4)
- ⑧ DRIP REMOTE CONTROL VALVE. REFER TO LEGEND FOR MODEL.
- ⑨ FILTER. REFER TO LEGEND FOR MODEL.
- ⑩ 40 PSI REGULATOR. REFER TO LEGEND FOR MODEL.
- ⑪ DURA 1" x 3/4" MALE ADAPTER (PART #08303-131) 3 TOTAL. ONLY REQUIRED WITH 3/4" OUTLET REGULATORS. USE 1"x1" DURA THREAD ADAPTER ON 1" REGULATORS
- ⑫ DURA 1" SLIP X 1" SWIVEL (PART #329-011) 4 TOTAL.
- ⑬ SCHEDULE 40 PVC LATERAL TO DRIP IRRIGATION
- ⑭ DURA 1" CAP (PART #348-010)
- ⑮ BUBBLER OR SPRINKLER REMOTE CONTROL VALVE. REFER TO LEGEND FOR MODEL.
- ⑯ SCHEDULE 40 PVC LATERAL TO BUBBLERS OR SPRAY.

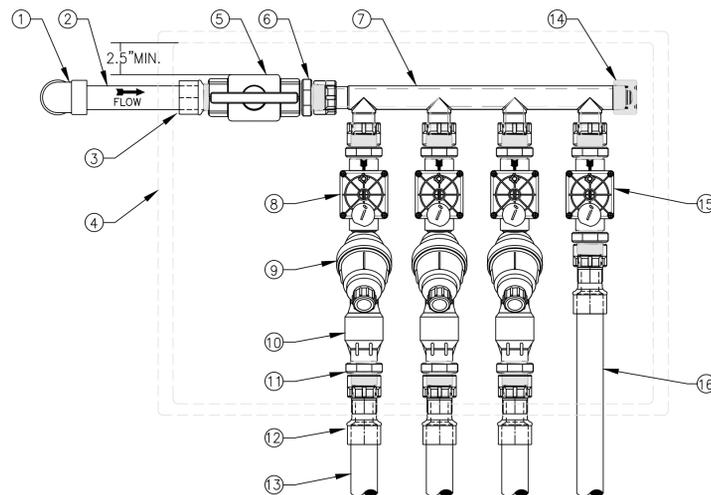


1 FOUR REMOTE VALVE MANIFOLD DETAIL  
SCALE: NONE




- ① CARSON 1220 RECTANGULAR VALVE BOX FOR FOUR VALVES OR CARSON 1419 FOR TWO VALVES
- ② FINISH GRADE
- ③ 19 GAUGE 1/2" SQUARE WIRE MESH. WRAP UP THE SIDES OF THE BOX
- ④ BRICK-1 EACH CORNER
- ⑤ PEA GRAVEL OR 3/4" DRAIN ROCK- 4" DEEP BELOW VALVE (NO SOIL IN VALVE BOX)
- ⑥ REMOTE CONTROL VALVE WITH FLOW CONTROL AND MANUAL BLEED. REFER TO TWO OR FOUR VALVE MANIFOLD DETAIL FOR INSTALLATION INSTRUCTIONS
- ⑦ VALVE CONTROL WIRE- PROVIDE 3M-DBY SEAL PACKS AT ALL SPLICES AND 24" OF EXCESS UF WIRE IN A 1" DIAMETER COIL
- ⑧ SCH 40 PVC LATERAL LINE TO BUBBLERS OR SPRAY

2 BUBBLER OR SPRAY REMOTE CONTROL VALVE IN TWO OR FOUR VALVE MANIFOLD  
SCALE: NONE

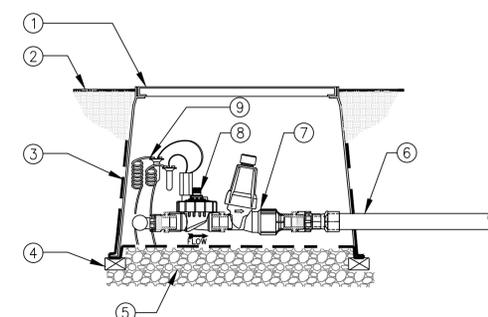


- ① CARSON 1220 RECTANGULAR VALVE BOX FOR FOUR VALVES OR CARSON 1419 FOR TWO VALVES
- ② FINISH GRADE
- ③ 19 GAUGE 1/2" SQUARE WIRE MESH. WRAP UP THE SIDES OF THE BOX
- ④ BRICK-1 EACH CORNER
- ⑤ PEA GRAVEL OR 3/4" DRAIN ROCK- 4" DEEP BELOW VALVE (NO SOIL IN VALVE BOX)
- ⑥ SCH 40 PVC LATERAL LINE TO DRILINE OR DRIP.
- ⑦ DRIP FILTER AND REGULATOR
- ⑧ REMOTE CONTROL VALVE WITH FLOW CONTROL AND MANUAL BLEED. REFER TO TWO OR FOUR VALVE MANIFOLD DETAIL FOR INSTALLATION INSTRUCTIONS
- ⑨ VALVE CONTROL WIRE- PROVIDE 3M-DBY SEAL PACKS AT ALL SPLICES AND 24" OF EXCESS UF WIRE IN A 1" DIAMETER COIL

3 DRIP REMOTE CONTROL VALVE IN TWO OR FOUR VALVE MANIFOLD  
SCALE: NONE

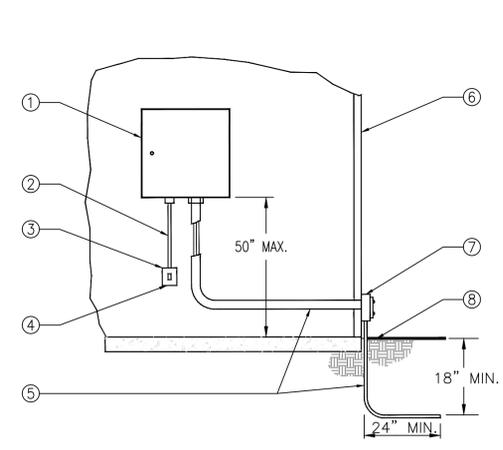


- ① IRRIGATION CONTROLLER
- ② 120 VOLT SERVICE IN RIGID STEEL CONDUIT
- ③ 120 VOLT LOCKABLE ON/OFF SWITCH PROVIDED UNDER IRRIGATION CONTRACT
- ④ 120 VOLT SERVICE TO CONTROLLER LOCATION PROVIDED BY ELECTRICAL CONTRACTOR
- ⑤ SCHEDULE 40 GREY PVC ELECTRICAL CONDUIT FOR LOW VOLTAGE WIRE
- ⑥ EXTERIOR WALL
- ⑦ ELECTRICAL PULL BOX PER ELECTRICAL CODE
- ⑧ FINISH GRADE

4 INTERIOR MOUNTED CONTROLLER  
SCALE: NONE

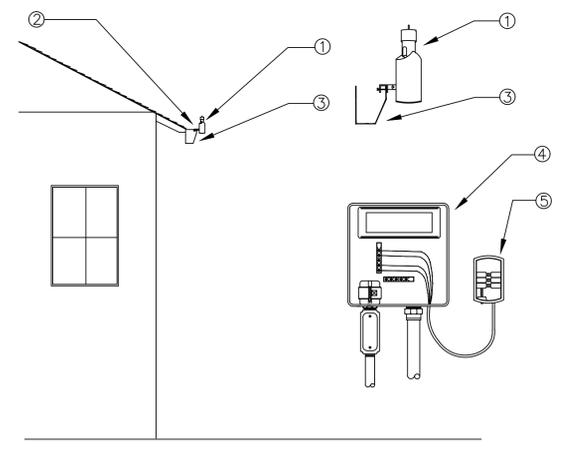

- NOTE: MAXIMUM LINE OF SIGHT FROM RAIN SENSOR TO RECEIVER IS 300 FT. DISTANCE IS LESS IF OBSTRUCTIONS EXIST. SENSOR MUST BE INSTALLED IN "CLEAR SPACE" WHERE IT IS EXPOSED TO UNOBSTRUCTED RAINFALL AND IS CLEAR OF IRRIGATION SPRAY.
- ① WIRELESS RAIN SENSOR TRANSMITTER (GUTTER MOUNTED)
  - ② MOUNT RAIN SENSOR ON GUTTER/EVE
  - ③ GUTTER
  - ④ CONTROLLER
  - ⑤ RAIN SENSOR RECEIVER

5 WIRELESS RAIN SENSOR-GUTTER MOUNT  
SCALE: NONE

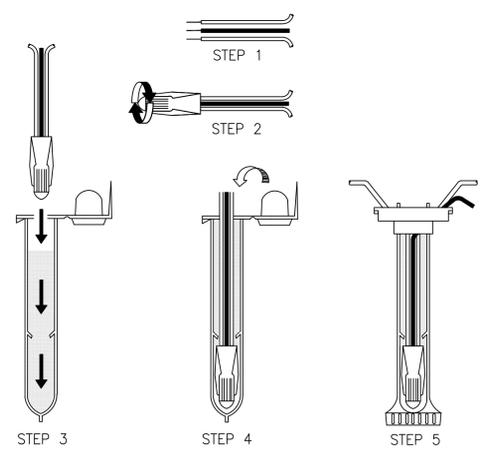

- NOTE: MAXIMUM # OF WIRES PER CONNECTOR:
- 3-#14 GAUGE
  - 2-#12 GAUGE
- INSTRUCTIONS:
1. STRIP WIRES APPROXIMATELY 1/2" FROM ENDS TO EXPOSE WIRE.
  2. TWIST CONNECTOR AROUND WIRES CLOCKWISE UNTIL HAND TIGHT, DO NOT OVERTIGHTEN.
  3. INSERT WIRE ASSEMBLY TO BOTTOM OF GEL-FILLED TUBE. CHECK TO MAKE SURE CONNECTOR HAS BEEN PUSHED PAST LOCKING FINGERS AND IS SEATED AT THE BOTTOM OF THE TUBE.
  4. PLACE WIRES WHICH EXIT TUBE IN WIRE EXIT HOLES AND CLOSE CAP UNTIL IT SNAPS.
  5. INSPECT FINAL SPLICE ASSEMBLY THAT IT IS SECURED.

6 WEATHERPROOF WIRE SPLICE ASSEMBLY  
SCALE: NONE

COUNTY APPROVAL STAMP

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CLIENT:  
  
100 Burlwood Drive, San Francisco, CA 94127

PROJECT NO: PROJECT NAME:

APN: 036-031-280

PROJECT ADDRESS: 10th St Montara, CA 94037

PROJECT PHASE: **100% Schematic Design**


DRAWN: Jose Cruz CHECKED:

ISSUE DATE: 6/30/2021

DRAWING TITLE: **IRRIGATION DETAILS**


DRAWING NO: **IR-14**

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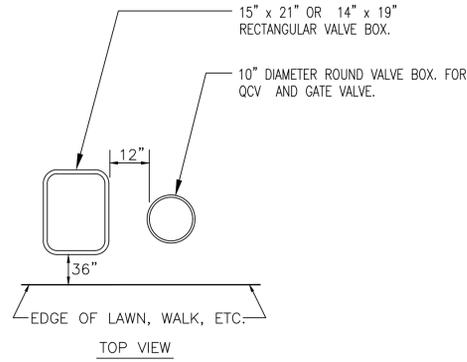
- NOTES:
- ALL MAIN SUPPLY LINES AND LATERAL LINES SHALL BE PLACED IN SLEEVES UNDER PAVED SURFACES. INSTALL LOW VOLTAGE WIRES WITHIN A SEPARATE CONDUIT UNDER PAVED SURFACES. DO NOT TAPE WIRES WITHIN CONDUIT. REUSE SALVAGED EXCAVATED FILL AND COMPACT TO ORIGINAL DENSITY IN LANDSCAPE AREAS. ALL OTHER AREAS SHALL BE AT 95% COMPACTION. BACKFILL MATERIAL SHALL BE THE EARTH EXCAVATED FROM THE TRENCHES, FREE FROM ROCKS (ANYTHING LARGER THAN 2"), CONCRETE CHUNKS, AND OTHER FOREIGN OR COARSE MATERIALS.
  - WHEN 12" POP-UP SPRINKLER HEADS ARE USED, INCREASE THE DEPTH OF LATERAL TO 18" AT THE SPRINKLER LOCATION ONLY.

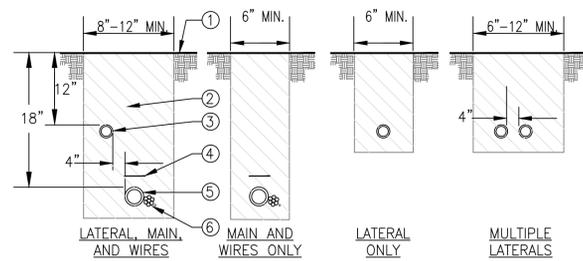- FINISH GRADE.
- CLEAN BACKFILL MATERIAL.
- LATERAL LINE.
- 3" DETECTABLE WARNING TAPE OVER MAIN LINE. INSTALL 3" ABOVE MAIN LINE. USE CHRISTY MODEL #7A-DT-3-BIRR FOR POTABLE IRRIGATION SYSTEMS OR #7A-DT-3-PRW FOR RECYCLED IRRIGATION WATER SYSTEMS
- MAIN LINE.
- LOW VOLTAGE CONTROL WIRES, TWO-WIRE CABLE, OR CONDUIT WITH WIRES. FOR MULTIPLE WIRES, TAPE AND BUNDLE WIRES AT 10 FT. INTERVALS. WIRING SHALL BE LAID OUT LOOSELY IN THE TRENCH.




- FIGURE 8 LINE END
- BLANK TUBING
- DRIPLINE
- HUNTER PLD-TEE (PLD-TEE)
- TREE TRUNK
- ADAPTER TEE FROM PVC TO DRIPLINE.
- ROOT BALL
- 6-INCH SOIL STAPLE (TYP) EQUALLY SPACE 4 AROUND EACH TUBE RING
- LOCATE FIRST DRIPLINE RING HALFWAY BETWEEN THE TRUNK AND EDGE OF ROOTBALL. LOCATE THE SECOND DRIPLINE RING AT EDGE OF ROOTBALL. LOCATE THE THIRD RING 12" OUTSIDE THE SECOND RING

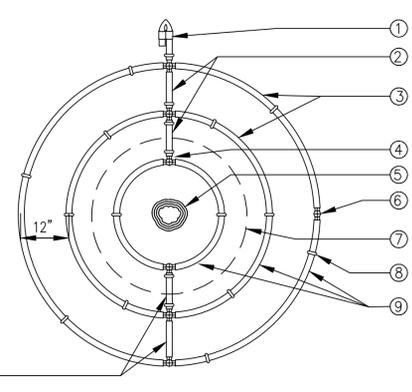- NOTE:  
SUGGESTED QUANTITY DRIP RINGS PER TREES SIZE:
- 15 GAL OR 24" BOX = 2 RINGS
  - 36 GAL OR 48" BOX = 3 RINGS
  - 60 GAL OR LARGER = 4 RINGS



- INSTRUCTIONS:
- CENTER VALVE BOX OVER REMOTE CONTROL VALVES TO FACILITATE SERVICING VALVE.
  - SET BOXES 1" ABOVE FINISH GRADE OR MULCH COVER IN GROUND COVER/SHRUB AREA AND FLUSH WITH FINISH GRADE IN TURF AREA.
  - SET RCV AND VALVE BOX ASSEMBLY IN GROUND COVER/SHRUB AREA WHERE POSSIBLE. INSTALL IN LAWN ONLY IF GROUND COVER DOES NOT EXIST ADJACENT TO LAWN.
  - SET BOXES PARALLEL TO EACH OTHER AND PERPENDICULAR TO EDGE OF LAWN, WALK, FENCE, CURB, ETC.
  - AVOID HEAVILY COMPACTING SOIL AROUND VALVE BOXES TO PREVENT COLLAPSE AND DEFORMATION OF VALVE BOX SIDES.
  - INSTALL EXTENSION BY VALVE BOX MANUFACTURER AS REQUIRED TO COMPLETELY ENCLOSE ASSEMBLY FOR EASY ACCESS.

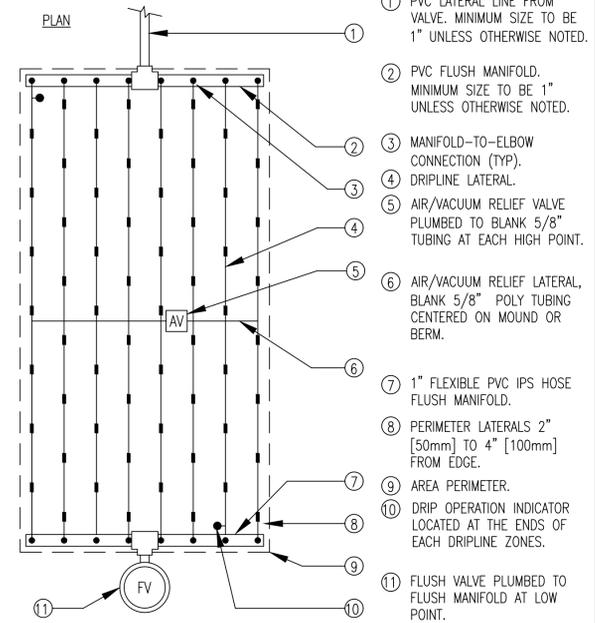


- NOTE:
- THE TOTAL LENGTH OF ALL INTERCONNECTED DRIP LINE OFF A SINGLE PVC SUPPLY LINE CONNECTION OR A SINGLE RUN OF DRIPLINE SHALL NOT EXCEED 300 FT.
  - INSTALL DRIPLINE ON GRADE AND STAKE DOWN EVERY 4' OR AS REQUIRED.

1 TRENCHING  
SCALE: NONE


2 DRIP RINGS AROUND TREE  
SCALE: NONE

3 VALVE BOX INSTALLATION (BOX AND LID SHALL BE BLACK IN COLOR)  
SCALE: NONE

4 PLD DRIPLINE END FEED LAYOUT  
SCALE: NONE

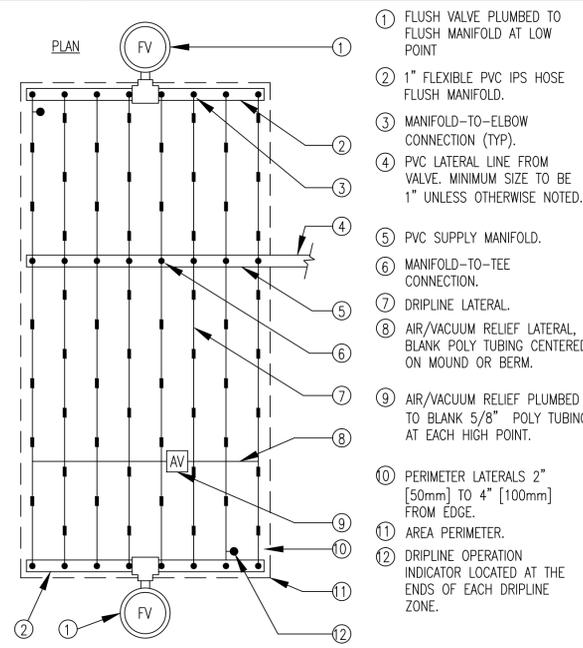


- NOTE:
- THE TOTAL LENGTH OF ALL INTERCONNECTED DRIP LINE OFF A SINGLE PVC SUPPLY LINE CONNECTION OR A SINGLE RUN OF DRIPLINE SHALL NOT EXCEED 300 FT.
  - INSTALL DRIPLINE ON GRADE AND STAKE DOWN EVERY 4' OR AS REQUIRED.

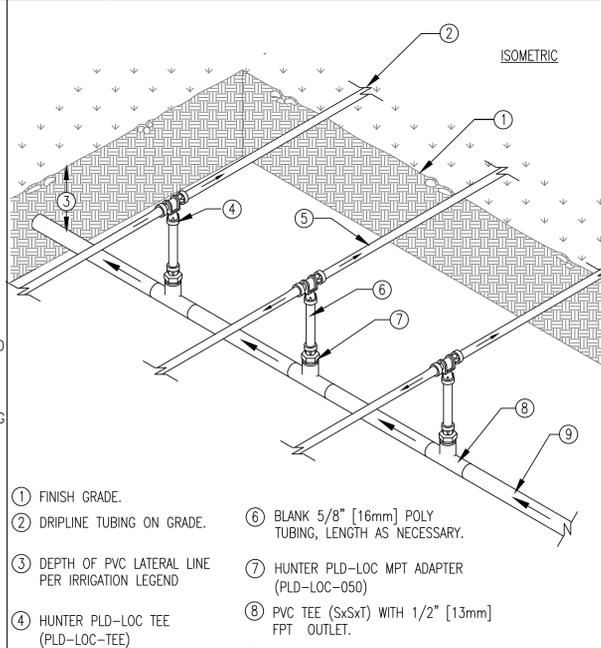

- FINISH GRADE.
- DRIPLINE TUBING ON GRADE.
- DEPTH OF PVC LATERAL LINE PER IRRIGATION LEGEND
- HUNTER PLD-LOC TEE (PLD-LOC-TEE)
- DRIPLINE TUBING.
- BLANK 5/8" [16mm] POLY TUBING, LENGTH AS NECESSARY.
- HUNTER PLD-LOC MPT ADAPTER (PLD-LOC-050)
- PVC TEE (SxSxT) WITH 1/2" [13mm] FPT OUTLET.
- PVC LATERAL LINE FROM REMOTE CONTROL VALVE.

- NOTES:
- THE TOTAL LENGTH OF A SINGLE DRIP LINE RUN SHALL NOT EXCEED 250 FT.
  - INSTALL HUNTER PLD DRIPLINE ON GRADE AND STAKE DOWN EVERY 4' AND COVERED WITH MINIMUM 2" OF BARK MULCH.
  - SCHEDULE 40 PVC LATERAL LINE-STUB INTO EACH PLANTING AREA.
  - CONVERT SCH 40 PVC LATERAL LINE TO DRIPLINE WITH A HUNTER 3/4" FEMALE T ADAPTER.

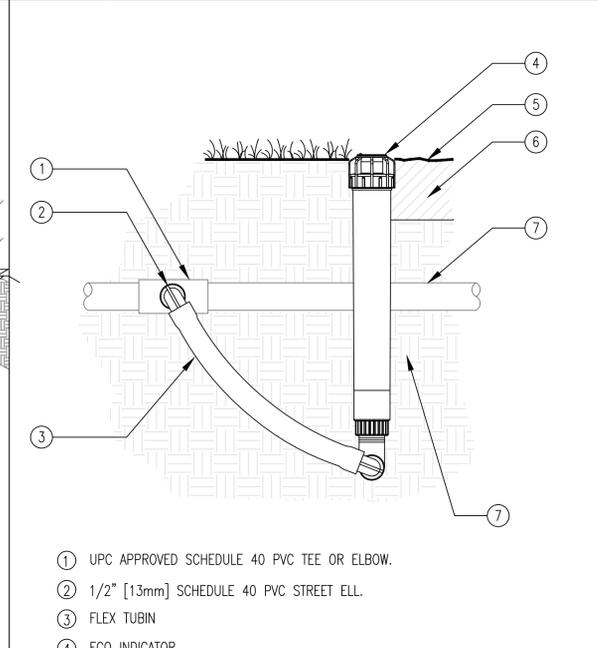

- UPC APPROVED SCHEDULE 40 PVC TEE OR ELBOW.
- 1/2" [13mm] SCHEDULE 40 PVC STREET ELL.
- FLEX TUBING
- ECO INDICATOR
- FINISHED GRADE
- ADJACENT MULCH
- PVC LATERAL PIPE

5 PLD DRIPLINE CENTER FEED LAYOUT  
SCALE: NONE

6 PLD DRIPLINE CENTER FEED MANIFOLD  
SCALE: NONE

7 DRIPLINE OPERATION INDICATOR  
SCALE: NONE

COUNTY APPROVAL STAMP

REVISION:

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PROJECT NO: PROJECT NAME:

APN: 036-031-280

PROJECT ADDRESS: 10th St Montara, CA 94037

PROJECT PHASE: **100% Schematic Design**


DRAWN: Jose Cruz CHECKED:

ISSUE DATE: 6/30/2021

DRAWING TITLE: **IRRIGATION DETAILS**


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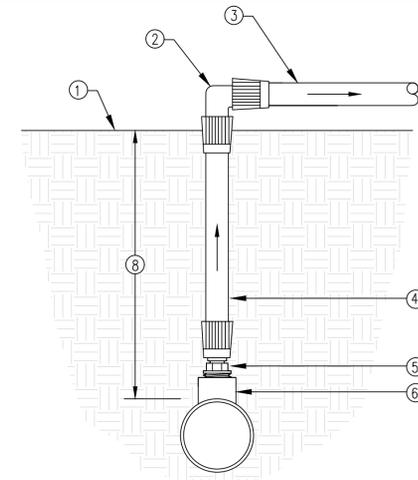
NOTE:  
ALLOW A 12" MINIMUM OF PVC HOSE IN VALVE BOX IN ORDER TO DIRECT FLUSHED WATER OUTSIDE VALVE BOX.

- ① FINISH GRADE
- ② 1/2" SCH 40 THREADED BALL VALVE.
- ③ 1/2" SCH 40 MALE ADAPTER.
- ④ 6" ROUND PLASTIC VALVE BOX.
- ⑤ 1" IPS PVC HOSE FROM EXHAUST HEADER OR BLANK DRIP TUBING.
- ⑥ PEA GRAVEL SUMP (6" DEEP).
- ⑦ BRICK (1 OF 2)

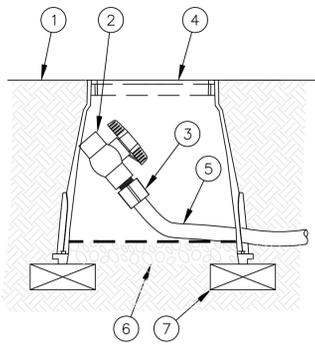


NOTE:  
USE ONE AIR/RELIEF VALVE FOR EVERY 7 GPM PER ZONE. LOCATE AT HIGH POINTS.

- ① 1" ABOVE FINISH GRADE.
- ② FINISH GRADE.
- ③ 6" ROUND PLASTIC VALVE BOX. HEAT BRAND "AR" ON LID IN 1" HIGH CHARACTERS.
- ④ HUNTER AIR/VACUUM RELIEF VALVE PLD-AVR.
- ⑤ HUNTER 17mm BARB TEE X 3/4" ADAPTER (PLD-075-TBTEE)
- ⑥ PLD TUBING
- ⑦ PEA GRAVEL (4" DEEP).
- ⑧ BRICK SUPPORTS (2 COMMON BRICKS REQUIRED).
- ⑨ NATIVE SOIL PER SPECIFICATIONS.

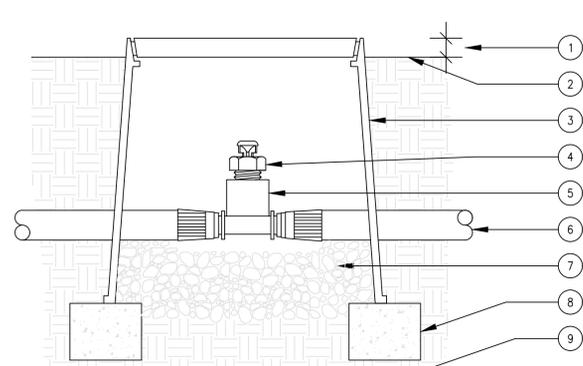

SECTION/ELEVATION  
NOT TO SCALE

- ① FINISH GRADE
- ② HUNTER PLD-LOC ELL (PLD-LOC-ELB)
- ③ DRIPLINE TUBING
- ④ DEPTH OF TUBING PER IRRIGATION LEGEND.
- ⑤ BLANK 5/8" [16mm] POLY TUBING, LENGTH AS NECESSARY.
- ⑥ HUNTER PLD-LOC MPT ADAPTER (PLD-LOC-050)
- ⑦ SCH 40 PVC TEE (SxSxT) WITH 1/2" FPT OUTLET.
- ⑧ DEPTH OF PVC LATERAL LINE PER IRRIGATION LEGEND

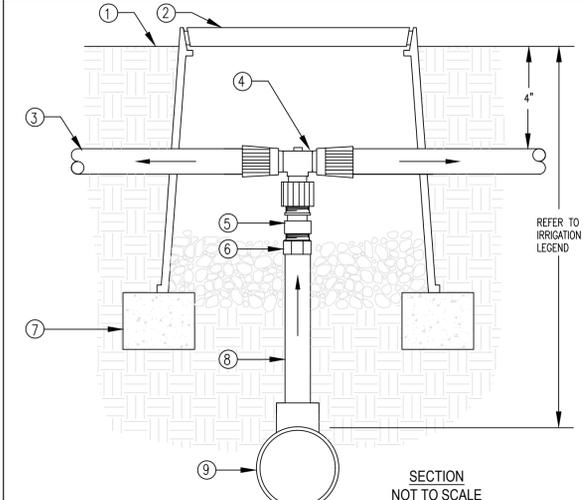

SECTION  
NOT TO SCALE

- ① FINISH GRADE
- ② CARSON 708 OR EQUAL. COLOR: BLACK. USE PURPLE FOR RECYCLED WATER SYSTEMS.
- ③ DRIPLINE TUBING
- ④ HUNTER PLD-TEE X 1/2" FPT ADAPTER
- ⑤ TORO 1/2" CHECK VALVE (PCV-500)
- ⑥ 1/2" SCH 40 MALE ADAPTER.
- ⑦ BRICK (1 OF 2)
- ⑧ 1/2" SCH 40 PVC (LENGTH AS REQUIRED)
- ⑨ PVC LATERAL LINE SUPPLY. MINIMUM SIZE TO BE 1" UNLESS SIZED DIFFERENTLY ON DRAWINGS. USE SCH 40 PVC 1"x1"x1/2" TEE OR 90° ELBOW.



DRIPLINE-FLUSH POINT  
SCALE: NONE



AIR VACUUM RELIEF VALVE IN DRIPLINE  
SCALE: NONE



DRIPLINE MANIFOLD TO ELBOW CONNECTION  
SCALE: NONE



DRIPLINE TO PVC CONNECTION  
SCALE: NONE

REVISION:

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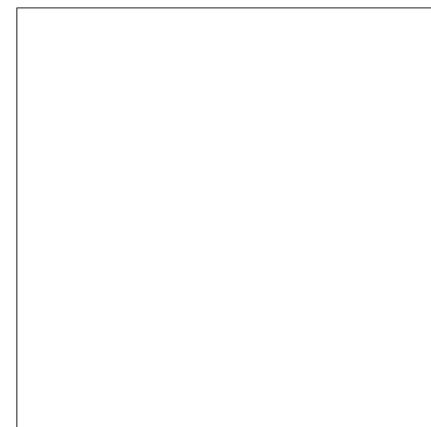
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PROJECT NO: PROJECT NAME:

APN: 036-031-280

PROJECT ADDRESS: 10th St Montara, CA 94037

PROJECT PHASE: **100% Schematic Design**

DRAWN: Jose Cruz CHECKED:


ISSUE DATE: 6/30/2021

DRAWING TITLE: **IRRIGATION DETAILS**

DRAWING NO: **IR-16**

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| NO.       | DESCRIPTION               | DATE       |
| 1         | DESIGN REVIEW APPLICATION | 5/11/2021  |
| 2         | PLN2021-00187 CYCLE 2     | 8/5/2021   |
| 3         | PLN2021-00187 CYCLE 3     | 12/21/2021 |

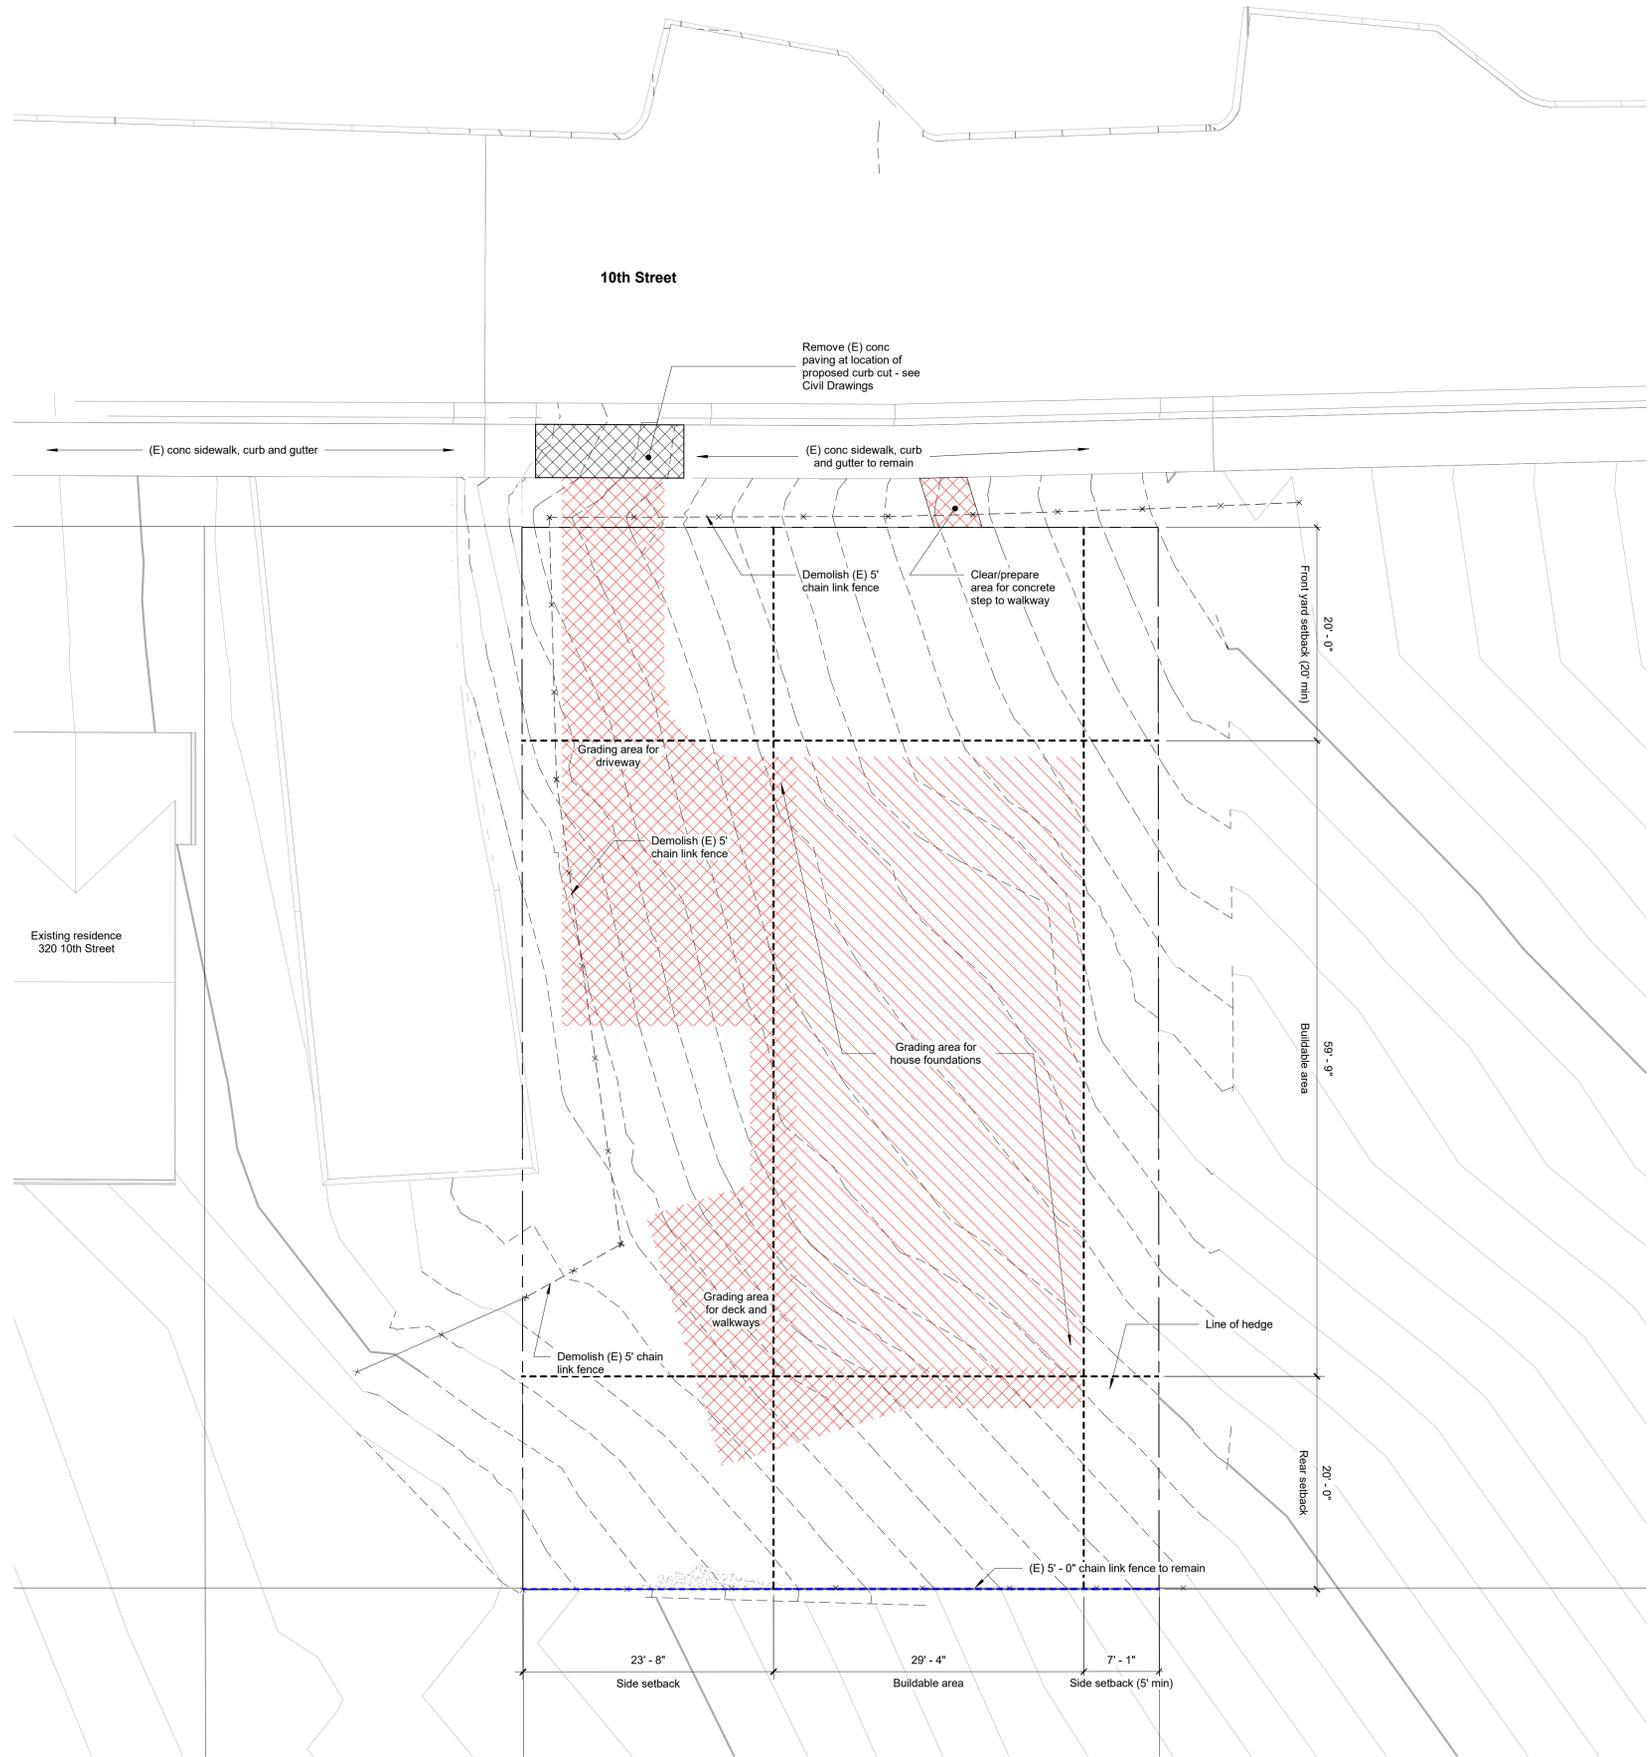

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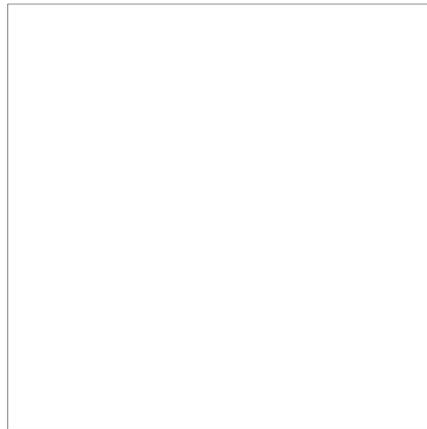
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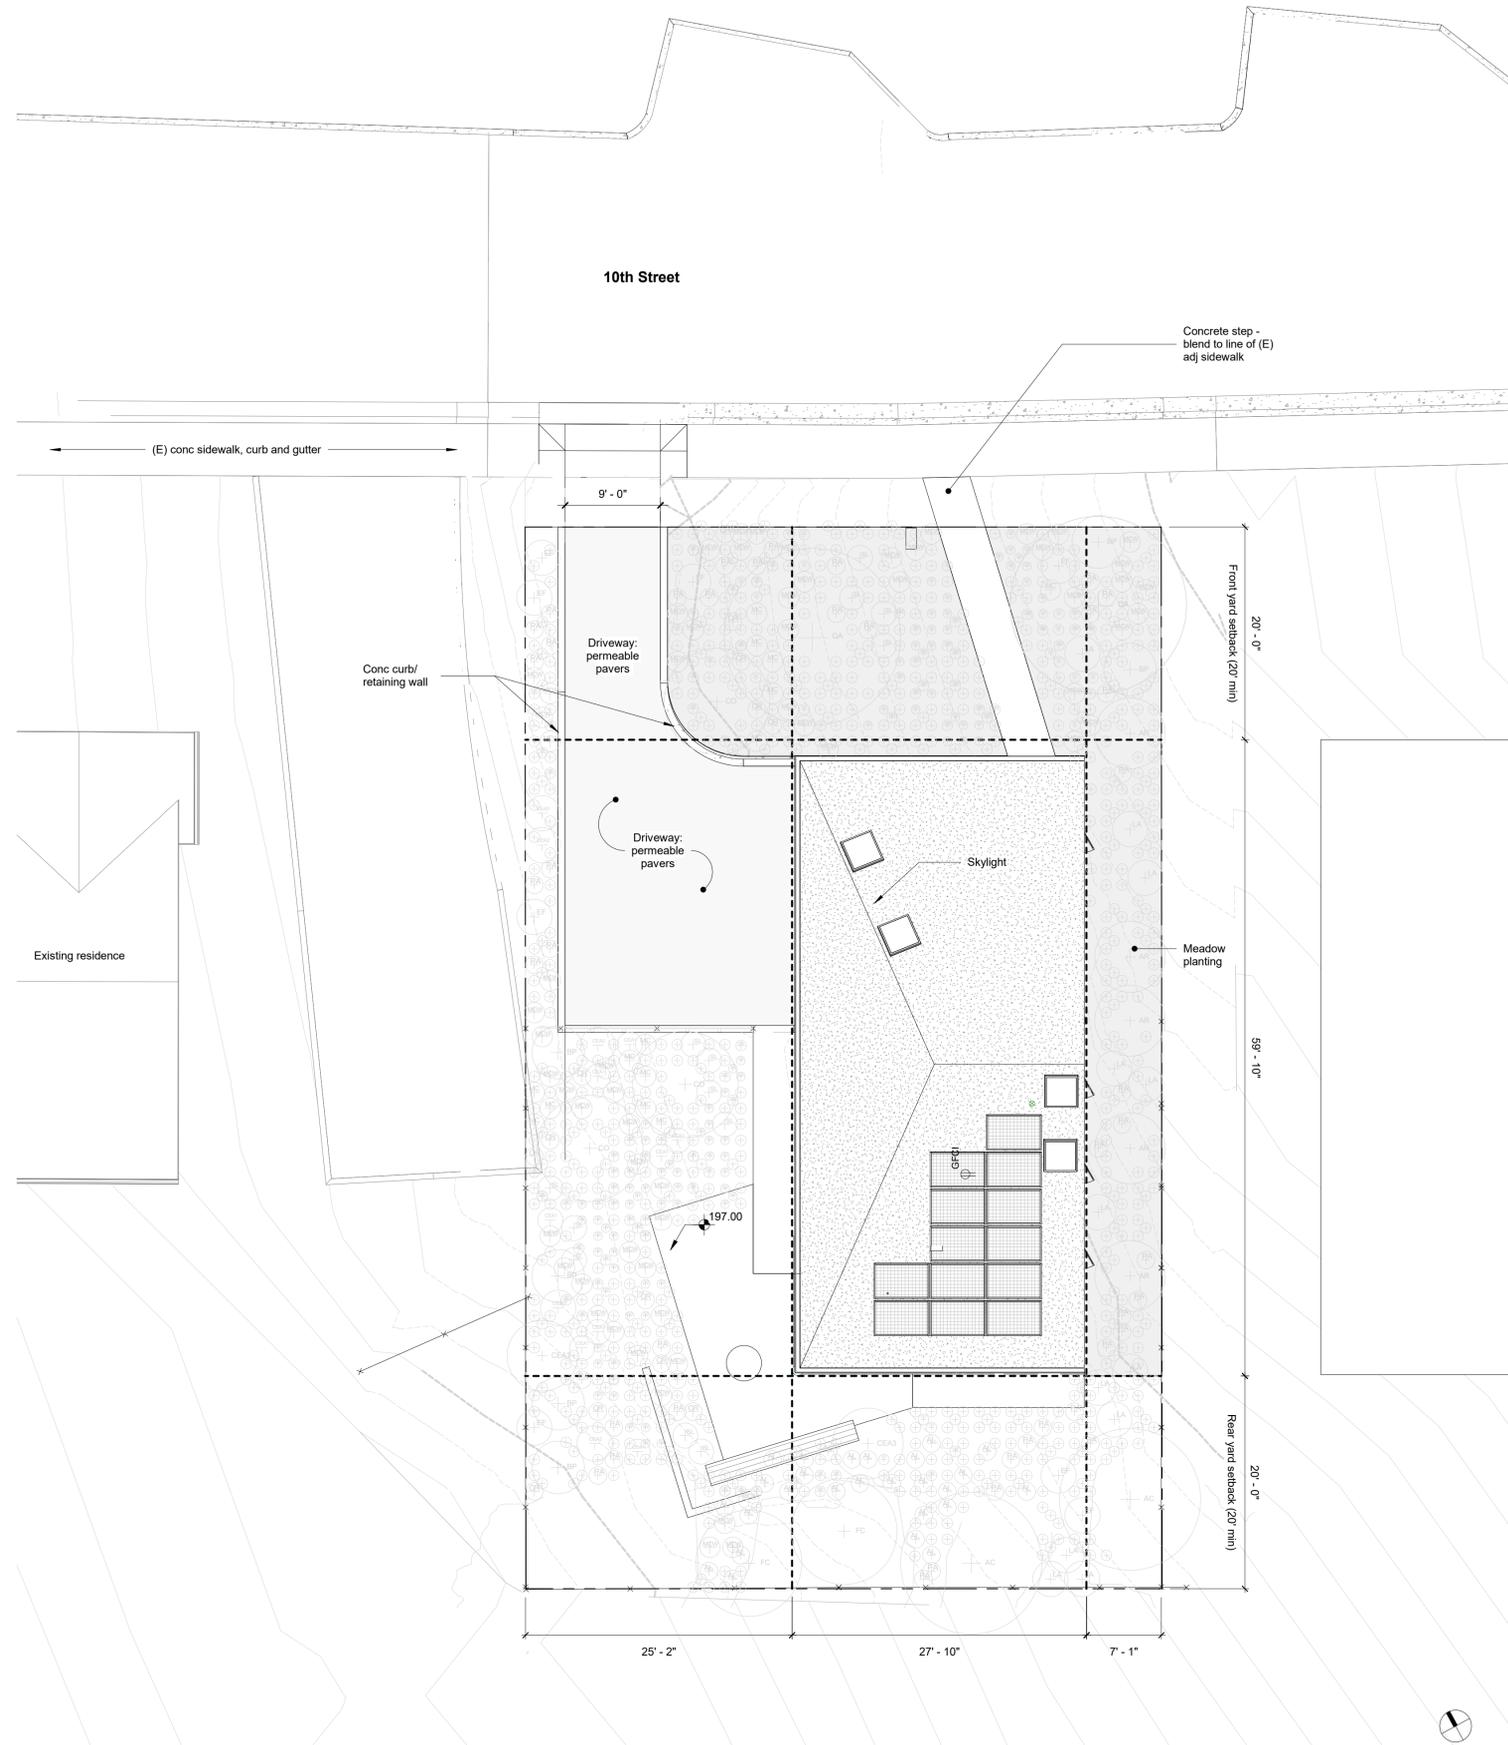


PROJECT NO: PROJECT NAME:  
**2101 House on a Hill**  
APN: 036-031-280  
PROJECT ADDRESS: 10th Street, Montara, CA 94037  
PROJECT PHASE: **Construction Documents**  
DRAWN: AG CHECKED Checker  
ISSUE DATE: 2/16/2022 9:03:05 PM  
DRAWING TITLE: **DEMOLITION SITE PLAN**

DRAWING NO: **A011**

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3 SITE PLAN  
1/8" = 1'-0"

| ELEMENT KEYNOTES |             |
|------------------|-------------|
| VALUE            | DESCRIPTION |

**Section 6300.2 Regulations for "S-17" Combining District (Midcoast)**

The following regulations shall apply in any single-family residential district with which the "S-17" District is combined.

**Building Site Width**  
The minimum building site width shall be an average of 50 feet.

*Building site is 60.07' wide*

**Building Site Area**  
The minimum building site area shall be 5,000 sq ft

*Building site area is 5,995 sq ft ±*

**Building Setbacks**  
The minimum setbacks shall be:

- Front setback: 20 ft
- Rear setback: 20 ft
- Side setback: 5 ft if 16 ft in height or less; combined 15 ft if over 16 ft in height with a minimum of 5 ft on any side

In any area where the "S-17" District is combined with the "DR" District, the minimum side yard setback may be reduced to provide for creative design concepts such as "zero" side yard setbacks provided that: (1) the Design Review Committee approves, (2) the application involves joint development of two or more adjacent parcels, (3) the total side yard requirement is met and (4) a minimum side yard of 5 feet is maintained adjacent to any parcel not included with the application.

**Parcel Coverage**  
The maximum parcel coverage shall be:

- a. For structures 16 feet in height or less: 50%.
- b. For structures greater than 16 feet in height: 35%.

Parcel coverage shall include all: (1) buildings, (2) accessory buildings, or (3) structures such as patios, decks, balconies, porches, bridges, and other similar uses which are eighteen (18) inches or more above the ground.

**Building Floor Area**  
The maximum building floor area shall be established according to the parcel size: 5,000 - 11,968 sq ft = 0.53 of parcel size (or 3,177 sq ft)

The maximum building floor area shall include the floor area of all stories of all buildings and accessory buildings on a building site. Maximum building floor area specifically includes:

- (1) gross floor area of all stories,
- (2) the area of all decks, porches, balconies or other areas covered by a waterproof roof, which extends four (4) or more feet from exterior walls,
- (3) the area of all garages and carports.

**Building floor area:**  
Ground floor (gross enclosed floor area, incl garage): 1,579 sf  
Second floor (gross enclosed floor area): 1,322 sf

*Second floor unoccupied exterior setback area (269 sf) extends 2' - 6" (>4' - 0") from the line of the exterior wall.*


Total building floor area: **2,901 sf** (< 3,177 sf)

**Impervious Surface Area.**  
The amount of parcel area covered by impervious structures less than eighteen inches (18") in height is limited to ten percent (10%) parcel size (not to exceed 1,170 sq. ft. for residential uses). Impervious structures include, but are not limited to, non-porous driveways, decks, patios, walkways and swimming pools.

Parcel size: 5,995 SF  
Parcel Coverage:  
Structures >16' in height: 1,576 SF = 26.22% (complies with 35% limit)  
Hardscape: 94 SF = 1.5% (complies with 10% limit)  
**Total: 1,670 SF (28%)**

Driveway (pervious) area: **752 SF**

COUNTY APPROVAL STAMP

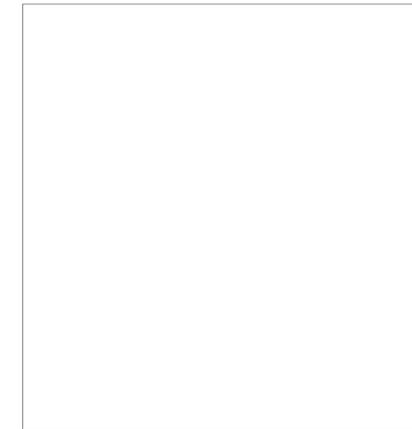

| REVISION: |                           |            |
|-----------|---------------------------|------------|
| NO.       | DESCRIPTION               | DATE       |
| 1         | DESIGN REVIEW APPLICATION | 5/11/2021  |
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CONSULTANT TEAM:  
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365 Flower Lane, Mountain View, CA 94043

LANDSCAPE ARCHITECTURE:  
Tomas McKay: Architecture-Landscape Architecture  
217 Bonita Avenue, Piedmont, CA 94611

IRRIGATION:  
Russell D Mitchell & Associates, Inc.  
2760 Camino Diablo, Walnut Creek, CA 94597

CLIENT:  
**Irene Chan-Jones and Bill Jones**  
100 Burlwood Drive, San Francisco, CA 94127

PROJECT NO: PROJECT NAME:  
**2101 House on a Hill**

APN: 036-031-280  
PROJECT ADDRESS: 10th Street, Montara, CA 94037

PROJECT PHASE: **Construction Documents**

DRAWN: AG CHECKED

ISSUE DATE: 2/16/2022 9:03:15 PM

DRAWING TITLE: **ARCHITECTURAL SITE PLAN**

DRAWING NO: **A112**

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**Section 6300.2 Regulations for "S-17" Combining District (Midcoast)**

**Building Height**

The maximum building height shall be established, as follows:

a. Up to 30% Slope. Where the average slope of the parcel area covered by the main residence is less than 30%, maximum building height is 28 feet.

The average slope on the subject property is less than 30% - project is governed by this height limit.


b. 30% Slope or Greater. Where the average slope of the parcel area covered by the main residence is 30% or greater, maximum building height is 28 feet, unless increased by the Design Review Committee.

The Design Review Committee may increase the maximum building height to 33 feet for either:


- (1) The center 40% of the house, or
- (2) The downslope wall. Where the downslope wall height limit is increased to 33 feet, maximum building height for the house shall be the plane formed by connecting the maximum upslope wall height (28 feet) with the maximum downslope wall height (33 feet).

Building height shall be measured as the vertical distance from any point on the natural grade to the topmost point of the building immediately above.


Finished grade, measured at the outside face of exterior perimeter walls, shall not significantly deviate from the natural grade, to the satisfaction of the Design Review Committee.

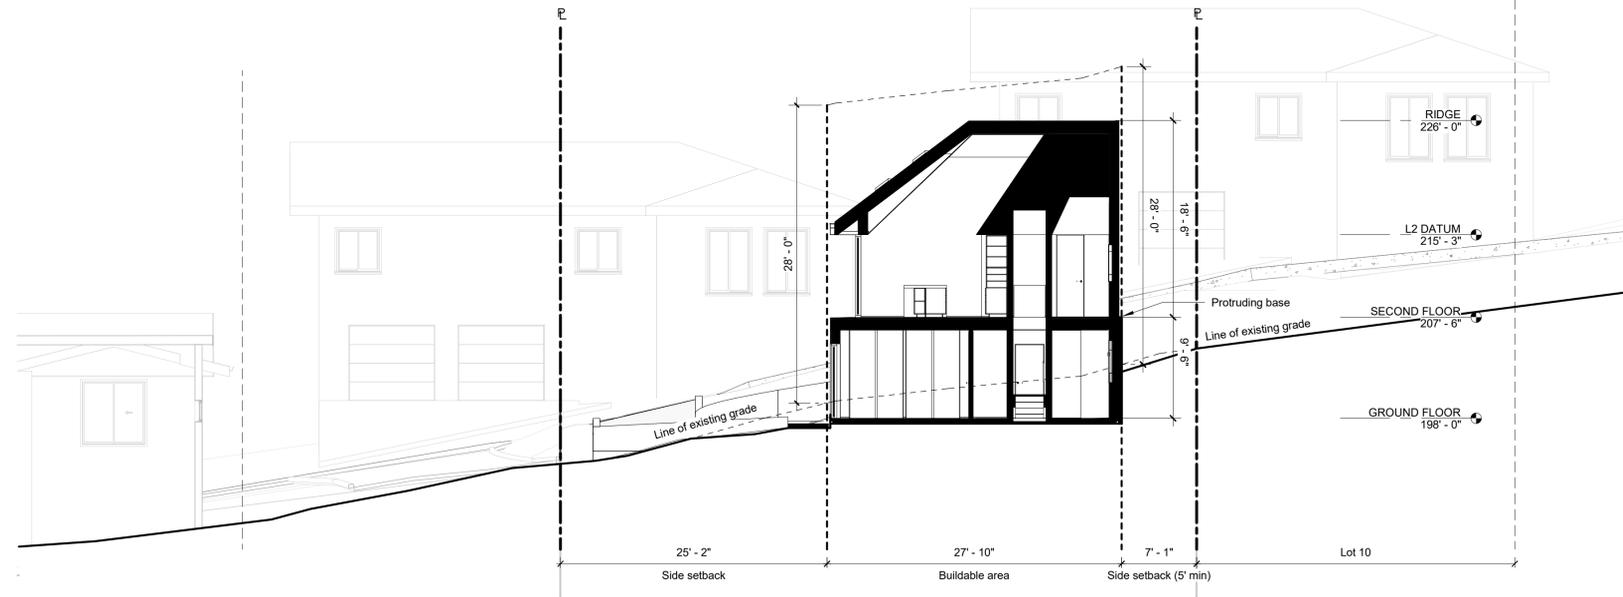

① E-W SITE SECTION AT HIGH RIDGE  
1/8" = 1'-0" REF 4 - A251

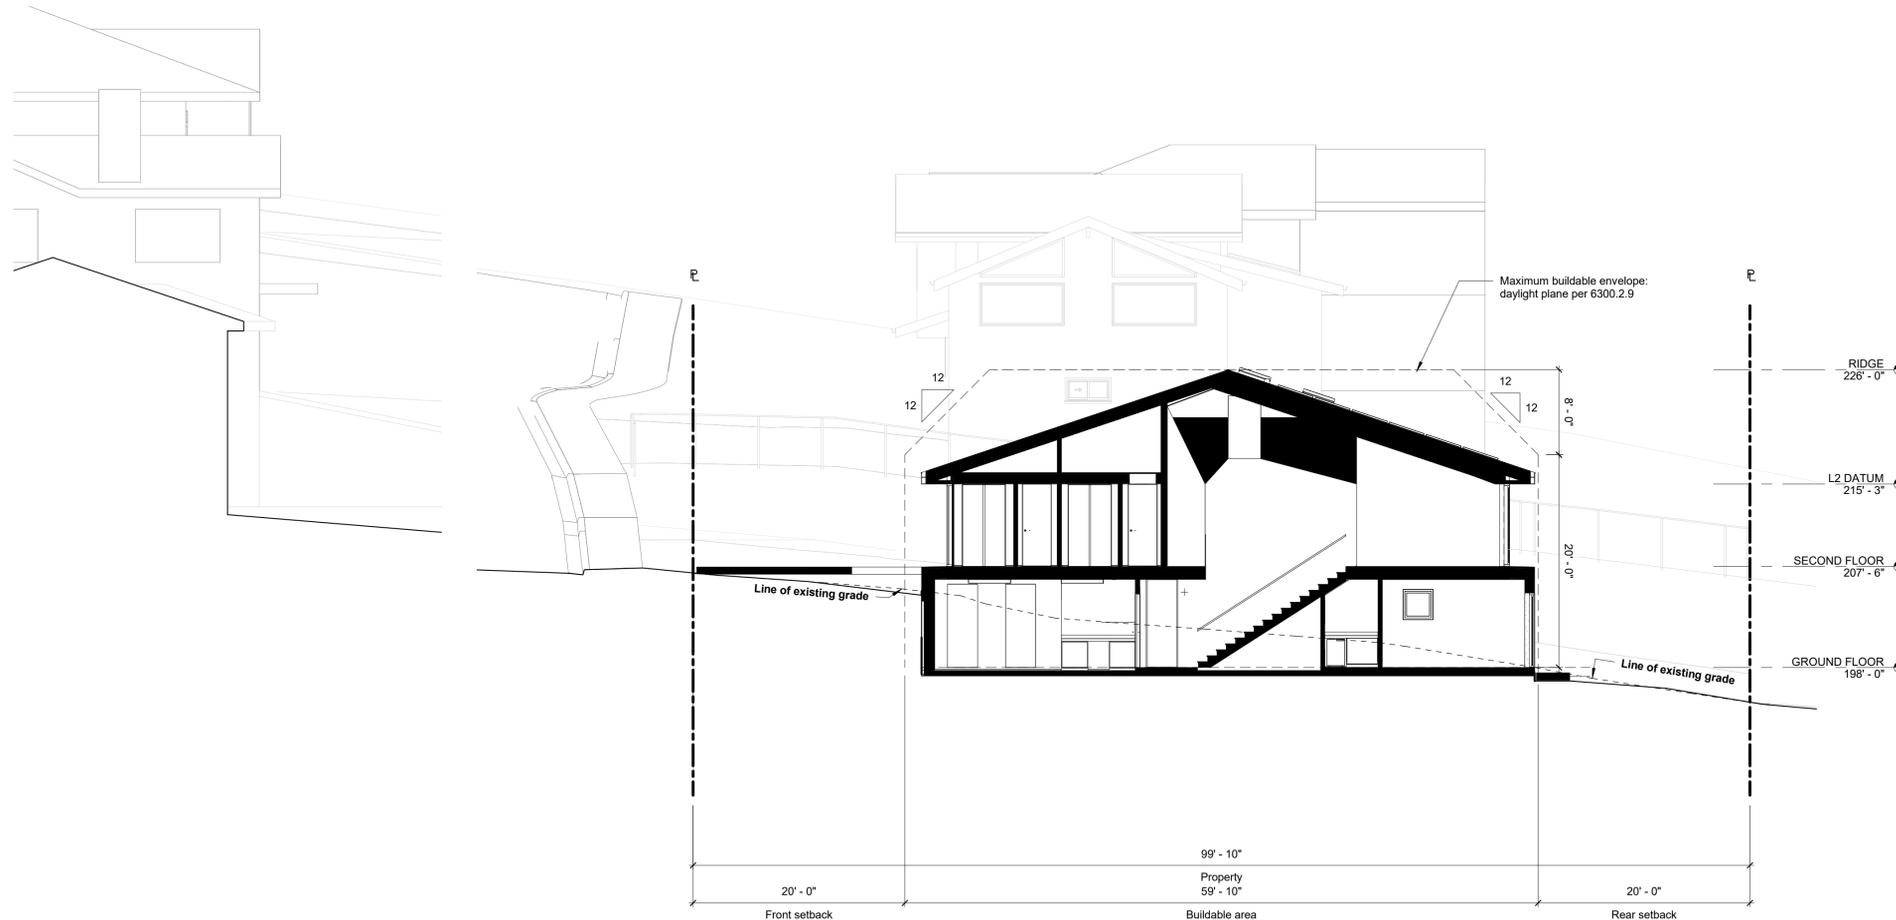

④ N-S SITE SECTION AT HIGH RIDGE  
1/8" = 1'-0"

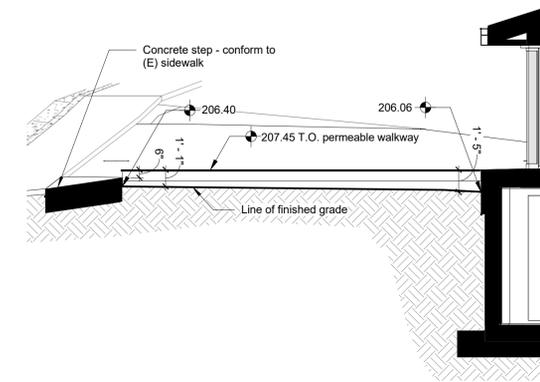

② SECTION AT ENTRY WALKWAY  
3/16" = 1'-0" REF 1 - A211

| REVISION: | NO. | DESCRIPTION               | DATE       |
|-----------|-----|---------------------------|------------|
|           | 1   | DESIGN REVIEW APPLICATION | 5/11/2021  |
|           | 2   | PLN2021-00187 CYCLE 2     | 8/5/2021   |
|           | 3   | PLN2021-00187 CYCLE 3     | 12/21/2021 |
|           | 4   | COASTSIDE DESIGN REVIEW   | 02/16/2022 |

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ARCHITECT:

**David Jaehning Architect**

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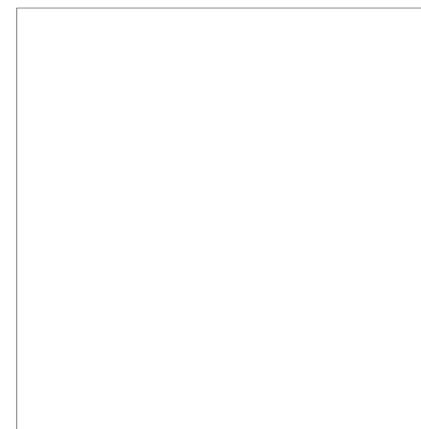
IRRIGATION:  
Russell D Mitchell & Associates, Inc.  
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CLIENT:

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COUNTY APPROVAL STAMP



PROJECT NO: PROJECT NAME:  
**2101 House on a Hill**

APN: 036-031-280

PROJECT ADDRESS: 10th Street, Montara, CA 94037

PROJECT PHASE: **Construction Documents**

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ISSUE DATE: 2/16/2022 9:03:17 PM

DRAWING TITLE: **ARCHITECTURAL SITE SECTIONS**

DRAWING NO: **A113**

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| ELEMENT KEYNOTES |                                      |
|------------------|--------------------------------------|
| VALUE            | DESCRIPTION                          |
| 03 31 00.J9      | 12" CAST-IN-PLACE CONCRETE MAT SLAB  |
| 03 31 00.M4      | 12" CAST-IN-PLACE CONCRETE WALL      |
| 22 33 00.A1      | WATER HEATER                         |
| 23 83 00.A1      | WALL-MOUNTED HYDRONIC HEATING MODULE |

| REVISION: |                           |            |
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| 3         | PLN2021-00187 CYCLE 3     | 12/21/2021 |

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**Flooring and Ceiling Type Legend**



- WD-1: 3/4" engineered wide-plank oak flooring
- C-1: Concrete slab-on-grade
- CT-1: 24" x 24" ceramic tile
- GYP-1: 5/8" gypsum board
- GYP-2: 5/8" Type 'X' gypsum board

| GROUND FLOOR AREAS |              |         |
|--------------------|--------------|---------|
| Number             | Name         | Area    |
| 105                | Guest Bdrm   | 128 SF  |
| 109                | Primary Bdrm | 133 SF  |
| 111                | Primary Bath | 55 SF   |
| 107                | Guest Bath   | 74 SF   |
| 101                | Garage       | 460 SF  |
| 110                | Closet       | 46 SF   |
| 103                | Hall         | 68 SF   |
| 102                | Mech         | 44 SF   |
| 108                | Den/Office   | 353 SF  |
| 113                | Linen        | 9 SF    |
| 106                | Closet       | 32 SF   |
| 104                | Stair        | 43 SF   |
| 108A               | Bar/Kitch    | 12 SF   |
| Grand total:       |              | 1457 SF |

**Ground floor**  
Gross occupied area: 1,579 sf  
Total gross occupied area (both floors): 2,901 sf

| Room name | Floor finish | Room number |
|-----------|--------------|-------------|
| 101       | WD-1         | A241        |

**COUNTY APPROVAL STAMP**

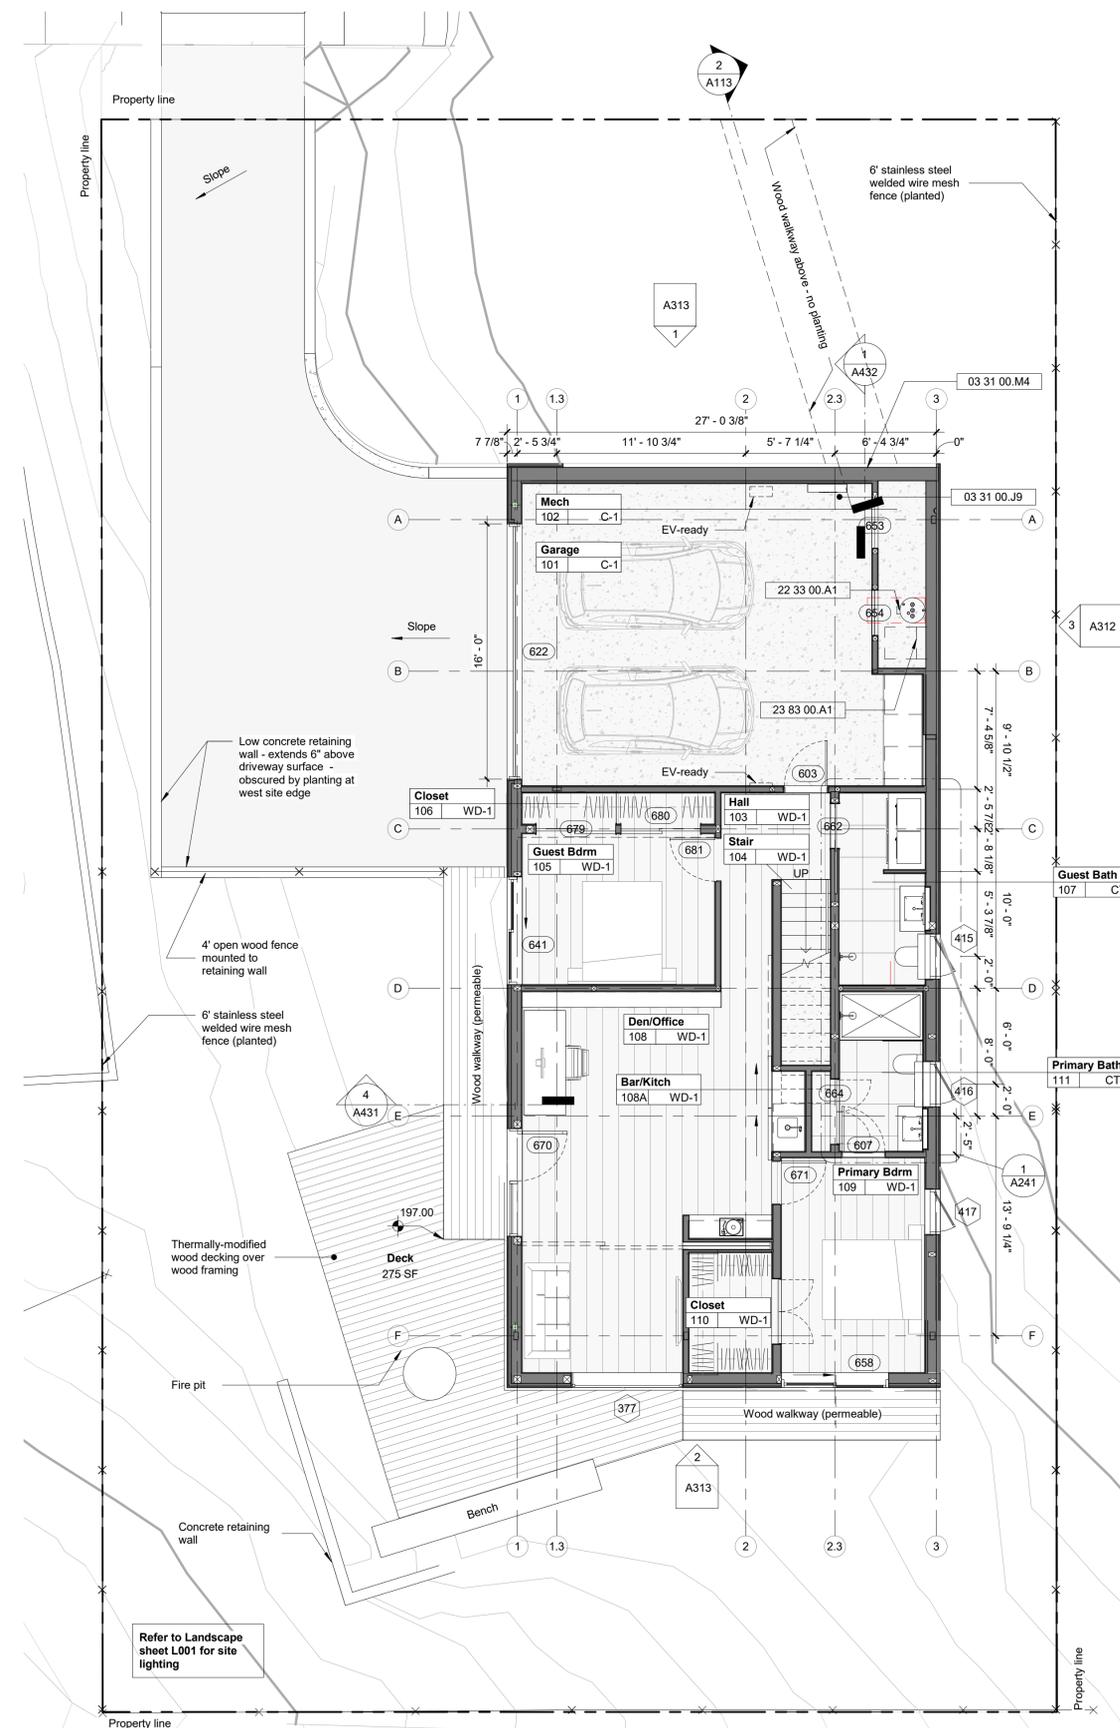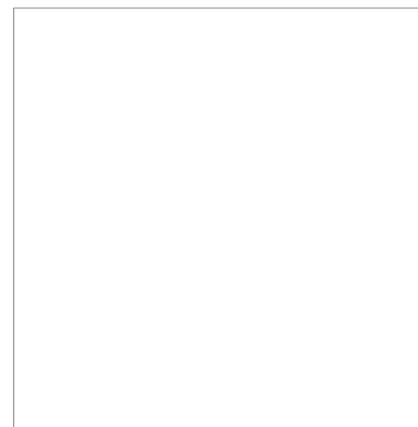

1 GROUND FLOOR PLAN  
3/16" = 1'-0"

ARCHITECT:

**David Jaehning Architect**

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PROJECT NO: PROJECT NAME:

**2101 House on a Hill**

APN: 036-031-280

PROJECT ADDRESS: 10th Street  
Montara, CA 94037

PROJECT PHASE: **Construction Documents**

DRAWN: AG CHECKED Checker

ISSUE DATE: 2/16/2022 9:03:20 PM

DRAWING TITLE: **GROUND FLOOR PLAN**

DRAWING NO: **A211**

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| ELEMENT KEYNOTES |  |
|------------------|--|
| VALUE            | DESCRIPTION  |
| 03 31 00.J10     | PERMEABLE CONCRETE DRIVEWAY - SEE CIVIL DETAILS                            |
| 06 15 33.A1      | THERMALLY MODIFIED 4" WOOD DECKING   |
| 09 64 00.C1      | 3/4" WIDE PLANK ENGINEERED OAK FLOORING                                    |
| 10 55 23.A1      | STAINLESS STEEL POST-MOUNTED MAILBOX WITH RAISED BUILDING ADDRESS NUMERALS |

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| 3         | PLN2021-00187 CYCLE 3     | 12/21/2021 |

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PROJECT NO: PROJECT NAME:  
**2101 House on a Hill**  
APN: 036-031-280  
PROJECT ADDRESS: 10th Street, Montara, CA 94037  
PROJECT PHASE: **Construction Documents**  
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DRAWING TITLE: **SECOND FLOOR PLAN & ROOF PLAN**

DRAWING NO: **A212**

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**Flooring and Ceiling Type Legend**



- WD-1: 3/4" engineered wide-plank oak flooring
- C-1: Concrete slab-on-grade
- CT-1: 24" x 24" ceramic tile
- GYP-1: 5/8" gypsum board
- GYP-2: 5/8" Type 'X' gypsum board

| SECOND FLOOR AREAS |             |         |
|--------------------|-------------|---------|
| Number             | Name        | Area    |
| 203                | Hall Closet | 15 SF   |
| 206                | Bath 1      | 46 SF   |
| 204                | Bedroom 1   | 168 SF  |
| 201                | Entry Hall  | 176 SF  |
| 210                | 1/2 Bath    | 25 SF   |
| 207                | Kitchen     | 251 SF  |
| 205                | Bedroom 2   | 161 SF  |
| 209                | Living      | 210 SF  |
| 202                | Hall Closet | 16 SF   |
| 208                | Dining      | 135 SF  |
| Grand total:       |             | 1204 SF |

**Second floor**  
Gross occupied area: 1,322 sf  
Total gross occupied area (both floors): 2,901 sf

| Room name | Floor finish | Room number |
|-----------|--------------|-------------|
| 101       | WD-1         |             |

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1 ROOF PLAN  
3/16" = 1'-0" REF 1 - A113

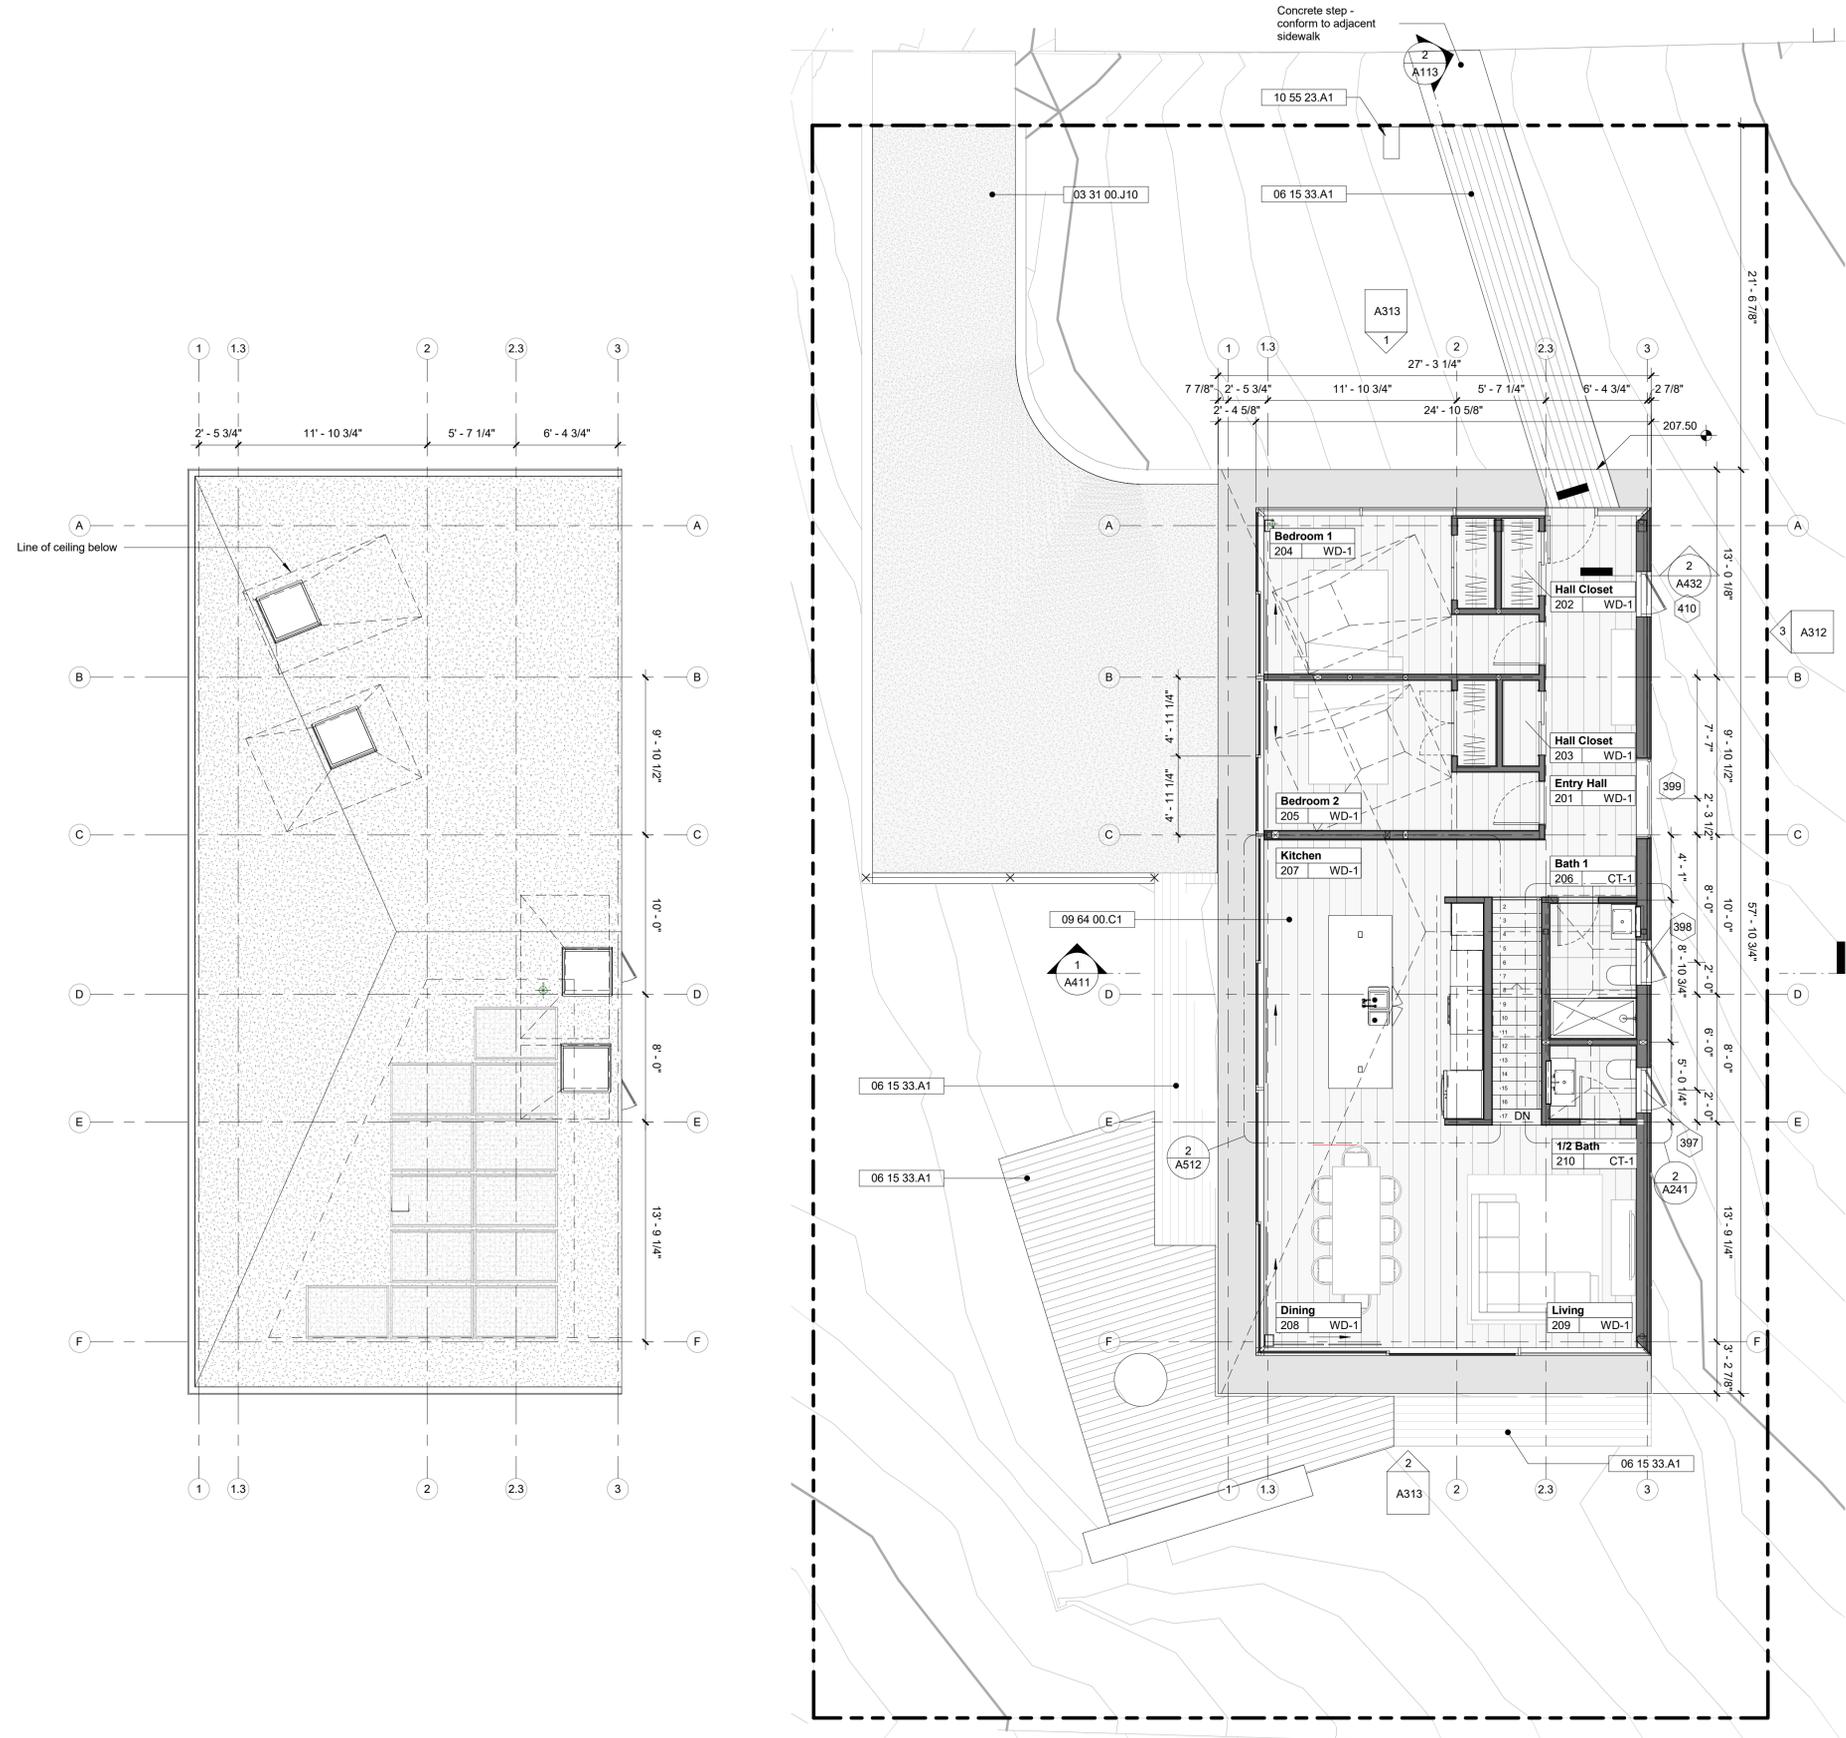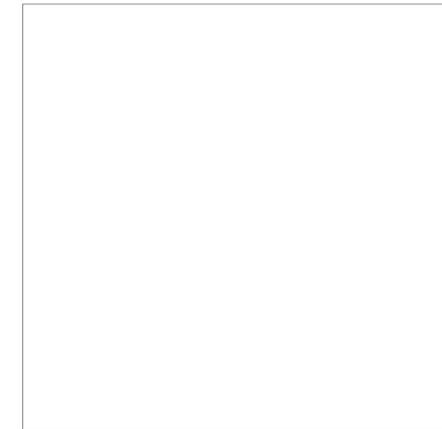2 SECOND FLOOR PLAN  
3/16" = 1'-0"

| NO. | DESCRIPTION               | DATE       |
|-----|---------------------------|------------|
| 1   | DESIGN REVIEW APPLICATION | 5/11/2021  |
| 2   | PLN2021-00187 CYCLE 2     | 8/5/2021   |
| 3   | PLN2021-00187 CYCLE 3     | 12/21/2021 |
| 4   | COASTSIDE DESIGN REVIEW   | 02/16/2022 |



**Section 6300.2.9.a** Cornices, canopies, eaves, roof overhangs, chimneys, fire escapes, stairways, landing places, uncovered porches, and similar architectural features may extend into the daylight plane at the front, side, or rear yard, to the extent allowed by Zoning Regulations Section 6406.

**Section 6406** For the purpose of computing front yard dimensions the measurement shall be taken from the nearest point of the front wall of the building to the street line, provided, however, that if an Official Plan Line has been established for the street, then the measurement shall be taken from the nearest point of the front wall of the building to such Official Plan Line, except that the certain architectural features hereinafter enumerated shall not be considered in making such measurements:  
 (a) Cornices, canopies, eaves, chimneys, or any other architectural features may extend into said front, side, or rear yard, a distance not exceeding two (2) feet, provided that no such architectural feature shall extend to within two (2) feet of any side or rear lot line.

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**David Jaehning Architect**  
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CONSULTANT TEAM:  
 STRUCTURAL/CIVIL:  
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 365 Flower Lane, Mountain View, CA 94043

LANDSCAPE ARCHITECTURE:  
 Tomas McKay: Architecture-Landscape Architecture  
 217 Bonita Avenue, Piedmont, CA 94611


IRRIGATION:  
 Russell D Mitchell & Associates, Inc.  
 2760 Camino Diablo, Walnut Creek, CA 94597

CLIENT:  
**Irene Chan-Jones and Bill Jones**  
 100 Burlwood Drive, San Francisco, CA 94127

1 WEST ELEVATION  
 1/4" = 1'-0" REF 1 - A003

| Building materials legend |   |
|---------------------------|---|
|                           | A1. Exterior walls<br>Elastomeric masonry coating over smooth cement plaster rainscreen: Sto StoColor Lastic elastomeric coating (StoColor 37302) |
|                           | A2. Exterior walls<br>Elastomeric masonry coating over smooth cement plaster rainscreen: Sto StoColor Lastic elastomeric coating (StoColor 37300) |
|                           | B. Trim<br>Elastomeric coating over sheet metal: Sto StoColor Lastic elastomeric coating (StoColor 37304)   |
|                           | C. Window frames<br>Anodized aluminum: C31 Bronze Anodized (Reynaers)   |
|                           | D. Doors<br>Anodized aluminum: C31 Bronze Anodized (Reynaers)   |
|                           | E. Roof<br>Elastomeric masonry coating over smooth cement plaster rainscreen: Sto StoColor Lastic elastomeric coating (StoColor 37302)            |
|                           | G. Decks and railings<br>Thermally-modified ash decking   |
|                           | I. Retaining walls<br>Reinforced poured concrete - light sandblast finish   |


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PROJECT NO: PROJECT NAME:  
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 APN: 036-031-280  
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 DRAWING TITLE: **ELEVATIONS**  
 DRAWING NO: **A311**
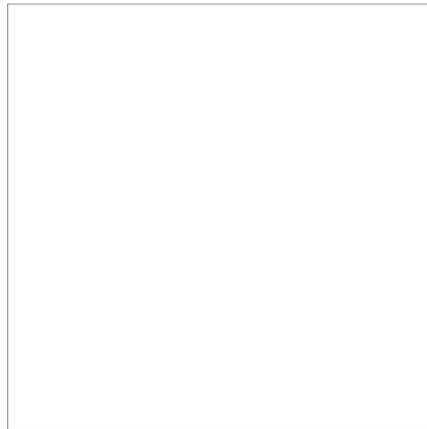
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| 4            | COASTSIDE DESIGN REVIEW   | 02/16/2022 |



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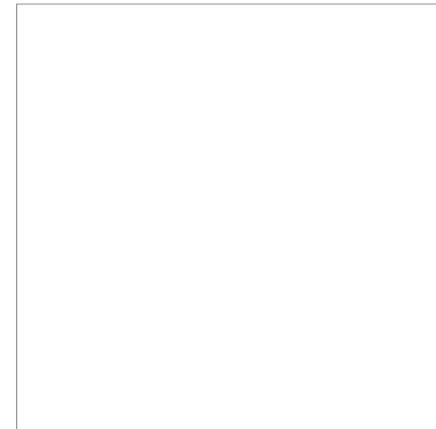
CLIENT:  
**Irene Chan-Jones and Bill Jones**  
100 Burlwood Drive, San Francisco, CA 94127

3 EAST ELEVATION  
1/4" = 1'-0" REF 1 - A211

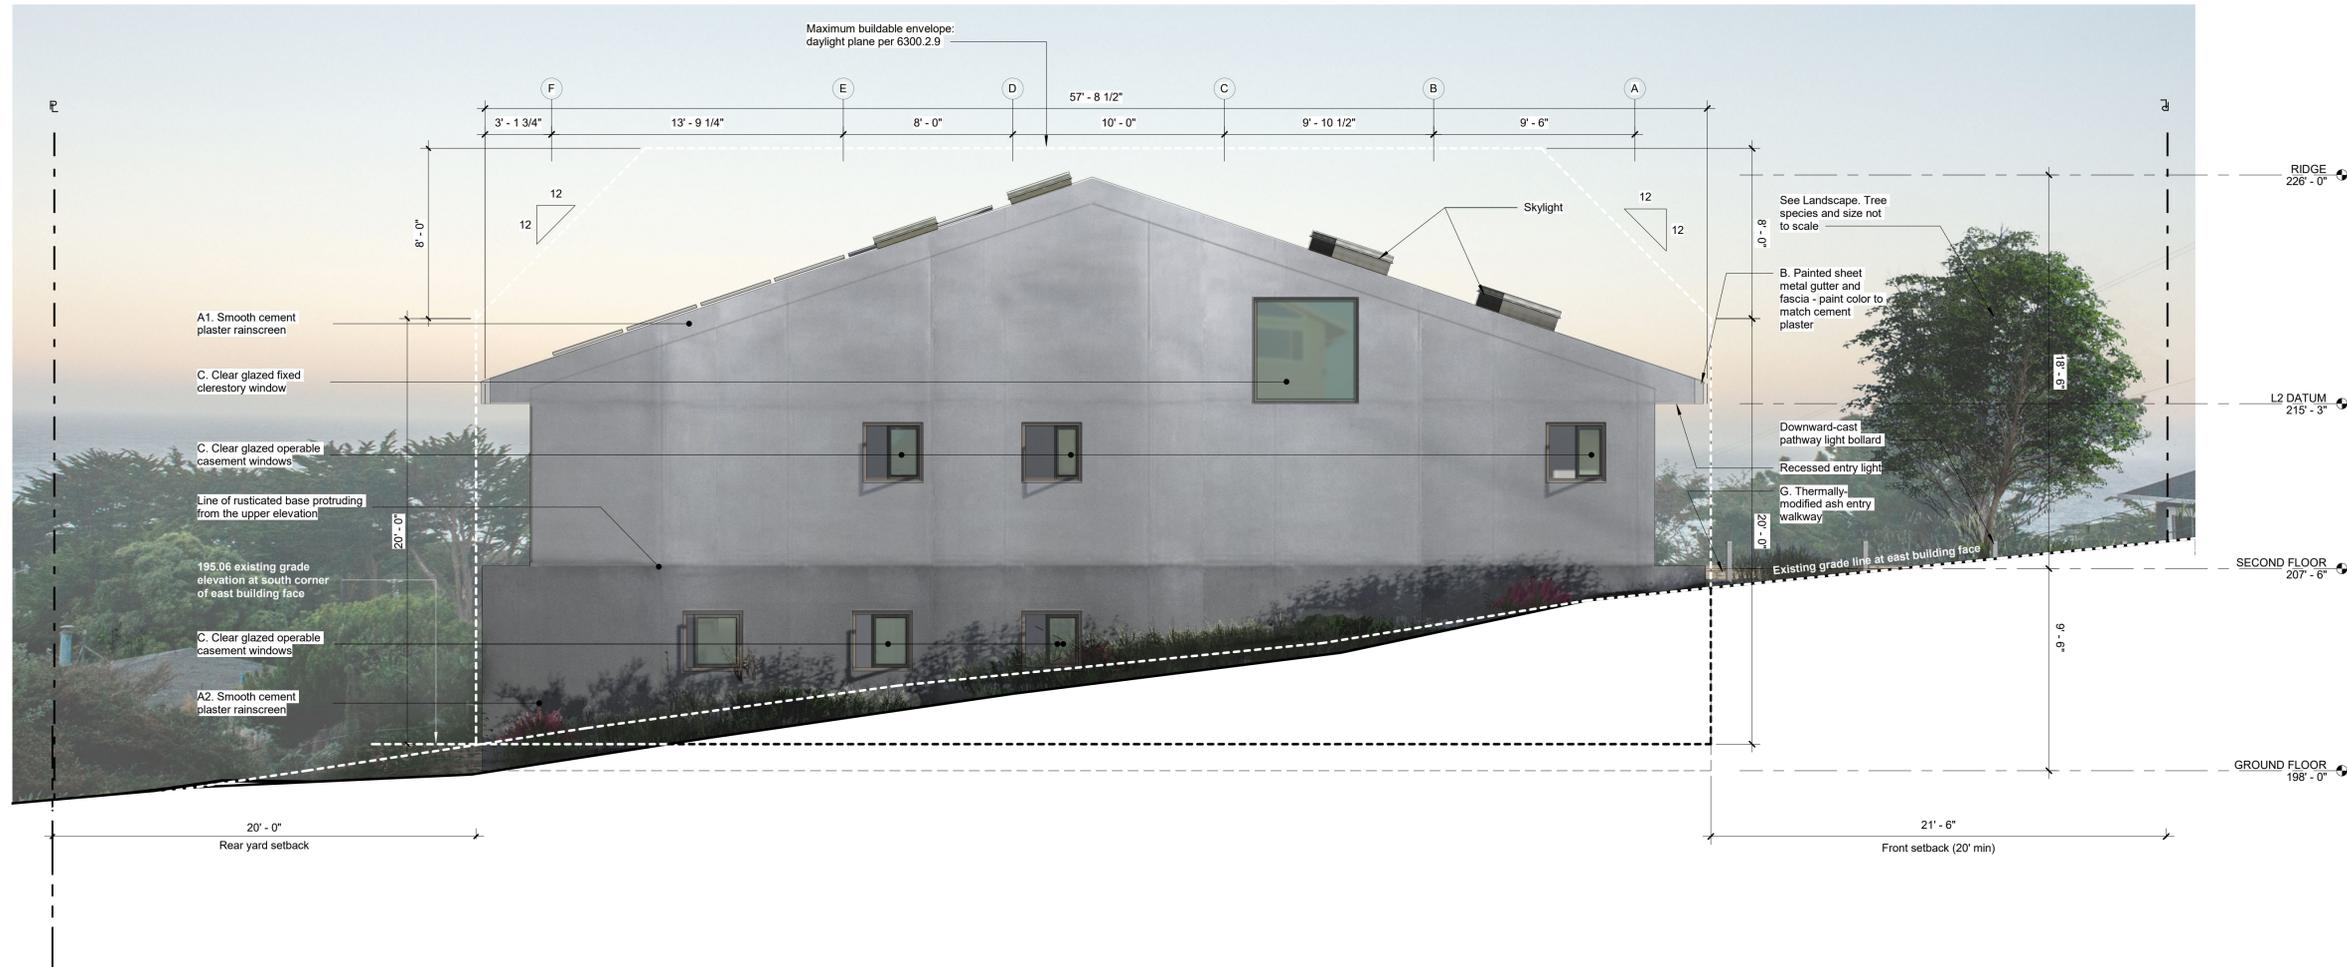**Building materials legend**

|  |   |  |  |
|--|---|--|--|
|  | A1. Exterior walls<br>Elastomeric masonry coating over smooth cement plaster rainscreen: Sto StoColor Lastic elastomeric coating (StoColor 37302) |  | D. Doors<br>Anodized aluminum: C31 Bronze Anodized (Reynaers)  |
|  | A2. Exterior walls<br>Elastomeric masonry coating over smooth cement plaster rainscreen: Sto StoColor Lastic elastomeric coating (StoColor 37300) |  | E. Roof<br>Elastomeric masonry coating over smooth cement plaster rainscreen: Sto StoColor Lastic elastomeric coating (StoColor 37302) |
|  | B. Trim<br>Elastomeric coating over sheet metal: Sto StoColor Lastic elastomeric coating (StoColor 37304)   |  | G. Decks and railings<br>Thermally-modified ash decking  |
|  | C. Window frames<br>Anodized aluminum: C31 Bronze Anodized (Reynaers)   |  | I. Retaining walls<br>Reinforced poured concrete - light sandblast finish  |

COUNTY APPROVAL STAMP




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PROJECT PHASE: **Construction Documents**  
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DRAWING TITLE: **ELEVATIONS**  
DRAWING NO: **A312**

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**Building materials legend**

- A2. Exterior walls**  
Elastomeric masonry coating over smooth cement plaster rainscreen; Sto StoColor Lastic elastomeric coating (StoColor 37300)
- B. Trim**  
Elastomeric coating over sheet metal; Sto StoColor Lastic elastomeric coating (StoColor 37304)
- C. Window frames**  
Anodized aluminum: CH1 Champagne Anodized New Silver (Reynaers)
- D. Doors**  
Anodized aluminum: CH1 Champagne Anodized New Silver (Reynaers)
- E. Roof**  
Elastomeric masonry coating over smooth cement plaster rainscreen; Sto StoColor Lastic elastomeric coating (StoColor 37304)
- G. Decks and railings**  
Thermally-modified ash decking
- I. Retaining walls**  
Reinforced poured concrete - light sandblast finish

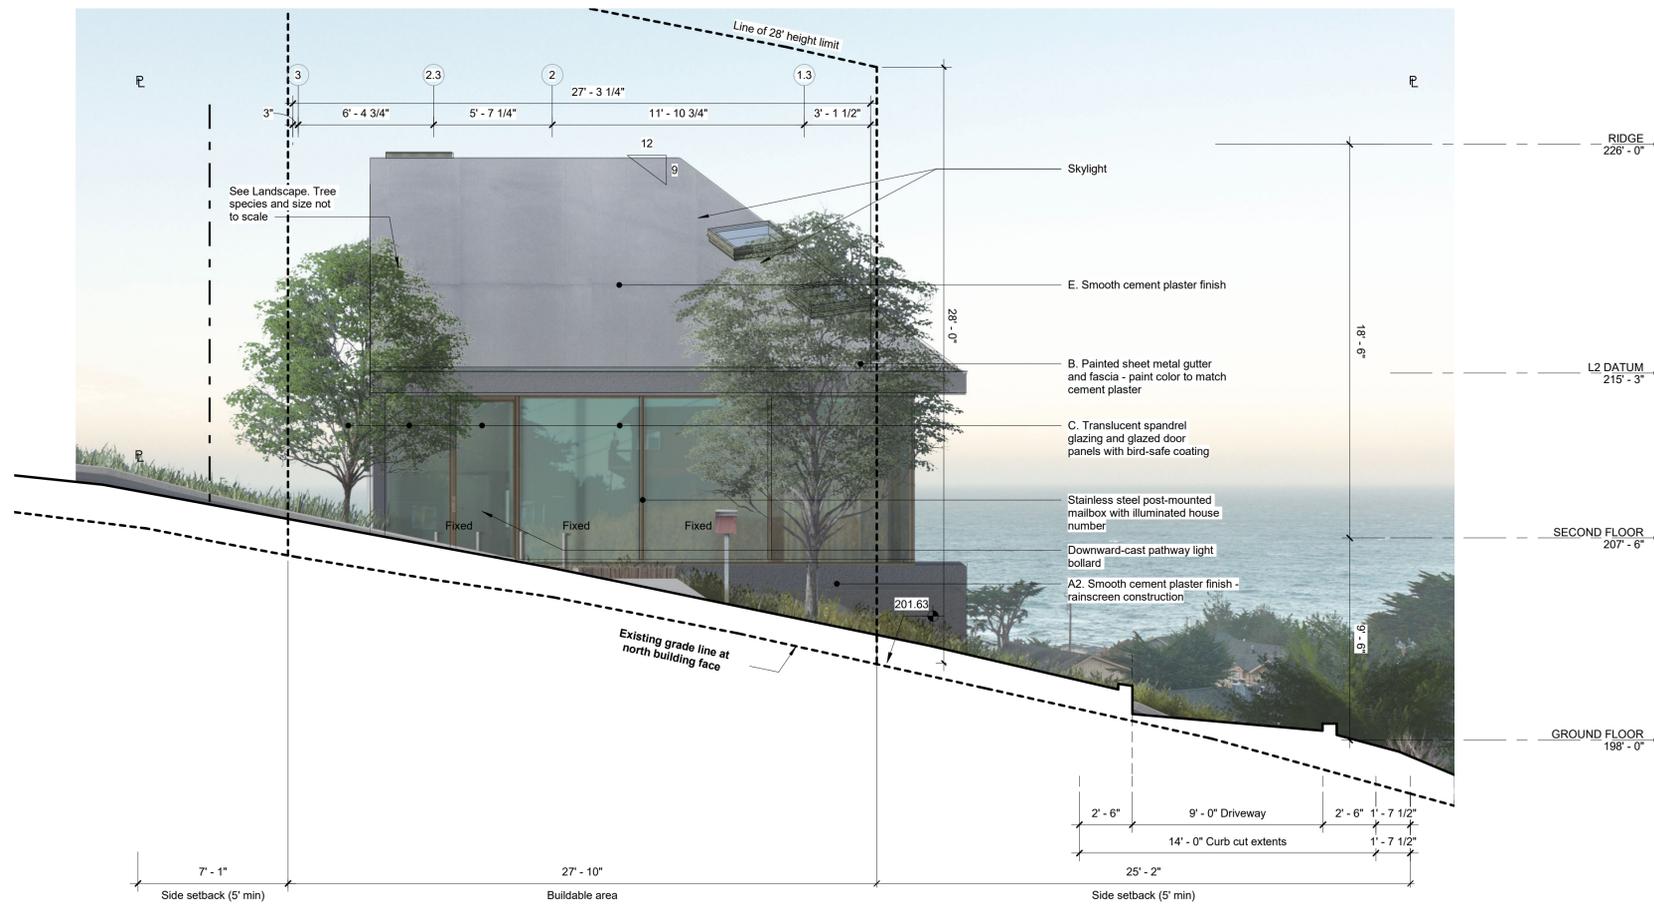

① NORTH ELEVATION  
1/4" = 1'-0" REF 1 - A211

| NO. | DESCRIPTION               | DATE       |
|-----|---------------------------|------------|
| 1   | DESIGN REVIEW APPLICATION | 5/11/2021  |
| 2   | PLN2021-00187 CYCLE 2     | 8/5/2021   |
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CLIENT:  
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**6300.2.6 Building Height**

The maximum building height shall be established, as follows:

- a. Up to 30% Slope. Where the average slope of the parcel area covered by the main residence is less than 30%, maximum building height is 28 feet.
- b. 30% Slope or Greater. Where the average slope of the parcel area covered by the main residence is 30% or greater, maximum building height is 28 feet, unless increased by the Design Review Committee.

**6300.2.9 Daylight Plane or Façade Articulation**


New residential development shall conform to either the daylight plane or façade articulation options described in this section, as determined by the project applicant.

- a. Daylight Plane Option  
The daylight plane shall be established on two opposite house sides, i.e., either from the front and rear setback lines, or from the side setback lines, as determined by the project applicant and approved by the Design Review Committee.

The daylight plane shall be measured from the setback line at natural grade, upward a vertical distance of 20 feet, and then inward at an angle of 45° until the maximum building height is reached.

Cornices, canopies, eaves, roof overhangs, chimneys, fire escapes, stairways; landing places; uncovered porches, and similar architectural features may extend into the daylight plane at the front, side, or rear yard, to the extent allowed by Zoning Regulations Section 6406.

COUNTY APPROVAL STAMP

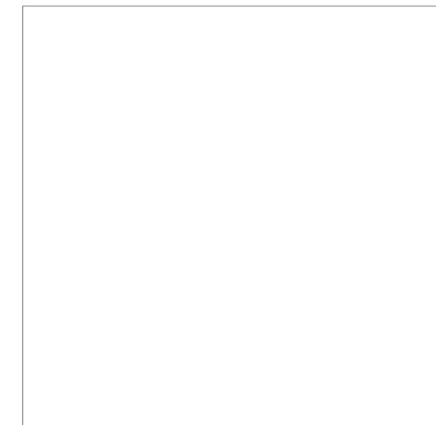

PROJECT NO: PROJECT NAME:  
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APN: 036-031-280

PROJECT ADDRESS: 10th Street, Montara, CA 94037

PROJECT PHASE: **Construction Documents**

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DRAWING TITLE: **ELEVATIONS**

DRAWING NO: **A313**

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② SOUTH ELEVATION  
1/4" = 1'-0" REF 1 - A211