#### San Mateo County

## **Planning Permit Application Form**

#### Planning and Building Department

455 County Center, 2nd Floor • Redwood City CA 94063
Mail Drop: PLN 122 • TEL (650) 363-4161 • FAX (650) 363-4849
www.co.sanmateo.ca.us/planning
PLN: 2019 - 00231

valefolitationalamentaliste (assettle)	
Applicant: Jennifer M. Randle	
Mailing Address: 2125 Bryant St., Apt 107	
San Francisco, CA	zip: 94107
Phone, W:	н: 917-5470203
E-mail Address: jmareerandle@gmail.com	FAX:
Name of Owner (1): Same	Name of Owner (2): n/a
Mailing Address:	Mailing Address:
:	
Zip:	Zip:
Phone,W:	Phone,W:
H:	H:
E-mail Address:	E-mail Address:
Hojew-lifennedom:	
Project Location (address):	Assessor's Parcel Numbers:
Vacant Lot 14, Block 1	047 — 153 — 240
El Granada Highlands	
Zoning:	Parcel/lot size: 4750 SF (Square Feet)
· · · · · · · · · · · · · · · · · · ·	
	ructures, wells, or tanks are proposed. Project will connect to
unities in adjacent street.	
Describe Existing Site Conditions/Features (e.g. topog	graphy, water bodies, vegetation):
The existing site is a vacant lot covered in approximation	ately 30% dense vegetation. There is one tree, which will
Describe Existing Structures and/or Development:	
Zip: Zip:  Phone,W: H: H: E-mail Address:  E-mail Address:  Project Location (address): Vacant Lot 14, Block 1 El Granada Highlands  Zip:  Phone,W: H:  Assessor's Parcel Numbers:  047 — 153 — 240 / —  El Granada Highlands	
Signatura	
of the application is true and correct to the best of or through our assigned plaject planner and any change	and on forms, plans and other materials submitted herewith in support or knowledge. It is our responsibility to inform the County of San Mateo st to information represented in these submitalls.
Owner's signature	
Owner's signature	
Applicant's signature:	N. C. annu
The same of the sa	£\web stuff\P8Site\pdf\Form\22054

#### San Mateo County

#### Planning and Building Department

## Application for a Coastal Development Permit

455 County Center , 2nd Floor • Redwood City, CA 94063 Mail Drop: PLN 122 • TEL (650) 363-4161 • FAX (650) 363-4849

#### **Companion Page**

Applicant's Name:	Jennifer M. Randle	
Primary Permit #:		

#### de la Gradio de la Constantion de la Constantion

Please fill out the general Planning Permit Application Form and this form when applying for a Coastal Development Permit. You must also submit all items indicated on the checklist found on the reverse side of the Planning Permit Application Form.

2 Pasic Information	
Does the owner or applicant own any adjacent property not listed?   Yes  No	Have you or anyone else previously applied to either the County of San Mateo or the California Coastal Commission for a Coastal Development Permit for this or a similar project at this location?  I Yes  No
If yes, list Assessor's Parcel Number(s):	If yes, explain (include date and application file numbers).

#### Shivered as an out and not be a second the second and the second a

Note: By completing this section you do not need to file a separate application for Design Review Approval.

Fill in Blanks:	Material	Color/Finish	Check if matches existing
	Corrugated Metal, Plaster, Glass	Grey, Grey, Clear	
a. Exterior Walls b. Trim	Formed aluminum panel	Grey	
c. Roof	Single Ply Membrane	TBD	_ 🗆
d. Chimneys	N/A		
e. Accessory Buildings	N/A		
f. Decks/Stairs	Wood, Ipe or similar	Natural	
g. Retaining Walls	Concrete	Board Formed	
h. Fences	Wood, Ipe or similar	Natural	
i. Storage Tanks	N/A		

4: Project Information					
Does this project, the parcel on which it is local immediate vicinity involve or include:	ated or t	the .	p. Between the sea and the nearest public road?		Ø
	Yes	No	q. Existing or proposed provisions for public access to the shoreline?		Ø
a. Demolition of existing housing units? (If yes, give value of owner-occupied		Ø	r. Public or commercial recreation facilities?		<b>7</b>
units or current monthly rent of rental units in explanation below.)			s. Visitor-serving facilities?		Ø
b. Creeks, streams, lakes or ponds?		V	t. Existing or proposed public trail		,,,,,,
c. Wetlands (marshes, swamps, mudflats)?		V	easements?	L	V
d. Beaches?		Ø	Explain all Yes answers below. Indicate		
e. Sand Dunes?		<b>7</b>	item applies to the project itself, the parcel on located, or the immediate vicinity (attach addi		
f. Sea cliff, coastal bluffs or blufftops?		· 🗹	necessary):		
g. Ridgetops?		Ø	Project proposes to remove existing vegetat		
h. Pampas Grass, invasive brooms or		Ø	Project proposes to cut approx. 16	0 cy o	f fill
Weedy Thistle?			Project proposes new landscaping	, see p	plans
i. Removal of trees or vegetation?	V		Project proposes new water and sewer	r conne	ctions
j. Grading or alteration of landforms?	V				
k. Landscaping?	☑				
I. Signs?		7		<del> </del>	
m. Phone or utility line extensions or connections, either above or below ground (explain which)?	Ø				
n. Areas subject to flooding?		<b>V</b>		•	
o. Development on slopes 30% or steeper?		V			
5. StaffUse Only					
California Coastal Commission Juri	isdictio	on	Commission; a public hearing is always requir	red.	
A. Does the Proposed Project Involve:			<b>B.</b> Does the proposed project involve lands b		
<ol> <li>A subdivision, Certificate of Compliance Type</li> <li>Permit, or Planned Agricultural District Perm</li> </ol>		e	high tide line and lands where the public (See "Post CCP Certification Permit and Ap Map).		
☐ Yes ☐ No			Yes  No		
2. Construction or grading within 100 feet of wetland?	a strear	n or			
☐ Yes ☐ No			Yes to above means that the California Coasta		
3. A parcel located between the sea and the through road paralleling the sea; 300 feet the extent of any beach or mean high tide line beach; or within 300 feet of the top of the a coastal bluff?	from the	inland is no	retains permit jurisdiction over all or part of the project. A Coastal Development Permit from the required.  Reviewed by:		
☐ Yes ☐ No					
Yes to any one of the above means that the Coevelopment Permit is appealable to the Coevelopment					

#### San Mateo County

#### Application for Design Review by the **County Coastside Design Review Committee**

WILL CONNECT TO UTILITIES IN

STREET

ADI

#### Planning and Building Department

County Government Center = 455 County Center = Redwood City CA 94063 Mail Drop PLN 122 = 650 - 363 - 4161 = FAX 650 - 363 - 4849 Permit #: PLN \_\_ Other Permit #: 1. Basic Information Applicant: Owner (if different from Applicant): JENNIFER M. RANDLE Name: SAME Name: 2125 BRYANT ST, APT 107 Address: Address: Zip: 44107 Zip: Phone, W: 417 547-0203 Phone,W: 1Manaerandleognail.com Email: Architect or Designer (if different from Applicant): WALTER Name: 9ATES ST. SF, CA Address: Zip: 94110 Phone, W: Email: 2. Project Site Information Project location: Site Description: 047-153-240 😿 Vacant Parcel Address: VACANT LOT 14. BLOCK 1 Existing Development (Please describe): ELARAMADO HIGHLANDS Zoning: Parcel/lot size: 4750 sg. ft. 3. Project Description **Project:** Additional Permits Required: New Single Family Residence: \_\_\_\_\_\_ sq. ft ☐ Certificate of Compliance Type A or Type B ☐ Addition to Residence: Coastal Development Permit Other: \_ Fence Height Exception (not permitted on coast) Grading Permit or Exemption **Describe Project:** Home Improvement Exception Non-Conforming Use Permit Off-Street Parking Exception Variance

4. Materials and	d Finish of Proposed Sui	ldings er Structures	Check if
Fill in Blanks:	Material	Color/Finish	matches
riii iii bidiiks.	matoria:	(If different from existing, attach samp	existing ole)
	SEE COPAPPUC		
a. Exterior walls b. Trim	<u> </u>		
c. Windows			
d. Doors			
e. Roof			
		-	
f. Chimneys	-	•	
g. Decks & railings	,		
h. Stairs			
i. Retaining walls			
j. Fences			
k. Accessory buildings  I. Garage/Carport			
including the required fin applicable to the location	on, the County must determine that this adings that the project does conform to a of the project pursuant to Section 656 ont's Statement of project compliance wi	the standards and guidelines for designations. 5.10.	1 Levië vŷ
6. Signatures			
I hereby certify that the in	nformation stated above and on forms, n is true and correct to the best of my k assigned project planner of any change	DOMIGORE If it this tesponisionity to innot	III the County of
ON BEHALF Owner:	OF OWNER NOT PRESENT APR	Katharimo M De And Dicant:	<u> </u>
Date:	Da	te:	

Simultaneous De	evelopment Application (if any):			PLN#
San Mateo Co	ounty Planning & Building De	partment		ter, 2nd Floor Redwood City • CA • 94063 : 650 • 363 • 4161 Fax: 650 • 363 • 4849
Remov	eation for Perive Tree(s) at seq and 12,000 et seq of the San M			
HERITAGE	<u> </u>		Orumanice code.	
Property Owner:	IENNIEED M. DANDLE			THE SAME
Mailing Address	2125 Bryant St., Apt 107			
San Francisco		ZIP code: 94	1403	Date of Application:
Telephone: 917-				10 Day Period of Posted Notice
Applicant (if diff	,		:	From:
Mailing Address			****	То:
Mannig Tudi Coo		ZIP code:		
Telephone:	Email:	II codo.		
Address where t	ree(s) located:		Parcel Nu	ımber:
Tree(s) Diameter or Circumference (at 4½ ft. height)	Kind of tree(s)	Heritage Tree? (Yes / No)	Health of tree(s)	Reason for Removal/Trimming
60"	Eucalyptus	No	Healthy	Invasive + New construction.
				+ DEFENSIBLE SPACE CLEARANCE
				·
REMOVAL P. 1. Method of 2. Disposal	of removal: By Owner  By Tree Removal  Name: To be determined by  I of tree debris: All debris to	be removed		
that an approve	ed permit is conditional. Further, Planning Commission. Authority	, the decisio	n on this applica	st of my knowledge. I understand ation may be appealed to the San effective only after the approval
	<del></del>		Applicant's	s Signature
	ion of this application request wi ition, to the Mid-Coast Communi			ners within 100 feet of the project te is located in the Mid-Coast.
	NOTE: All Tree Removal Ap			
		·····		

# RANDLE RESIDENCE EL GRANADA, CA



#### PROJECT TEAM

<u>OWNER</u> JEN RANDLE SAN FRANCISCO, CA 917-547-*0*2*0*3

ARCHITECT JOHN WALTER SAN FRANCISCO, CA 219-776-1634

CIVIL ENGINEER
CHARLES KISSICK
SIGMA PRIME GEOSCIENCES, INC
332 PRINCETON AVE
HALF MOON BAY, CA 94019
650-728-3590

#### SHEET INDEX

A0.00 COVER
A1.00 EXISTING CONDITIONS PLAN
A1.01 SITE PLAN AND PROJECT INFO

CONSTRUCTION BMPs


CI GRADING AND DRAINAGE PLAN
C2 EROSION & SEDIMENT CONTROL PLAN


L1.01 CONCEPTUAL LANDSCAPE PLAN

A2.01 FIRST FLOOR PLAN

A2.02 ROOF PLAN

A3.01 PROPOSED ELEVATIONS
A3.02 PROPOSED ELEVATIONS
A4.01 PROPOSED PERSPECTIVES
A5.01 DETAIL & CUT SHEETS

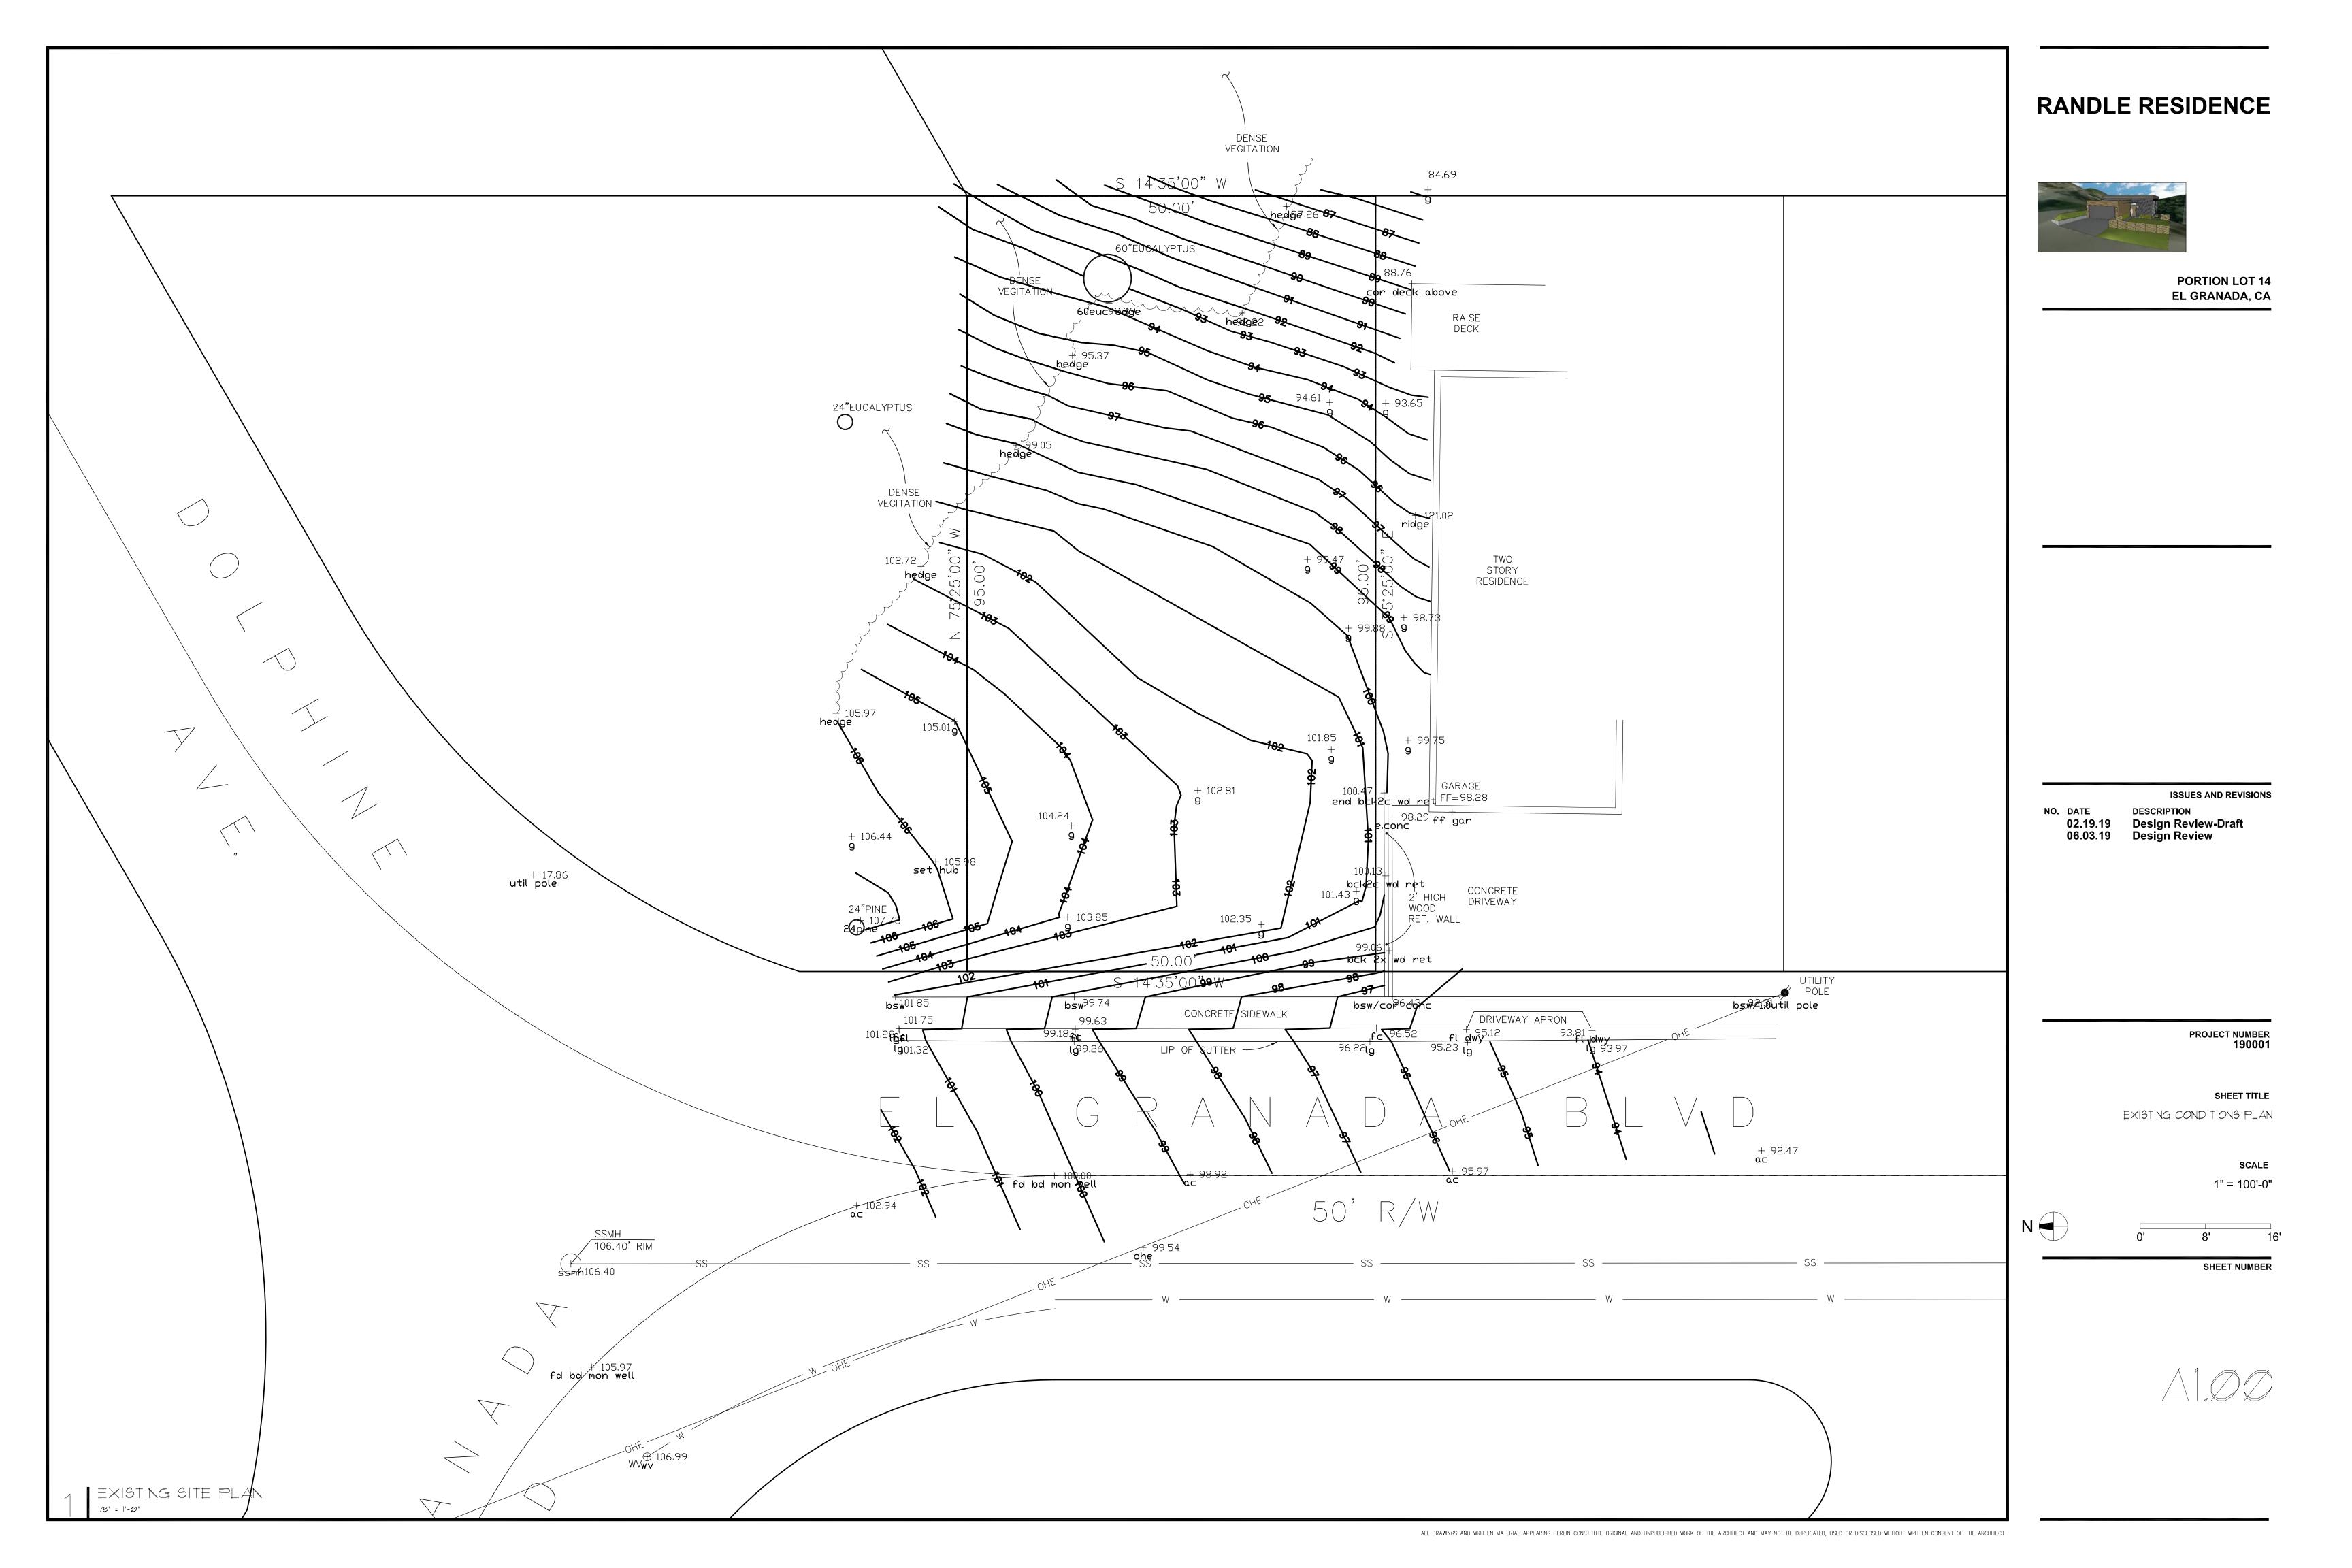

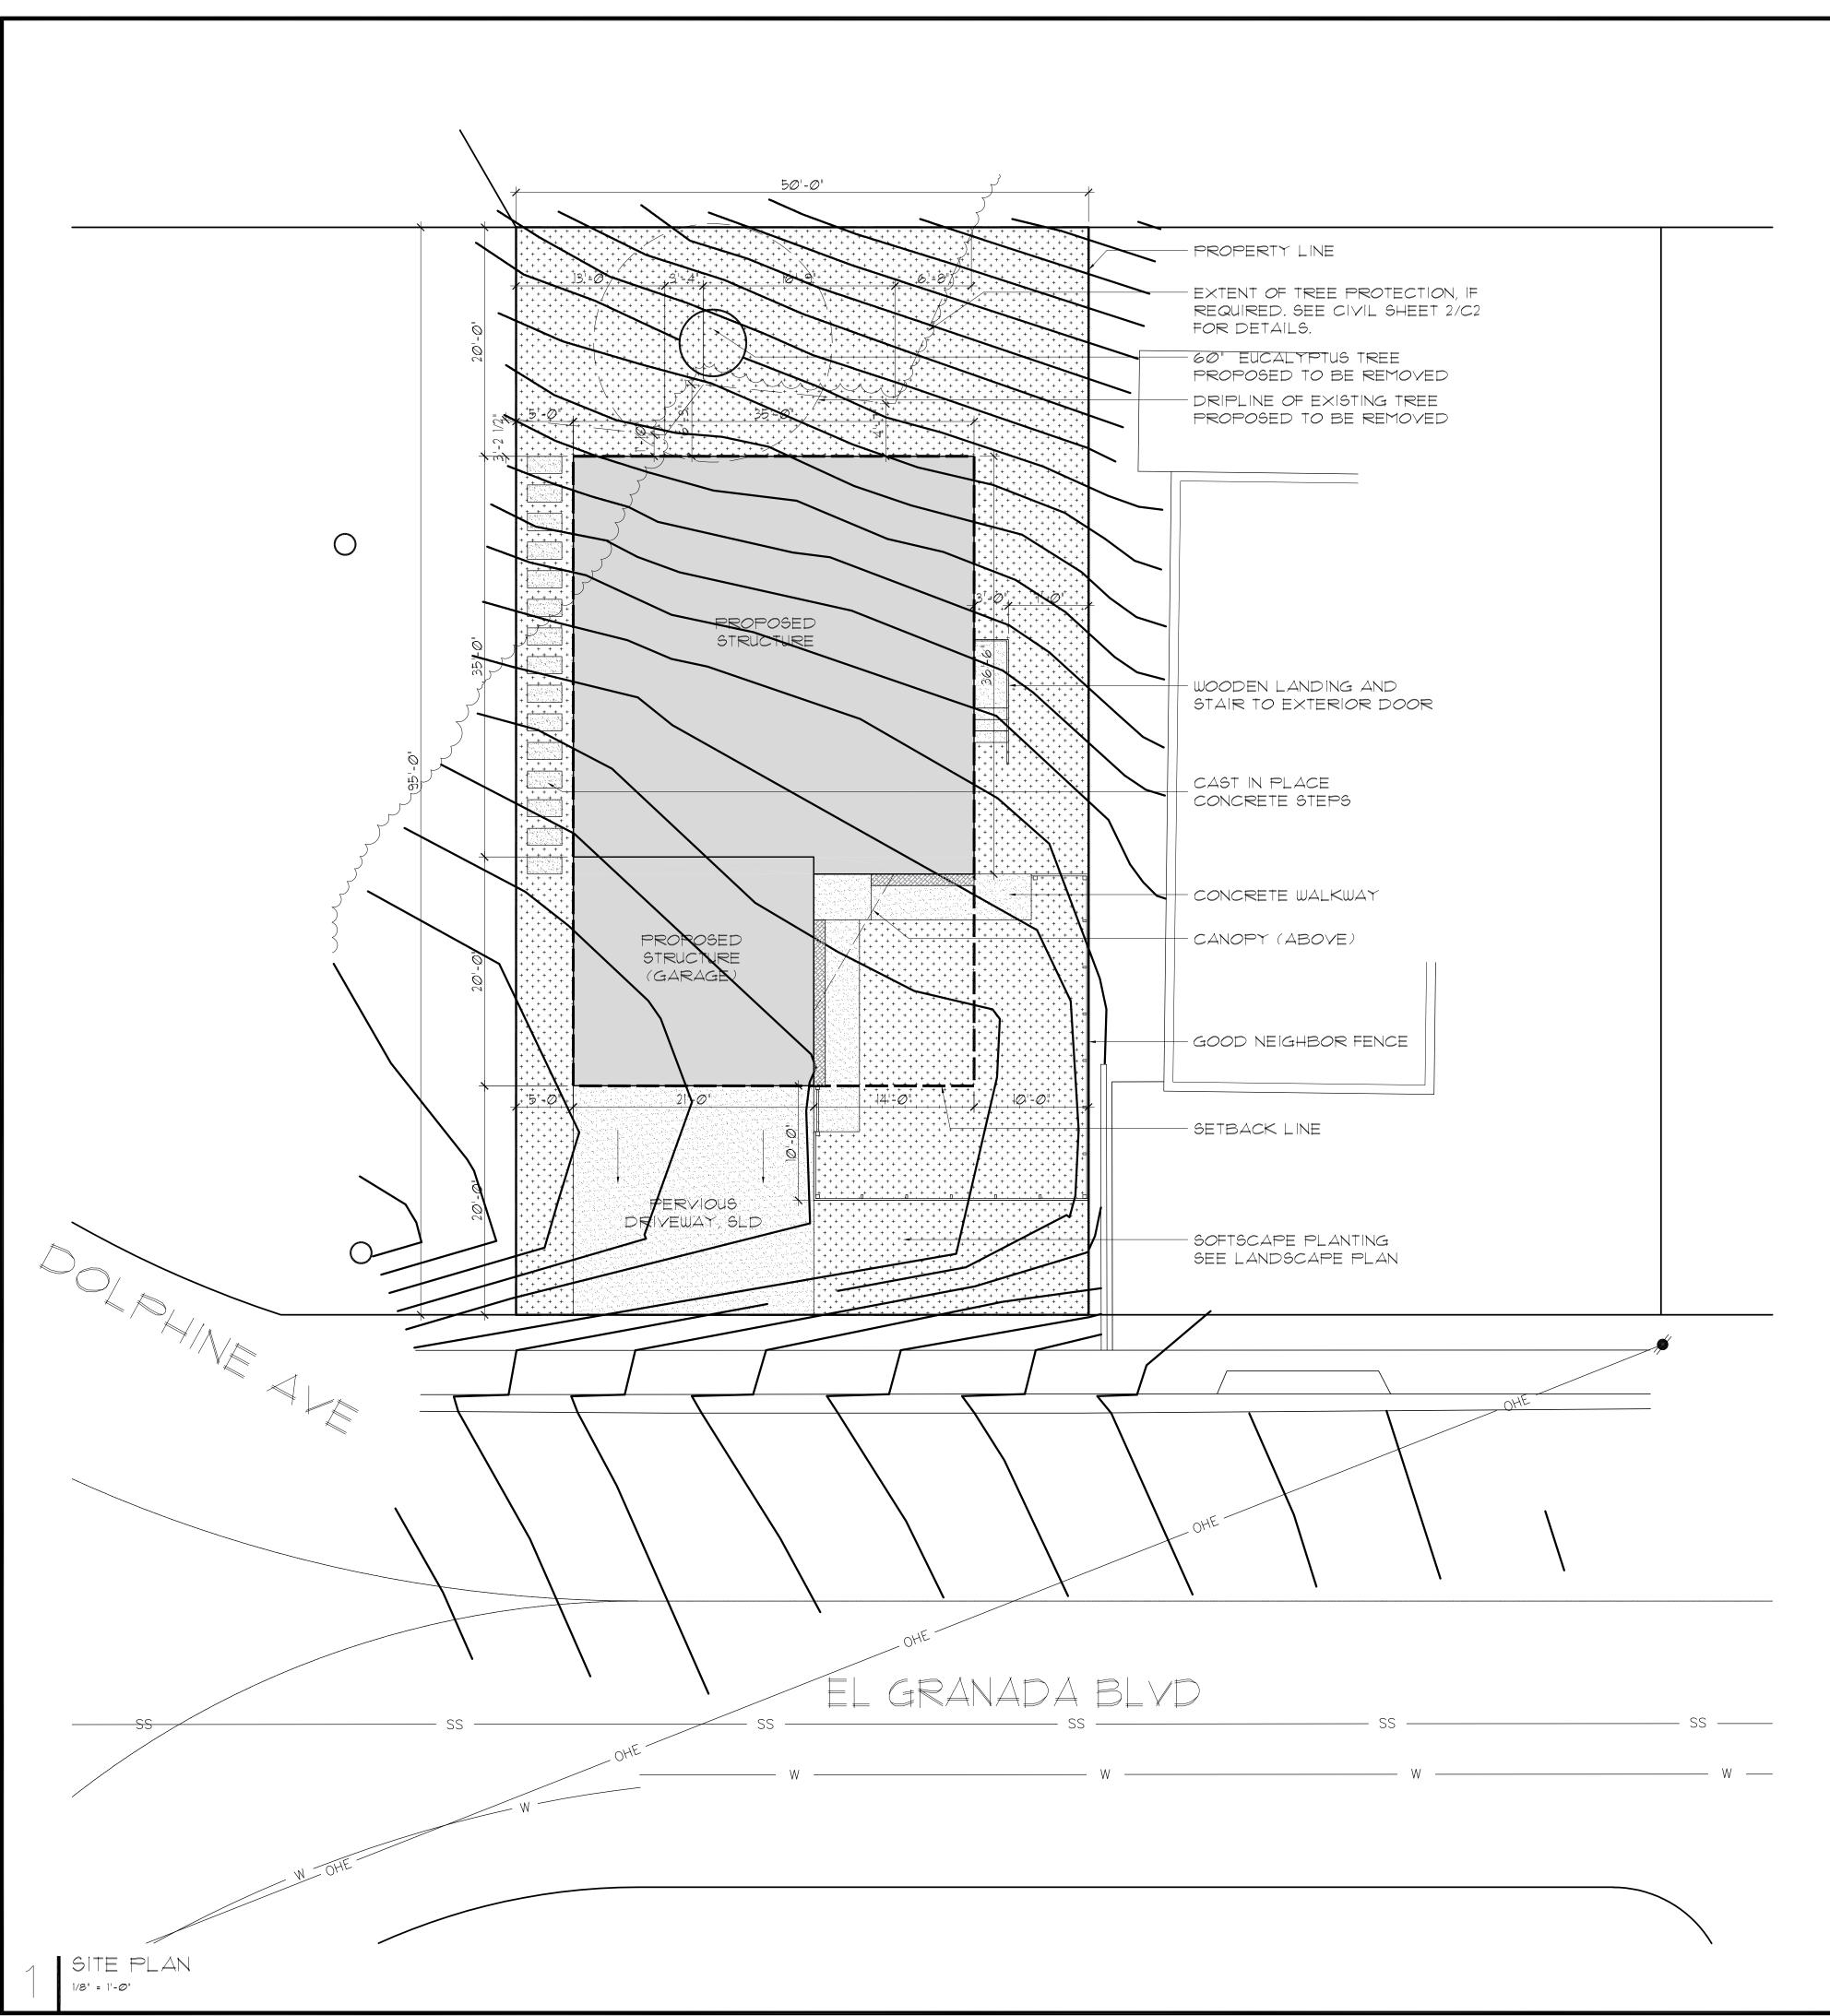

#### PROJECT INFORMATION

#### ZONING: R-1/S-17/DR/CD

1. <u>LOT WIDTH</u>

REQUIRED: 50'-0" MIN AT SHORTEST SIDE EXISTING: 50'-0"

2. MIN SITE AREA

REQUIRED: 5,000 SF MIN

EXISTING: 4,750 SF (NON-CONFORMING)

3. BUILDING SETBACKS

REAR: 20'-0" FRONT: 20'-0"

5' TOTAL FOR BOTH SIDES IF BUILDING HEIGHT IS LESS THAN 16'-0"

4. PARCEL COVERAGE

REQUIRED MAXIMUM: 50% IF LESS THAN OR EQUAL TO 16'-0" PROPOSED LOT COVERAGE:1,850 SF (38.9%, CONFORMS)

5. BUILDING FLOOR AREA:

REQUIRED FAR: 0.53 - ((5,000-PARCEL SIZE) \* 0.0002) \* PARCEL SIZE  $\emptyset.53 - ((5,000-4,750) * 0.00002 * 4,750 = 0.48 FAR (2,280 MAX SF)$ PROPOSED FAR: 1,850 / 4,750 = 0.39

6. <u>Building height</u>

MAX HEIGHT: 28' WHEN THE AVERAGE SLOPE IS GREATER THAN 30% PROPOSED HEIGHT: SEE ELEVATIONS

7. IMPERVIOUS SURFACE AREA

MAX ALLOWED: 10% OF PARCEL (INC. DRIVEWAYS, PATIOS, WALKWAYS, & DECKS) 475 SF PROPOSED SURFACE AREA: 430 SF

8. GARAGE MAX PLATE HEIGHT: REQUIRED MAXIMUM: 10'-0"

PROPOSED: 9'-Ø"

9. DAYLIGHT PLANE OR FACADE ARTICULATION

PROJECT PROPOSES TO MEET THIS REQUIREMENT THROUGH OPTION B: "FACADE ARTICULATION". FACADE ELEVATIONS ARE PROVIDED ON SHEETS A3.01-02.

VICINITY MAP

### RANDLE RESIDENCE



**PORTION LOT 14 EL GRANADA, CA** 

**ISSUES AND REVISIONS** DESCRIPTION

02.19.19 Design Review-Draft 06.03.19 Design Review


NO. DATE


PROJECT NUMBER 190001

SHEET TITLE PROPOSED SITE PLAN

SCALE

1" = 100'-0"

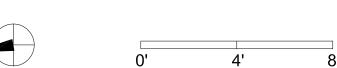

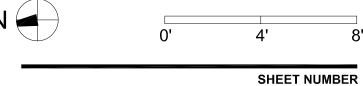




# Construction Best Management Practices (BMPs)

Construction projects are required to implement the stormwater best management practices (BMP) on this page, as they apply to your project, all year long.

Clean Water. Healthy Community.

## **Materials & Waste Management**

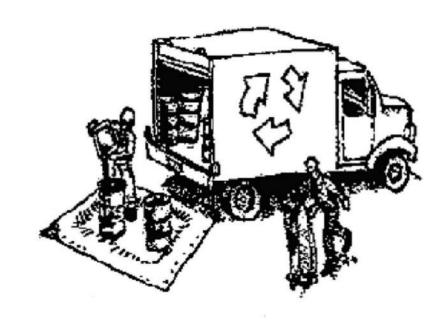

#### **Non-Hazardous Materials**

- ☐ Berm and cover stockpiles of sand, dirt or other construction material with tarps when rain is forecast or if not actively being used within
- ☐ Use (but don't overuse) reclaimed water for dust control.

#### **Hazardous Materials**

- ☐ Label all hazardous materials and hazardous wastes (such as pesticides, paints, thinners, solvents, fuel, oil, and antifreeze) in accordance with city, county, state and federal regulations.
- ☐ Store hazardous materials and wastes in water tight containers, store in appropriate secondary containment, and cover them at the end of every work day or during wet weather or when rain is forecast.
- ☐ Follow manufacturer's application instructions for hazardous materials and be careful not to use more than necessary. Do not apply chemicals outdoors when rain is forecast within 24 hours.
- Arrange for appropriate disposal of all hazardous wastes.

### Waste Management

- Cover waste disposal containers securely with tarps at the end of every work day and during wet weather.
- Check waste disposal containers frequently for leaks and to make sure they are not overfilled. Never hose down a dumpster on the
- Clean or replace portable toilets, and inspect them frequently for
- Dispose of all wastes and debris properly. Recycle materials and wastes that can be recycled (such as asphalt, concrete, aggregate base materials, wood, gyp board, pipe, etc.)
- Dispose of liquid residues from paints, thinners, solvents, glues, and cleaning fluids as hazardous waste.

#### **Construction Entrances and Perimeter**

- **X** Establish and maintain effective perimeter controls and stabilize all construction entrances and exits to sufficiently control erosion and sediment discharges from site and tracking off site.
- Sweep or vacuum any street tracking immediately and secure sediment source to prevent further tracking. Never hose down streets to clean up tracking.

## **Equipment Management & Spill Control**




#### **Maintenance and Parking**

- ☐ Designate an area, fitted with appropriate BMPs, for vehicle and equipment parking and storage.
- ☐ Perform major maintenance, repair jobs, and vehicle and equipment washing off site.
- ☐ If refueling or vehicle maintenance must be done onsite, work in a bermed area away from storm drains and over a drip pan or drop cloths big enough to collect fluids. Recycle or dispose of fluids as hazardous waste.
- ☐ If vehicle or equipment cleaning must be done onsite, clean with water only in a bermed area that will not allow rinse water to run into gutters, streets, storm drains, or surface waters.
- ☐ Do not clean vehicle or equipment onsite using soaps, solvents, degreasers, or steam cleaning equipment.

#### **Spill Prevention and Control**

- Keep spill cleanup materials (e.g., rags, absorbents and cat litter) available at the construction site at all times.
- ☐ Inspect vehicles and equipment frequently for and repair leaks promptly. Use drip pans to catch leaks until repairs are made.
- Clean up spills or leaks immediately and dispose of cleanup materials properly.
- Do not hose down surfaces where fluids have spilled. Use dry cleanup methods (absorbent materials, cat litter, and/or rags).
- Sweep up spilled dry materials immediately. Do not try to wash them away with water, or bury them.
- ☐ Clean up spills on dirt areas by digging up and properly disposing of contaminated soil.
- ☐ Report significant spills immediately. You are required by law to report all significant releases of hazardous materials, including oil. To report a spill: 1) Dial 911 or your local emergency response number, 2) Call the Governor's Office of Emergency Services Warning Center, (800) 852-7550 (24 hours).

## **Earthmoving**

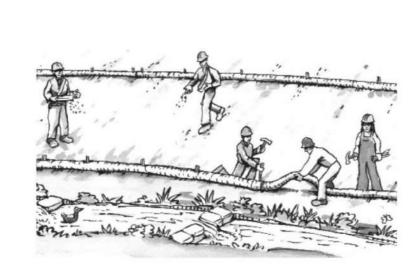

- X Schedule grading and excavation work during dry weather.
- X Stabilize all denuded areas, install and maintain temporary erosion controls (such as erosion control fabric or bonded fiber matrix) until vegetation is established.
- X Remove existing vegetation only when absolutely necessary, and seed or plant vegetation for erosion control on slopes or where construction is not immediately
- Prevent sediment from migrating offsite and protect storm drain inlets, gutters, ditches, and drainage courses by installing and maintaining appropriate BMPs, such as fiber rolls, silt fences, sediment basins, gravel bags, berms, etc.
- ☐ Keep excavated soil on site and transfer it to dump trucks on site, not in the streets.

#### Contaminated Soils

- ☐ If any of the following conditions are observed, test for contamination and contact the Regional Water Quality Control Board:
- Unusual soil conditions, discoloration, or odor.
- Abandoned underground tanks.
- Abandoned wells
- Buried barrels, debris, or trash

Storm drain polluters may be liable for fines of up to \$10,000 per day!

## Paving/Asphalt Work




- Avoid paving and seal coating in wet weather or when rain is forecast, to prevent materials that have not cured from contacting stormwater runoff.
- ☐ Cover storm drain inlets and manholes when applying seal coat, tack coat, slurry seal, fog seal, etc.
- Collect and recycle or appropriately dispose of excess abrasive gravel or sand. Do NOT sweep or wash it into gutters.
- Do not use water to wash down fresh asphalt concrete pavement.

#### Sawcutting & Asphalt/Concrete Removal


- ☐ Protect nearby storm drain inlets when saw cutting. Use filter fabric, catch basin inlet filters, or gravel bags to keep slurry out of the storm drain system.
- ☐ Shovel, abosorb, or vacuum saw-cut slurry and dispose of all waste as soon as you are finished in one location or at the end of each work day (whichever is
- ☐ If sawcut slurry enters a catch basin, clean it up immediately.

## Concrete, Grout & Mortar

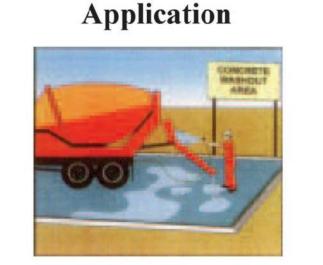


- ☐ Store concrete, grout, and mortar away from storm drains or waterways, and on pallets under cover to protect them from rain, runoff, and wind.
- Wash out concrete equipment/trucks offsite or in a designated washout area, where the water will flow into a temporary waste pit, and in a manner that will prevent leaching into the underlying soil or onto surrounding areas. Let concrete harden and dispose of as
- ☐ When washing exposed aggregate, prevent washwater from entering storm drains. Block any inlets and vacuum gutters, hose washwater onto dirt areas, or drain onto a bermed surface to be pumped and disposed of properly.

## Landscaping

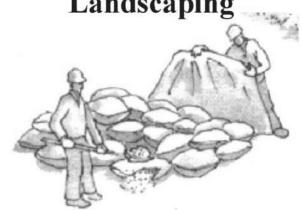


- ☐ Protect stockpiled landscaping materials from wind and rain by storing them under tarps all year-round.
- ☐ Stack bagged material on pallets and under cover.
- Discontinue application of any erodible landscape material within 2 days before a forecast rain event or during wet weather.

## **Painting & Paint Removal**

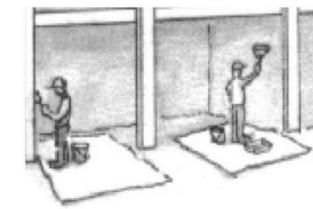


#### **Painting Cleanup and Removal**

- Never clean brushes or rinse paint drain, or stream.
- For water-based paints, paint out brushes to the extent possible, and rinse into a drain that goes to the sanitary sewer. Never pour paint down a storm drain.
- ☐ For oil-based paints, paint out brushes to the extent possible and clean with thinner or solvent in a proper container. Filter and reuse thinners and solvents. Dispose of excess liquids as hazardous waste.
- ☐ Paint chips and dust from non-hazardous dry stripping and sand blasting may be swept up or collected in plastic drop cloths and disposed of as trash.
- and dust from marine paints or paints containing lead, mercury, or tributyltin must be disposed of as hazardous waste. certified contractor.

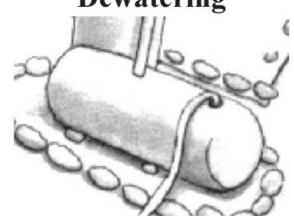

- ☐ Discharges of groundwater or captured runoff from dewatering operations must possible send dewatering discharge to landscaped area or sanitary sewer. If local wastewater treatment plant.
- ☐ Divert run-on water from offsite away from all disturbed areas.
- ☐ When dewatering, notify and obtain approval from the local municipality or storm drain. Filtration or diversion through a basin, tank, or sediment trap may be required.
- ☐ In areas of known or suspected to be collected and hauled off-site for

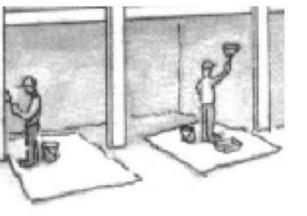

- containers into a street, gutter, storm

- ☐ Chemical paint stripping residue and chips Lead based paint removal requires a state-

#### **Dewatering**

- be properly managed and disposed. When discharging to the sanitary sewer call your
- before discharging water to a street gutter
- contamination, call your local agency to determine whether the ground water must be tested. Pumped groundwater may need treatment and proper disposal.

RANDLE RESIDENCE

**PORTION LOT 14** 

**EL GRANADA, CA** 

**ISSUES AND REVISIONS** 

PROJECT NUMBER

CONSTRUCTION BMPs

SHEET TITLE


**VARIES** 

SHEET NUMBER


Design Review-Draft


Design Review


ALL DRAWINGS AND WRITTEN MATERIAL APPEARING HEREIN CONSTITUTE ORIGINAL AND UNPUBLISHED WORK OF THE ARCHITECT AND MAY NOT BE DUPLICATED, USED OR DISCLOSED WITHOUT WRITTEN CONSENT OF THE ARCHITECT

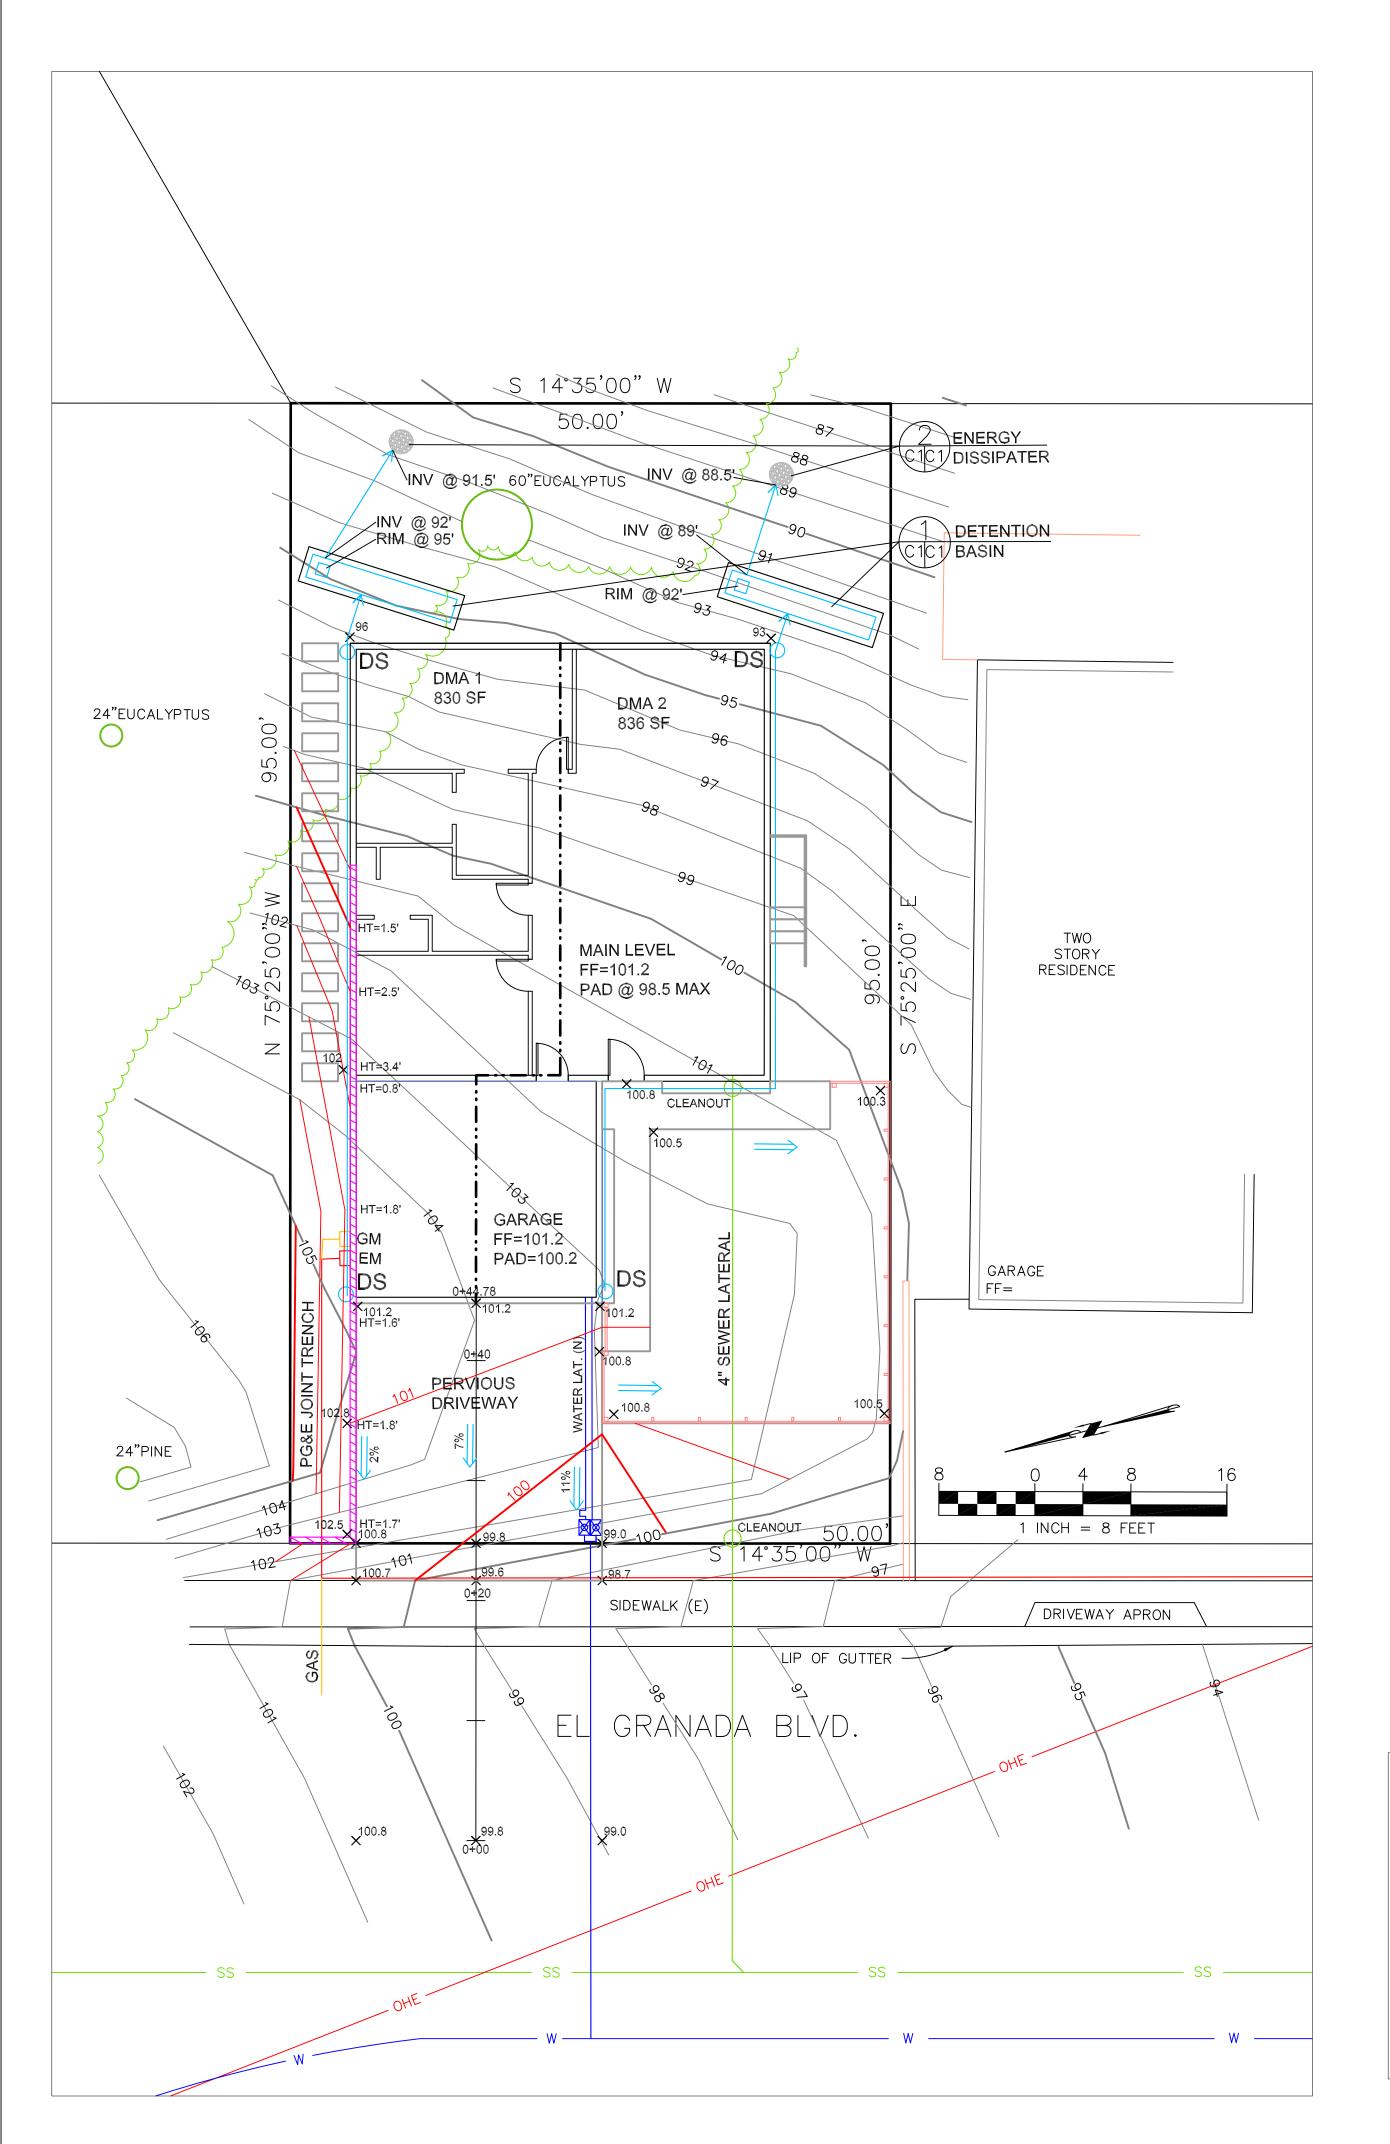


#### NOTE: PERVIOUS DRIVEWAY MAY USE EITHER OF THE TWO DETAILS BELOW.

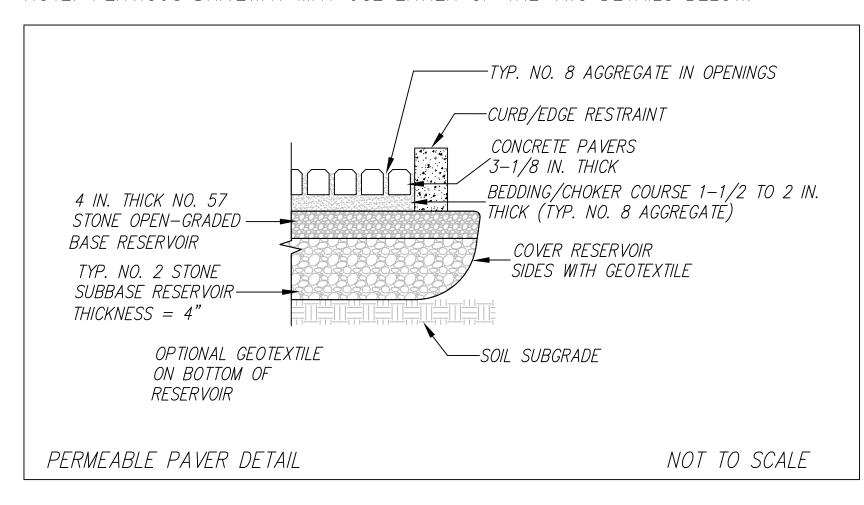

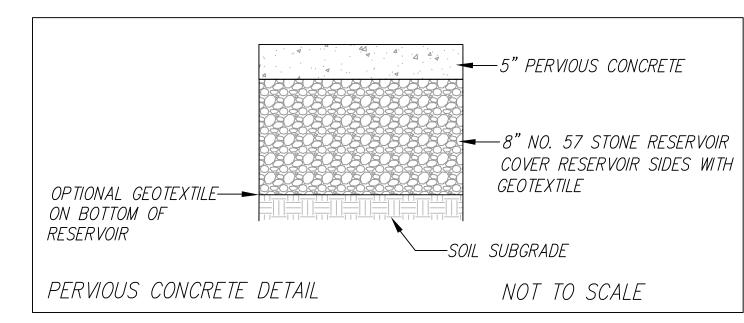

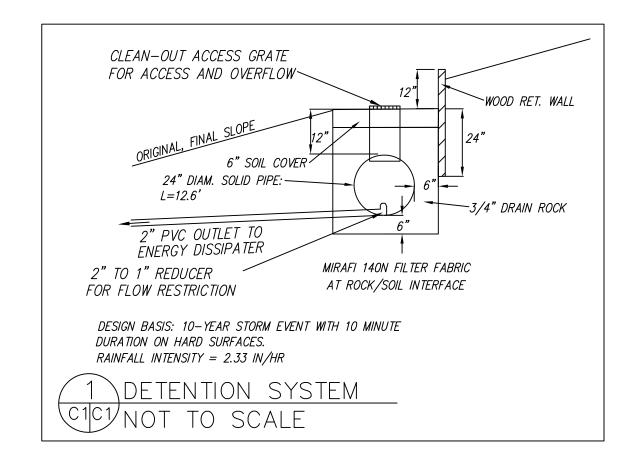

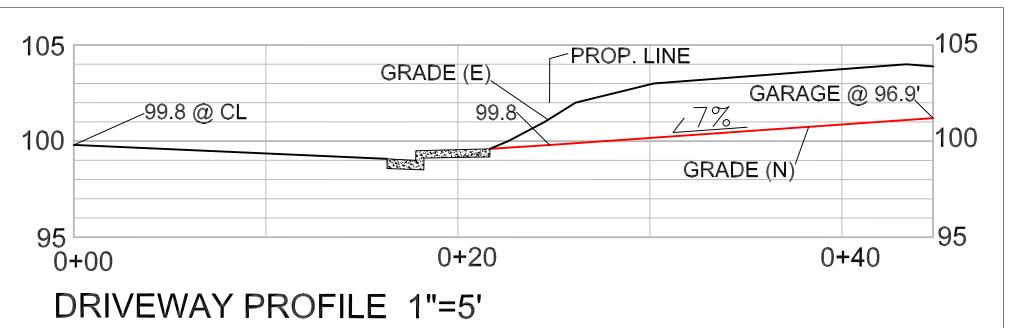

## LEGEND

// EXISTING CONTOURS // PROPOSED CONTOURS y99.8 PROPOSED SPOT ELEVATION DOWNSPOUT

DIRECTION OF SURFACE DRAINAGE

4" SOLID PLASTIC DRAIN PIPE, SDR 35 @ 1 % MINIMUM SLOPE.

MINIMUM SLOPE.

4" SOLID PLASTIC DRAIN PIPE, SDR 35 @ 1 % MINIMUM SLOPE.

4" PERF. DRAIN PIPE, SDR 35 @ 1%

RETAINING WALL

## GENERAL NOTES

- 1. PLANS PREPARED AT THE REQUEST OF:
- JEN RANDLE, OWNER 2. SURVEY AND TOPOGRAPHY BY S. MICALLEF, MAY 2012.
- 3. ELEVATION DATUM ASSUMED.
- 4. THIS IS NOT A BOUNDARY SURVEY.

### GRADING NOTES

CUT VOLUME: 160 CY FILL VOLUME: 0 CY TOTAL: 160 CY CUT/FILL

1. ABOVE VOLUMES ARE APPROXIMATE. 2. MAXIMUM GRADIENT OF ANY MODIFIED SLOPES SHALL BE 2:1 (H:V).

3. ALL GRADING SHALL CONFORM TO LOCAL CODES AND ORDINANCES.

4. ALL TRENCHES IN PROPOSED LANDSCAPE AREAS SHALL BE BACKFILLED WITH COMPACTED APPROVED GRANULAR MATERIAL TO WITHIN ONE FOOT OF FINISHED GRADE, AND THEN FILLED WITH HAND TAMPED SOILS.

#### DRAINAGE NOTES

1. DRAINAGE INTENT: IT IS THE INTENT OF THE DRAINAGE SYSTEM TO CONVEY ROOF RUNOFF TO A SAFE LOCATION, AND TO MINIMIZE EXCESSIVE MOISTURE AROUND FOUNDATIONS. DIRECT SLOPES SUCH THAT STORMWATER WILL NOT BE DIVERTED ONTO ADJACENT PROPERTIES.

2. ALL DOWNSPOUT DRAIN LINES SHALL LEAD TO DETENTION BASINS, AS SHOWN. THE DETENTION BASINS SHALL BE WATER-TIGHT AND DRAIN TO AN ENERGY DISSIPATERS, AS SHOWN.

3. ALL ROOF DRAINAGE PIPES SHALL BE 3" DIAMETER MINIMUM SOLID PIPE, SLOPED AT 1% MINIMUM.

4. IT IS THE PROPERTY OWNER'S RESPONSIBILITY TO CHECK ON ALL STORMWATER FACILITIES SUCH AS ROOF GUTTERS, DOWNSPOUT LINES, AND THE DETENTION BASIN/ENERGY DISSIPATER TO BE SURE THAT THEY ARE CLEAR OF EXCESSIVE DEBRIS AND OPERATING EFFICIENTLY. THE FACILITIES SHALL BE CHECKED EVERY FALL AND PERIODICALLY DURING THE RAINY SEASON.


## TRAFFIC CONTROL NOTES

1. CONTRACTOR AND WORKERS SHALL PARK ON EL GRANADA BLVD. 2. CONTRACTORS CANNOT BLOCK ROADWAY. PROVIDE AT LEAST ONE

LANE DURING WORKING HOURS, 2 LANES AFTER HOURS.

SECTION OR DETAIL IDENTIFICATION

SECTION AND DETAIL CONVENTION

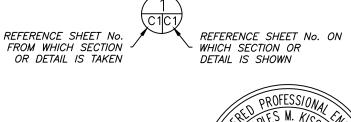





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SHEET


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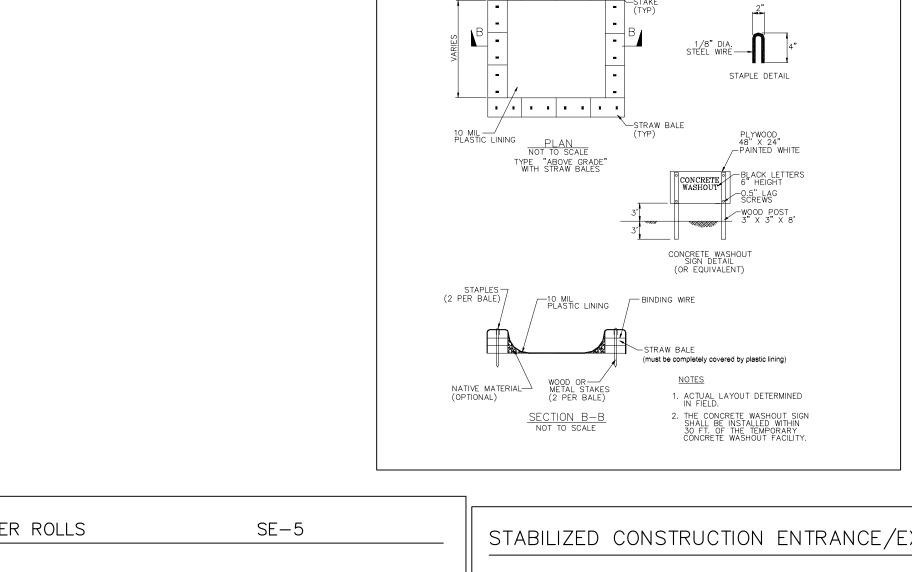


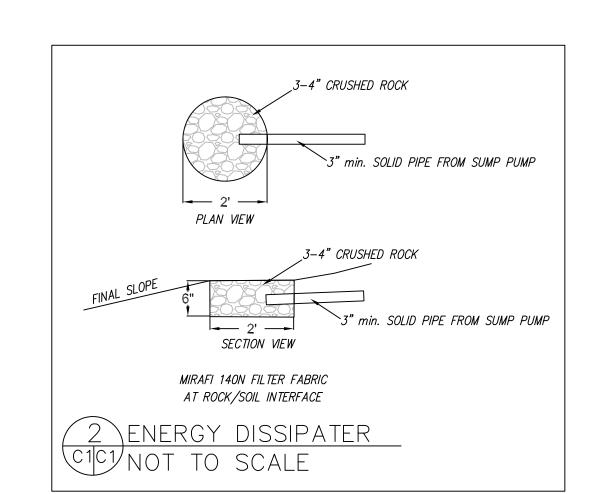

## TREE PROTECTION NOTES

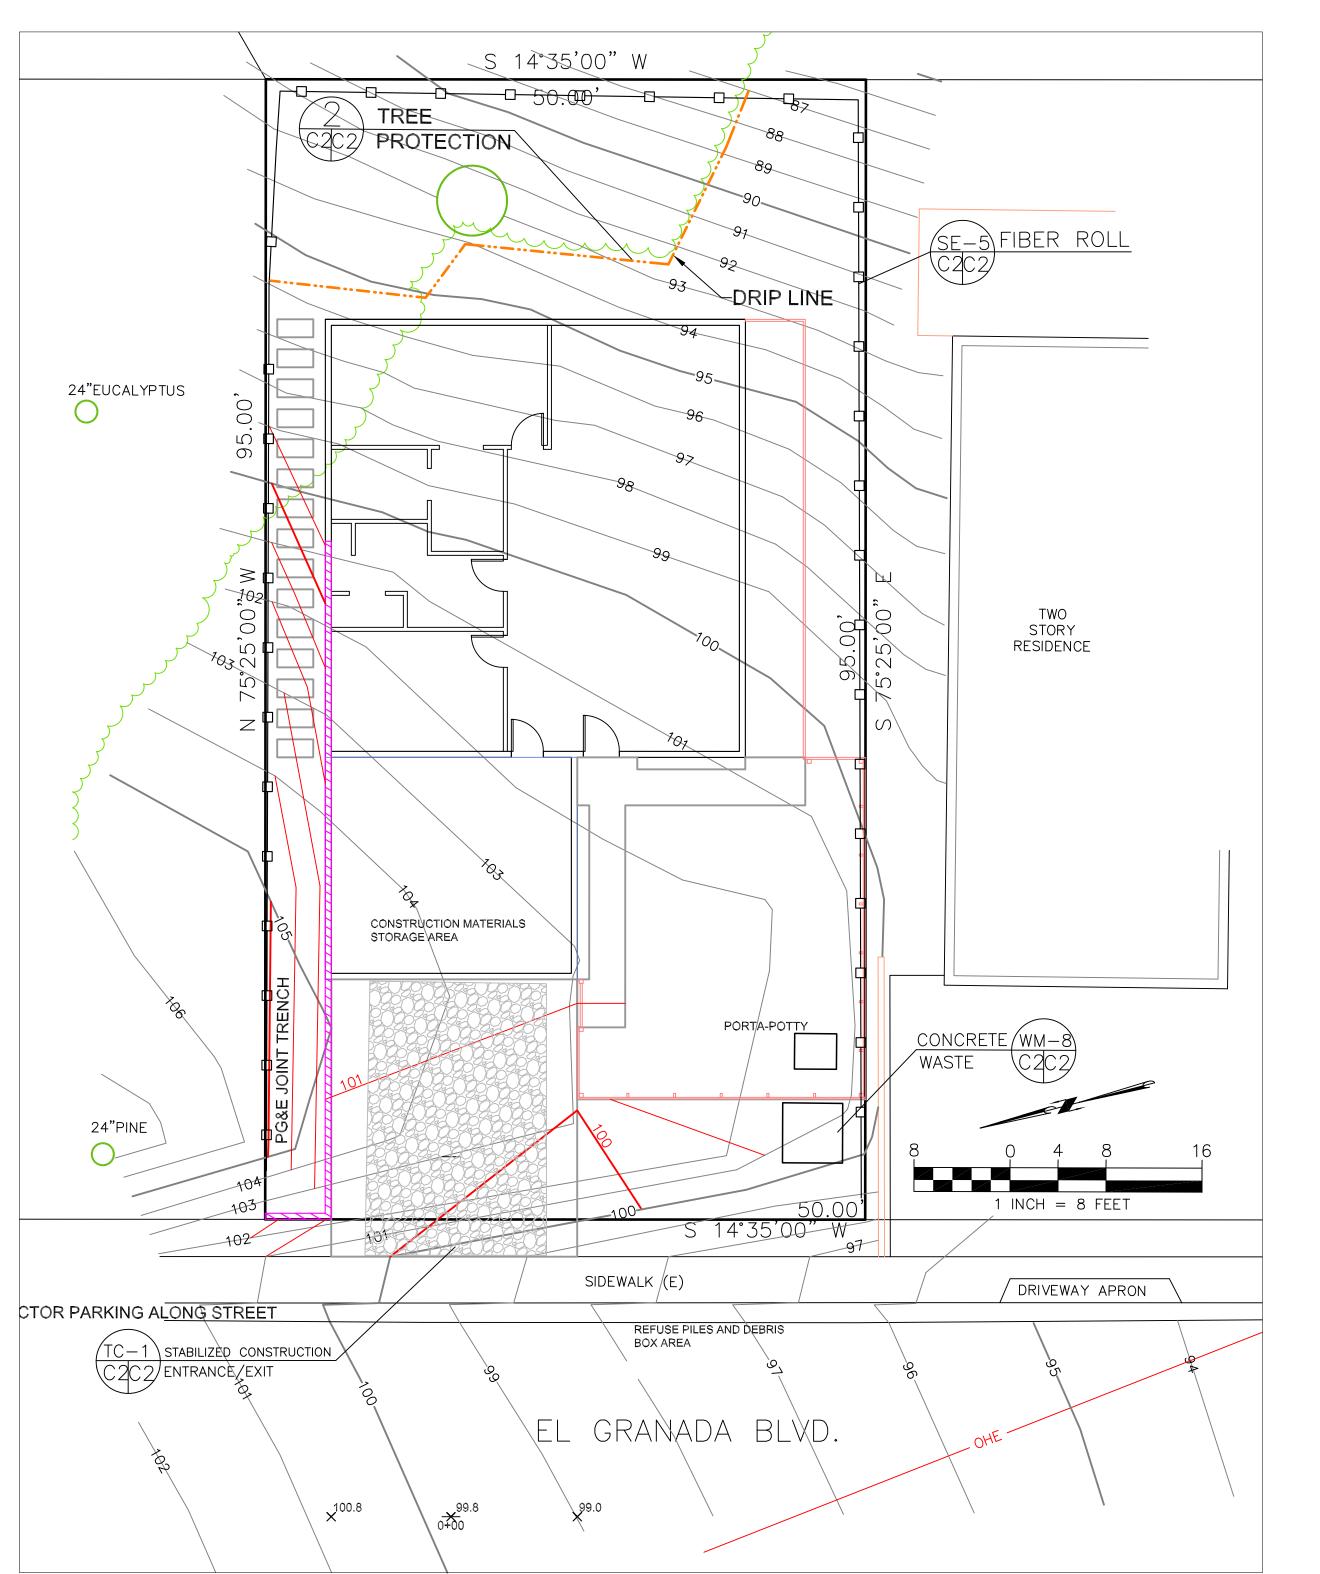
- 1. TREE PROTECTION FENCING SHALL BE INSTALLED PRIOR TO ANY GRADING AND REMAIN ON-SITE THROUGHOUT CONSRUCTION PROCESS.
- 2. TREE PROTECTION FENCES SHALL BE INSTALLED AS CLOSE TO DRIP LINES AS POSSIBLE.
- 3. OWNER/BUILDER SHALL MAINTAIN TREE PROTECTION ZONES FREE OF EQUIPMENT AND MATERIALS STORAGE AND SHALL NOT CLEAN ANY EQUIPMENT WITHIN THESE AREAS.
- 4. ANY LARGE ROOTS THAT NEED TO BE CUT SHALL BE INSPECTED BY A CERTIFIED ARBORIST OR REGISTERED FORESTER PRIOR TO CUTTING, AND MONITORED AND DOCUMENTED.
- 5. ROOTS TO BE CUT SHALL BE SEVERED WITH A SAW OR TOPPER.
- 6. PRE-CONSTRUCTION SITE INSPECTION WILL BE REQUIRED PRIOR TO ISSUANCE OF BUILDING PERMIT.



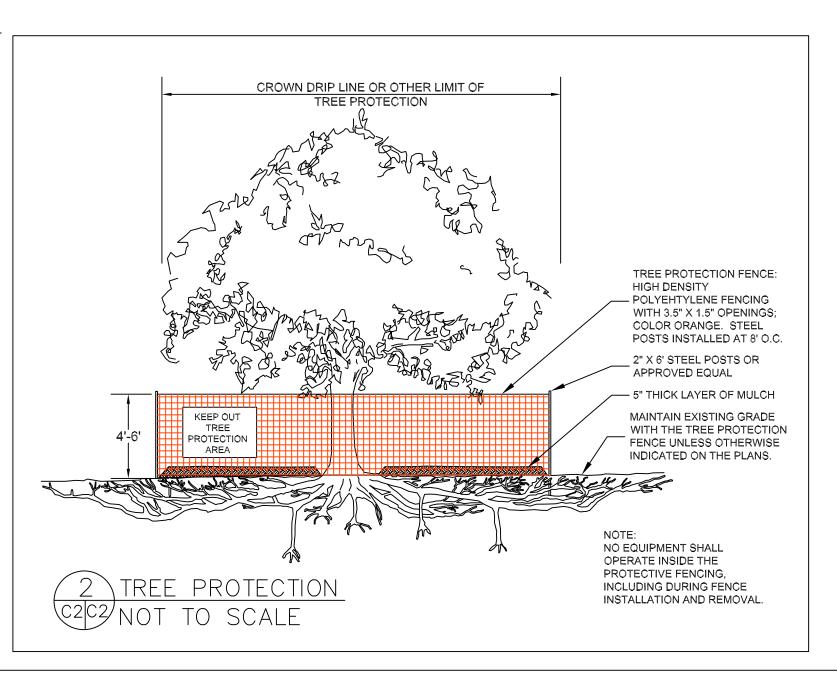

CONCRETE WASTE MANAGEMENT

8-MW

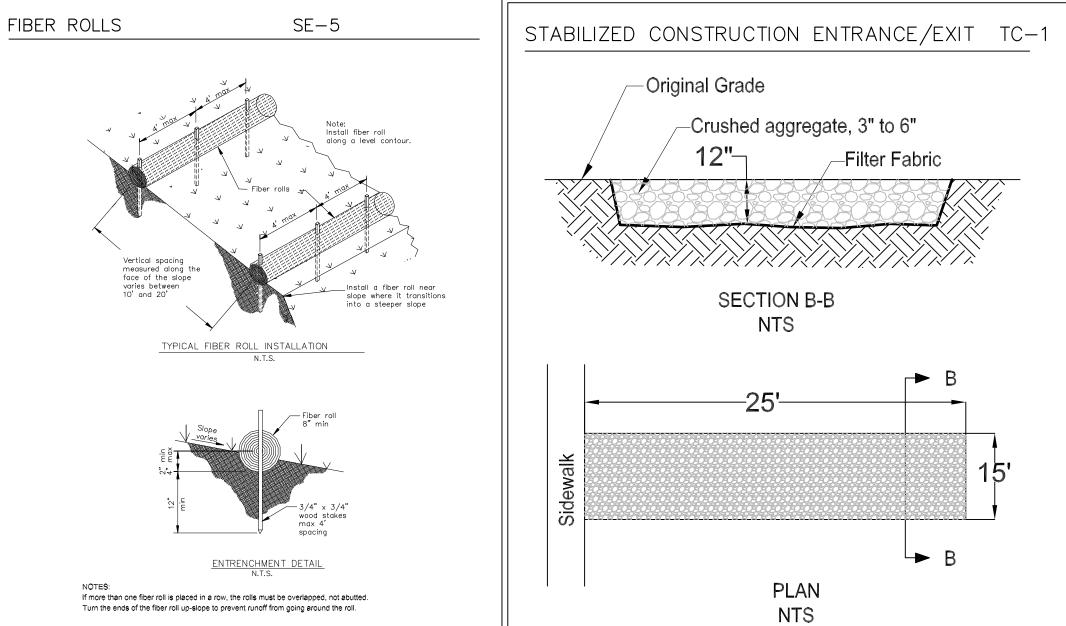

#### GENERAL EROSION AND SEDIMENT CONTROL NOTES

- · There will be no stockpiling of soil. All excavated soil will be hauled off-site as it is excavated.
- · Perform clearing and earth-moving activities only during dry weather. Measures to ensure adequate erosion and sediment control shall be installed prior to earth-moving activities and construction.
- · Measures to ensure adequate erosion and sediment control are required year-round. Stabilize all denuded areas and maintain erosion control measures continuously between October 1 and April 30.
- Store, handle, and dispose of construction materials and wastes properly, so as to prevent their contact with stormwater.
- · Control and prevent the discharge of all potential pollutants, including pavement cutting wastes, paints, concrete, petroleum products, chemicals, wash water or sediments, and non-stormwater discharges to storm drains and watercourses.
- · Use sediment controls or filtration to remove sediment when dewatering site and obtain Regional Water Quality Control Board (RWQCB) permit(s) as necessary.
- · Avoid cleaning, fueling, or maintaining vehicles on-site, except in a designated area where wash water is contained and treated.
- · Limit and time applications of pesticides and fertilizers to prevent polluted runoff.
- · Limit construction access routes to stabilized, designated access points
- · Avoid tracking dirt or other materials off-site; clean off-site paved areas and sidewalks using dry sweeping methods.
- Train and provide instruction to all employees and subcontractors regarding the Watershed Protection Maintenance Standards and construction Best Management Practices.
- · Placement of erosion materials is required on weekends and during rain events.
- The areas delineated onh the plans for parking, grubbing, storage etc., shall not be enlarged or "run over."
- Dust control is required year-round.
- · Erosion control materials shall be stored on-site
- The tree protection shall be in place before any grading, excavating or grubbing is started.

## EROSION CONTROL NOTES

#### INSTALL AT LOCATIONS SHOWN. AFIX AS SHOWN IN DETAIL SE-5.

1. GRADING MAY TAKE PLACE DURING WET WEATHER AFTER OCTOBER 1 PROVIDED THE FOLLOWING PROVISIONS ARE FOLLOWED. 2. NO GRADING SHALL TAKE PLACE DURING RAINY WEATHER OR FOR A PERIOD OF AT

LEAST 24 HOURS FOLLOWING RAIN. 3. ALL EXPOSED SOIL SHALL BE TEMPORARILY PROTECTED FROM EROSION WITH JUTE

4. ALL STOCKPILED SOIL SHALL BE COVERED AT ALL TIMES AND REMOVED FROM SITE AS SOON AS POSSIBLE, IF SCHEDULED FOR OFF-HAUL. 5. ALL EXPOSED SURFACES SHALL BE PERMANENTLY PROTECTED FROM EROSION WITH SEEDING AND/OR LANDSCAPING. SEED MIX SHALL BE 75 LB PER ACRE ANNUAL

RYGRASS OR APPROVED SUBSTITUTE. SEED SHALL BE COVERED WITH STRAW MULCH AT A RATE OF 2 TONS/ACRE. 6. ROCKED CONSTRUCTION ENTRANCE SHALL BE 25 FEET LONG BY 15 FEET WIDE AND

CONFORM TO THE FOLLOWING:

A. THE MATERIAL FOR THE PAD SHALL BE 3 TO 6 INCH STONE. B. PAD SHALL BE NOT LESS THAN 12" THICK.

C. THE ENTRANCE SHALL BE MAINTAINED IN A CONDITION THAT WILL PREVENT TRACKING OR FLOWING OF SEDIMENT ONTO PUBLIC RIGHT-OF-WAY. THIS MAY REQUIRE PERIODIC TOP DRESSING WITH ADDITIONAL STONE AS CONDITIONS DEMAND, AND REPAIR AND/OR CLEANOUT OF ANY MEASURES USED TO TRAP SEDIMENT. ALL SEDIMENT SPILLED, DROPPED, WASHED, OR TRACKED ONTO PUBLIC RIGHT-OF-WAY

SHALL BE REMOVED IMMEDIATELY. D. WHEN NECESSARY, WHEELS SHALL BE CLEANED TO REMOVE SEDIMENT PRIOR TO ENTRANCE ONTO PUBLIC RIGHT-OF-WAY. WHEN WASHING IS REQUIRED, IT SHALL BE DONE ON AN AREA THAT DRAINS TO THE CONCRETE WASHOUT AREA. 7. CONCRETE WASHOUT AREA SHALL BE SURROUNDED BY A SINGLE LAYER OF SAND BAGS TO CONTAIN FLUIDS. CHANNEL INTO AREA SHALL BE CLEARED TO ALLOW TIRE

### EROSION CONTROL POINT OF CONTACT

THIS PERSON WILL BE RESPONSIBLE FOR EROSION CONTROL AT THE SITE AND WILL BE THE COUNTY'S MAIN POINT OF CONTACT IF CORRECTIONS ARE REQUIRED.

NAME:\_\_\_\_JENNIFER RANDLE\_ TITLE/QUALIFICATION: OWNER \_\_\_917-547-0203\_

E-MAIL: jmareerandle@gmail.com

DEBRIS (SEE NOTE 6.D. ABOVE)

• THE TREE PROTECTION SHALL BE IN PLACE BEFORE ANY GRADING, EXCAVATING, OR GRUBBING IS STARTED.



Sigma Prime Geosciences, Inc	DATE: 5-15-19
SIGMA PRIME GEOSCIENCES, INC. 332 PRINCETON AVENUE HALF MOON BAY, CA 94019 (650) 728-3590 FAX 728-3593	DRAWN BY: CMK  CHECKED BY: AZG  SIGMA PRIME GEOSCIENCES, INC. 332 PRINCETON AVENUE HALF MOON BAY, CA 94019 (650) 728-3590  FAX 728-3593
	Sigma Prime Geosciences

SEDIMI. PLAN SION AND SCONTROL

SHEET

## LOW OR NO MOW FESCUE PLANTING EXISTING EUCALYPTUS -TREE HOSE BIBB -KXXXXXXXX BAT DING! PROPOSED HOUSE FOOTPRINT PANA PANDINA AND CAST-IN-PLACE -CONCRETE STEPS ASSORTED SUCCULENTS / (DAT / BAYDAAR) PROPOSED GARAGE FOOTPRINT BOARD FORMED -ASSORTED SUCCULENTS CONCRETE STEM WALL | 33" ROUND PERMEXBLE HOSE BIBB ---- CAST-IN-PLACE CONCRETE SIDEWALK LOW OR NO MOW -FESCUE PLANTING - GOOD NEIGHBOR FENCE PERVIOUS CONCRETE -- LOW OR NO MOW FESCUE PLANTING DRIVEWAY - PROPERTY LINE EL GRANADA BLUD



8 3/4" ROUND PERMEABLE GRAVEL



7 PERMEABLE CONCRETE



WOOD PANELED FENCE




NO MOW FESCUE



4 BOARD FORMED CONCRETE



7 PLANTED SUCCULENT IMAGERY

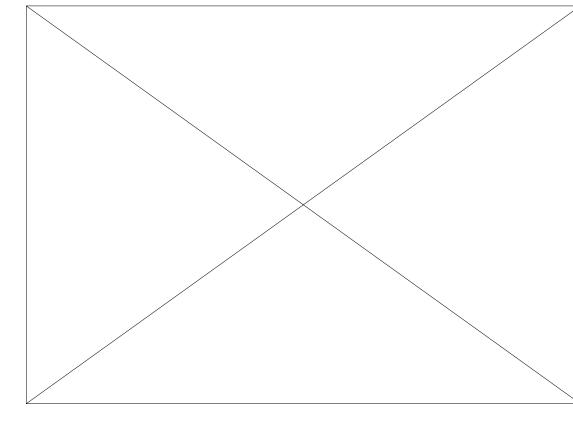

2 NOT USED NTS



WOOD DECK IMAGERY

## RANDLE RESIDENCE



PORTION LOT 14 EL GRANADA, CA

ISSUES AND REVISIONS

DATE DESCRIPTION
02.19.19 Design Review-Draft
06.03.19 Design Review


PROJECT NUMBER 190001

SHEET TITLE Conceptual Landscape Plan

**SCALE** 3/16" = 1'-0"

N

SHEET NUMBER

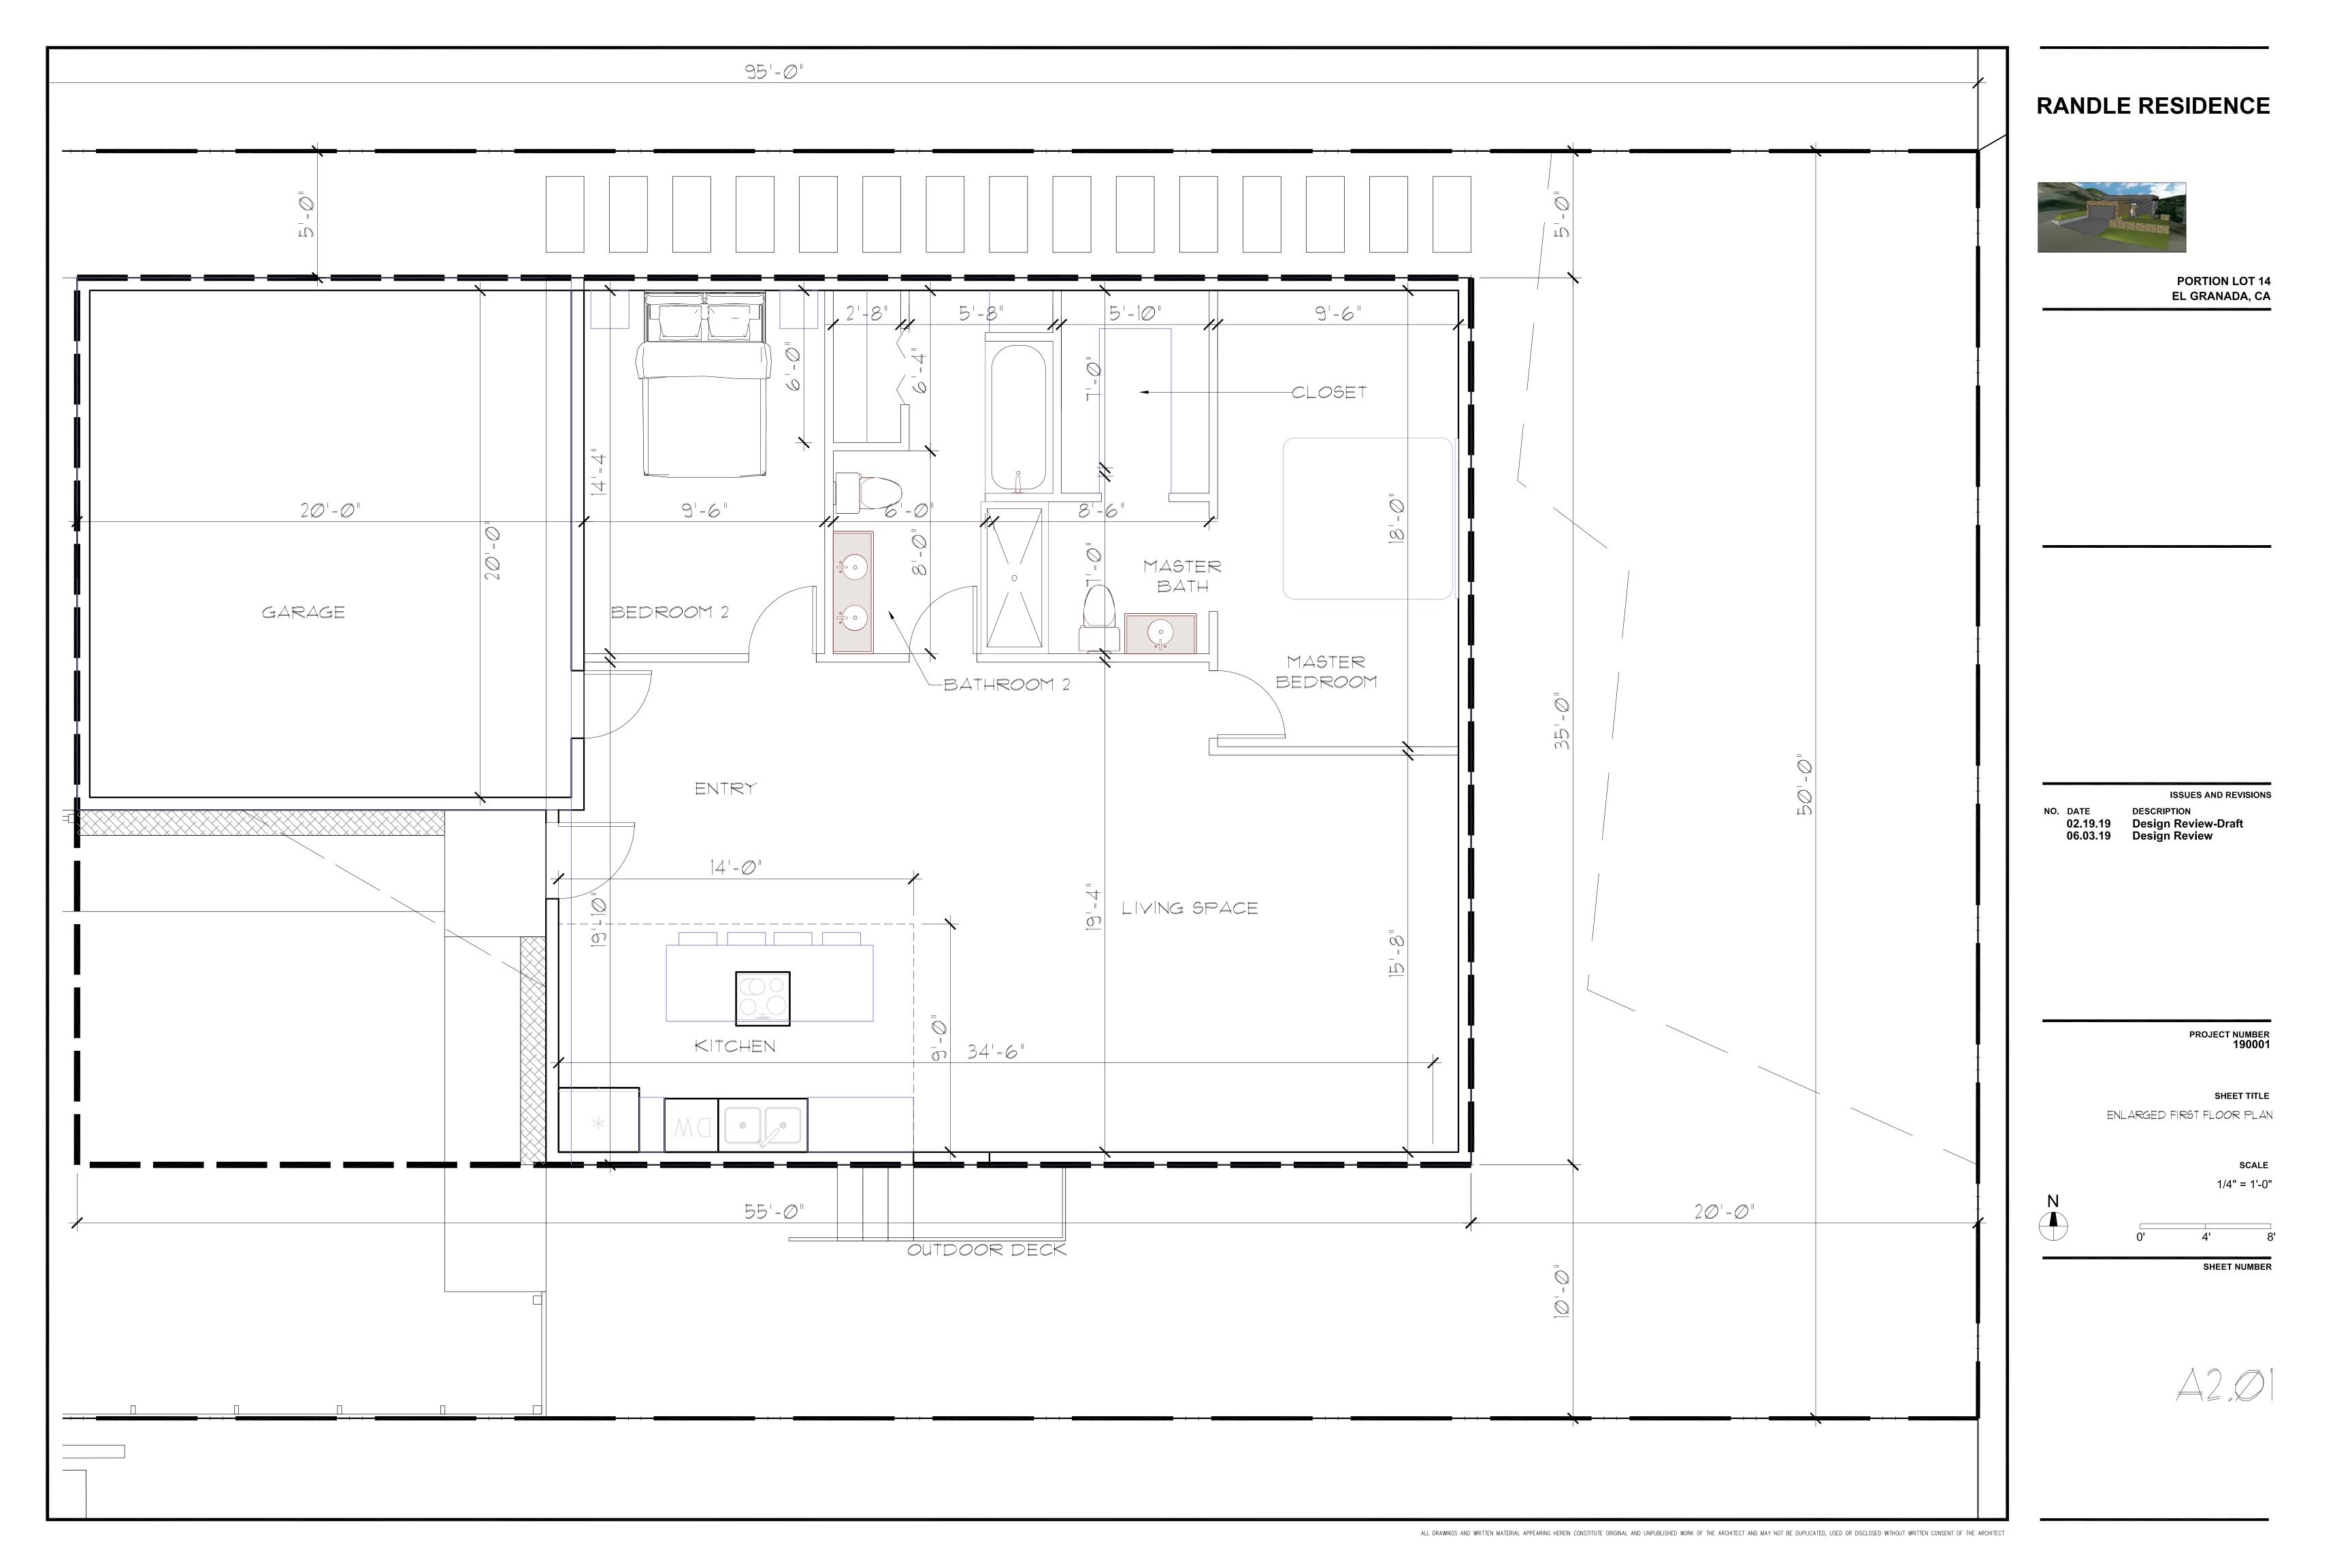

# 18 = 6 36 =6 | 13'-0" AFF EL: 114.2' 10'-6" AFF EL: 111.7' 13'-9" AFF EL: 114.95' INTERNAL DRAIN TO SCUPPER BELOW - DOWNSPOUT, SEE ELEVATIONS SLOPE AT 1/2" PER FOOT SLOPE AT 1/4" PER FOOT SLOPE AT 1/4" PER FOOT - SINGLE-PLY ROOFING MEMBRANE SLOPE AT 1/4" PER FOOT PERFOOT NO. DATE \_ INTERNAL DRAIN TO SCUPPER BELOW SLOPE AT 1/4" PER FOOT -GUTTER, SLOPES TO DOWNSPOUT - DOWNSPOUT, SEE ELEVATIONS EL: 114,95' — ALUMINUM PARAPET CAP ROOF PLAN ALL DRAWINGS AND WRITTEN MATERIAL APPEARING HEREIN CONSTITUTE ORIGINAL AND UNPUBLISHED WORK OF THE ARCHITECT AND MAY NOT BE DUPLICATED, USED OR DISCLOSED WITHOUT WRITTEN CONSENT OF THE ARCHITECT

## RANDLE RESIDENCE



PORTION LOT 14 EL GRANADA, CA

ISSUES AND REVISIONS
DATE DESCRIPTION
O2.19.19 Design Review-Draft
O6.03.19 Design Review

PROJECT NUMBER 190001

SHEET TITLE ROOF PLAN

SCALE 1/4" = 1'-0"

0' 4' 8

SHEET NUMBER

A2.02

## NATURAL WOOD WALL PANELING FACTORY FINISH, FORMED ALUMINUM CANOPY FACTORY FINISH, FORMED ALUMINUM ROOF FASCIA EL. 13'-9" T.O. ROOF - NATURAL WOOD ACCENT TRIM FACTORY FINISH, FORMED (HIGH PT) ALUMINUM PANEL TRIM EL. 10'-6" T.O. ROOF - CORRUGATED METAL WALL PANELING (GARAGE) ARCHITECTURAL CEMENT PLASTER CLEAR, TEMPERED SLIDING GLASS DOORS - CLEAR, TEMPERED WINDOW GLAZING EL. 0'-0" T.O. 1ST FLOOR WOODEN STAIR LANDING AND STEPS WITH STAINLESS STEEL CABLE GUARDRAIL CIVIL EL: 101.2 - EXPOSED CONCRETE STRUCTURE (PENDING STRUCTURAL DESIGN) BOARD FORMED CONCRETE FOUNDATION WALL

SOUTH ELEVATION

1/4" = 1'-0"

## RANDLE RESIDENCE



**PORTION LOT 14 EL GRANADA, CA** 

**ISSUES AND REVISIONS** 

DESCRIPTION

02.19.19 Design Review-Draft 06.03.19 Design Review

PROJECT NUMBER 190001

SHEET TITLE

PROPOSED ELEVATIONS

1/4" = 1'-0"

SHEET NUMBER



## - FACTORY FINISH, FORMED ALUMINUM ROOF FASCIA - FACTORY FINISH, FORMED EL. 13'-9" T.O. ROOF (HIGH PT) ALUMINUM PANEL TRIM - PAINTED STAINLESS STEEL GUTTER TO DOWNSPOUT EL. 10'-6" T.O. ROOF (GARAGE) - NATURAL WOOD ACCENT TRIM - CLEAR, TEMPERED FIXED WINDOW GLAZING - CLEAR, TEMPERED, OPERABLE WINDOW GLAZING EL. 0'-0" T.O. 1ST FLOOR CIVIL EL: 101.2 - EXPOSED CONCRETE STRUCTURE (PENDING STRUCTURAL DESIGN) - BOARD FORMED CONCRETE FOUNDATION WALL

EAST ELEVATION

1/4' = 1'-0'



## RANDLE RESIDENCE



PORTION LOT 14 EL GRANADA, CA

ISSUES AND REVISIONS

O. DATE DESCRIPTION
02.19.19 Design Review-Draft
06.03.19 Design Review

PROJECT NUMBER 190001

SHEET TITLE

PROPOSED ELEVATIONS

SCALE 1/4" = 1'-0"

4' 8'

SHEET NUMBER

43.02





PERSPECTIVE 4

7 PERSPECTIVE 3





RANDLE RESIDENCE



PORTION LOT 14 EL GRANADA, CA

ISSUES AND REVISIONS

O. DATE DESCRIPTION
02.19.19 Design Review-Draft
06.03.19 Design Review

PROJECT NUMBER 190001

SHEET TITLE
PERSPECTIVES

SCALE VARIE

SHEET NUMBER

 $\triangle A = 01$ 

PERSPECTIVE 1

PERSPECTIVE 2

