EDWARD C. LOVE, ARCHITECT

MARCH 14, 2016
PLN 2015-00561 CARKEEK-HARRIS RES.
LETTER OF NITEMT:
THE SITE IS UNUSUAL, BOTH IN SHAPE AND TOPOGRAPHY. THE SITE BOUNDAILIES AIRE THE OUTLINE OF A BOAT, WITH THE BOW AT THE VINTERSIECT ION OF AVENUE POINTOLA AND COLUMBUS STREET, AT THE MORTH END OF THE SITE. THIS VINTERSECTION HAS BEEN DETERMINED BY SMC PLANNING TO BE THE FRONT OF THE LOT.
THE SITE GENERALLY SLOPES DOWN, (~16') FROM COLUMBUS STREET ON THE EAST, TO AVENUE PORTOLA ON THE WEST.
THE HOUSE HAS BEEN DESIGNED AS A ZSTORY HOUSE, STEPPING DOWN THE SLOPE FROM COLUMBUS TO PORTOLA. AUTO ACCESS TO THE LOWER LEVEL GARAGES IS FROM POINTOLA, WHICH ELIMINATES THE HARD, TIGHT TURN ON TO COLUMBUS THE FORMAL, GUEST ENTRY, IS A LOWERED ENTRANCE ON COLUMBUS.
THE ROOF FORMS (HIP & SHED) BRING THRE VOLUME DOWN AND FOLLOW THE MATURAL SLOPE OF THE SITE.

720 Mill Street, Half Moon Bay, CA 94019 650-728-7615

edwardclovearchegmail.com

EDWARD C. LOVE, ARCHITECT

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LETTER O	OF WIENT	CONTINUED	MARCH 14, 20	11
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FREDRICK RAMOND | LANDSCAPE LIGHTING

WHERE TO BUY | LIVE HELP | WISH LIST

search keyword or item #

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INTERIOR LIGHTING

OUTDOOR LIGHTING

IDEA CENTER

OUR STORY

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 ${\bf Product\,Catalog \geq Outdoor\,Lighting \geq Lanterns}$





DRAKE 19900Z-GU24

Like { 0

View Full Collection

Dimensions + Resources

19900Z-GU24

Width:

7.5"

Height:

13.8"

Weight:

5.0 lbs

Material:

Die-Cast Aluminum

Glass:

Clear Inside Etched Seedy

Backplate Width:

5.0"

Backplate Height: Socket:

8.0"

Dark Sky:

1-18w GU24 With DSLG-40

Extension:

8.8"

TTO:

5.5"

View More (+)

RESOURCES

- + Find a Local Showroom
- + Lighting Made Simple Worksheet
- + Order a Finish Sample
- + Spec Sheet
- + Assembly Instructions
- + Share with a Friend

+ Add To Compare

+ Add to Wishlist



Finish Options


Related Products







Columbus Street - PLN2016-00561 HARRIS MAP

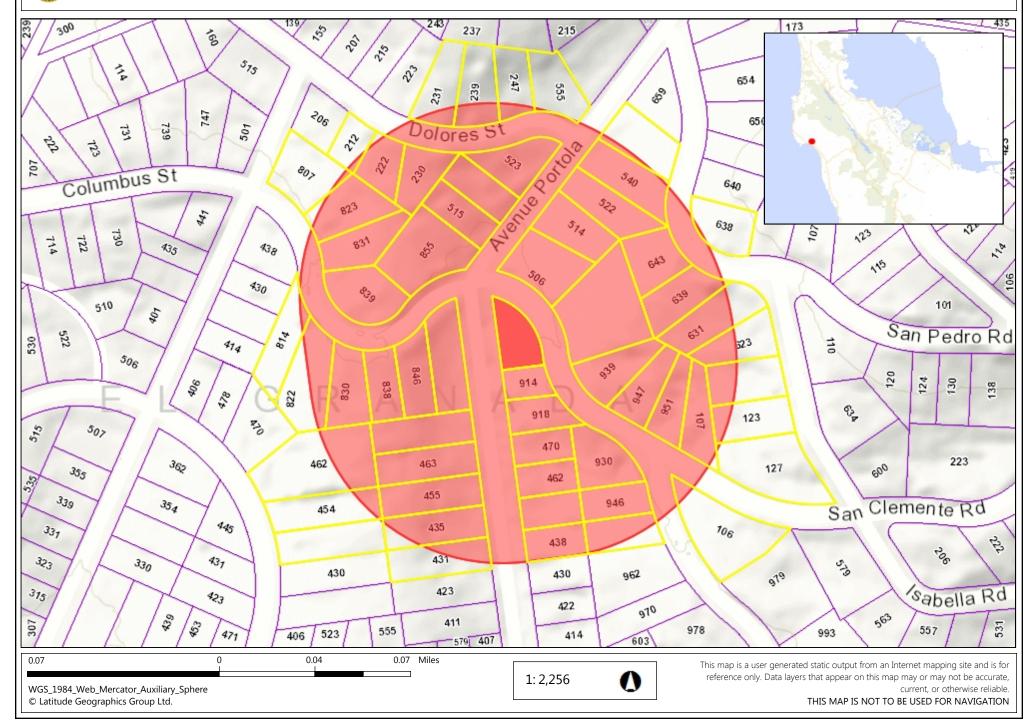





Describe Project:

SINGLE FAMILY, WOOD

FIZAME PRESIDENCE

County Government Center = 455 County Center = Redwood City CA 94063 Mail Drop PLN 122 = 650 • 363 • 4161 = FAX 650 • 363 • 4849

Permit #: PLN _ 2015 - 6056

☐ Home Improvement Exception

Non-Conforming Use Permit

Off-Street Parking Exception

Variance

Other Permit #: PRE 2015-00068

Address: 120 HALF Mod Phone, WGD-72 Email: ed ward Architect or D	ARD C. LOVE, AIRCH MILL STREET ON BAYZID: 94019 -8-7615 +650-728-1723 Iclovearch@gmail.co. esigner (if different from Applicant E AS ABOVE	Address: P.O. Box 1581 EL GIZAMADA Zip: 940/8 Phone, 1650-766-0943 H650-766-8222 m Email: bharris@coastside.net
Address:	C AS AISOVE	Zip:
Phone, W:	H:	Email:
EL GRAN		Site Description: X Vacant Parcel Existing Development (Please describe):
557	Family Residence: 3,244 sq. f	The state of the s

1. Marchals and Parks of Concess Suitables or Structures

Fill in Blanks:	Material	Color/Finish	Check if matches existing
		(If different from existing, attach sample)	3
a. Exterior walls	HARDIE-PLANK/STONE VENE HARDIE-TIZIM	FUSTIC / MANZONI	TØ a
b. Trim	HARDIE-TIZIM	IRON GREY PAINT	
c. Windows	VINYL	11111	
d. Doors	FIBEIZGLASS/WOOD	/ TON GIZAY STAIN	
e. Roof	COMP SHINGLES	DARKE BROWN/BLACK	
f. Chimneys	N.A.		
g. Decks & railings	REDWOOD	NATURAL STAIN	
h. Stairs	REDWOOD	//	
i. Retaining walls	EL DORADO STONE	MONZANITA CLIFFSTON	WE
j. Fences	REDWOOD	NATURAL STAIN	
k. Accessory buildings	N.A.		
I. Garage/Carport	WOOD DOORS	NATURAL STAIN	
including the required fin applicable to the location	on, the County must determine that this projectings that the project does conform to the of the project pursuant to Section 6565.10 of the project of project compliance with statement of project compliance with statement.	standards and guidelines for design rev	iew
(Optional) Applical	it's statement or project compliance with sta	andarus and guidennes (check ir attacht	3(I).
I haraby cartify that the in	formation stated above and an farms, plan		
support of the application	nformation stated above and on forms, plans in is true and correct to the best of my knowl assigned project planner of any changes to in	edge. It is my responsibility to inform th	e County of
Dru	Hand E	LA Cone	
Owner:	Applicant		
			i .
12-16-	-15	11111	
Date:	Date:	16/15	

Environmental Information Disclosure Form PLN 2015 - 00 56 1 **Disclosure Form**

BLD____

Project Address: 914 COWMBUS			Name of Owners USAH CAPTICE IS I HARRIS
Assesso	or's Parc	el No.047 - 243 - 010	Name of Applicant: Fow Arro C. LOVE ARCHADARD Address: 720 MILL ST
Zoning	District:	R-1/5-17/CD/DIZ	HMB 94619 Phone: 650-728-7615
Parcel s	ize:		uses on the project parcel, including the existence and
purpose creeks,	of any evegetation	asements on the parcel, and a description of	any natural features on the project parcel (i.e. steep terrain,
		Environmental Quality Act (CEQA) I	Review
Yes	No	Will this project involve:	
	X	 a. Addition to an existing structure > 50% of b. Construction of a new multi-family residence. c. Construction of a commercial structure > 	ential structure having 5 or more units?
X	,	 d. Removal of mature tree(s) (≥ 6" d.b.h. ir residential zoning district)? If yes, how many trees to be removed? _ 	n Emerald Lake Hills area or ≥ 12" d.b.h. in any
X		e. Land clearing or grading? If yes, please state amount in cubic yard Excavation: 2 4 c.y.	s (c.y.): Fill: c.y.
	X	f. Subdivision of land into 5 or more parcel	
	X	g. Construction within a State or County sce	enic corridor?
	\rightarrow	h. Construction within a sensitive habitat?	
	/X	i. Construction within a hazard area (i.e. se	
	<u> </u>	j. Construction on a hazardous waste site (check with Co. Env. Health Division)?
107/25/2	Tre	all "Yes" answers: EES TO BE IZEMOVEOS ,	SPOR IN FOOTPRINT OF DISEASED
- 8	Exc	EDVATION FOR CREDUL	SPACE

EDWARD C. LOVE, ARCHITECT

CARKERY-HARRIS RESIDENCE
TREE REMOVAL LIST
WITHIN FOOT PRINT & ADJACENT TO FOUNDATION:
EUCALYPTUS: 3010", Z012", 1040"
v.f
PINE: 2032", [024", 1010"
AT STIZEET:
EUCALYPTUS' 1@60", 1@48"

720 Mill Street, Half Moon Bay, CA 94019 650-728-7615



Certificate of Exemption or Exclusion from a Coastal Development Permit PRE 2015-00068 Permit #: PLN 2015-00561

Permit #: BLD

455 County Center, 2nd Floor • Redwood City, CA • 94063 Mail Drop: PLN 122 • TEL (650) 363-4161 • FAX (650) 363-4849

Permanent Record Microfilming Required

Owner Name: SUS AN CAIRKEEK & BRUGH HON Address: P.O. BOX 1581	Applicant EDUPRO C. LOVE, AIRCH Address: 720 MILL STREET
	HALF MOON BAYZID: 94019 Phone \$50-728-7615 \$50-728-1723 Email Addressed ward clove arch@gme
Project Description: NEW SINGLIE FAMILY [ZES IDENCE ON 6,7059.FT LOT Assessor's Parcel Number(s): 047-243-010	Existing water source: Utility connection CCWD Well Proposed water source: Utility connection CCWD Well Staking of well location and property lines are required. Year Provide site plan depicting location and all trees. Will this require any grading or vegetation/tree removal? Yes No If Yes, additional permits may be required. Such as: Tree Removal Permit, Grading Permit, Land Clearing Permit, Coastal Development Permit.
We have reviewed this form as completed above and the basis for basis for exemption or exclusion are true and correct to the best of in accordance with the terms of the exemption/exclusion category exemption or exclusion issued for a water yell and/or storage tank event the future house, the well, and/or storage tank requires a very the future house. The well and/or storage tank requires a very the future house. The well and/or storage tank requires a very the future house. The well and for the basis for a water well and for a w	f our knowledge and we hereby agree to carry out this project y selected on reverse. We also understand and agree that any k in the single family exclusion area will be igvalidated in the

(Both Owner and Applicant must sign unless this Application for Exemption or Exclusion accompanies a Building Permit Application for which the Applicant is an agent for the Owner acceptable to the Building Inspection Section.)

Staff Use Only

4. Basis of Examplian or Exclusion

Use attached review sheet to determine basis of exemption and whether project qualifies. Review basis of exemption with applicant/owner and initial appropriate category below:

application	Towner and initial appropriate category below:	
PI B. II C. E D. F D. F D. S	improvements to Existing Single Family Residence. PRC 30610(a), CCAG 13250, ZR 6328.5(a)] improvements to Existing Structure Other Than ingle Family Residence or Public Works Facility. [PRC 0610(b), CCAG 13253, ZR 6328.5(b)] Existing Navigation Channel. [PRC 30610(c), R 6328.5(c)] Repair or Maintenance Activity. RC 30610(d), CCAG 13252, ZR 6328.5(d)] Single Family Residence Categorical Exclusion Area. RC 30610(e), CCAG 13240, AB 643, ZR 6328.5(e)]	 F. Agriculturally-Related Development Categorical Exclusion Area. [PRC 30610(e), CCAG 13240, ORDERS E-79-7 and E-81-1, ZR 6328.5(e)] G. Utility Connections. [PRC 30610(f), ZR 6328.5(f)] H. Replacement of Structures Following Disasters. [PRC 30610(g), ZR 6328.5(g)] I. Emergency Activities. [PRC 30611, ZR 6328.5(h)] J. Lot Line Adjustment. [ZR 6328.5(i)] K. Land Division for Public Recreation Purposes. [ZR 6328.5(l)]
	all inspection - 11 Secretal Zo	
☐ Req	quired	
nspection	n made by:	Date of Inspection:
Yes	Removal of trees? If Yes, is tree removal permit included? Trimming of trees? Excessive removal of vegetation? Excessive grading? (If Yes, CDP is required) Erosion control plan required?	Approval of Permit is subject to the following: (check if applicable) Submittal and Approval of a Tree Removal Permit Submittal and Approval of a Grading Permit Submittal and Approval of an Erosion Control Plan Submittal and Approval of a Coastal Dev. Permit
thecked a Exemption	above. on/Exclusion is approved.	
,	Department subject to the following condition(s) of approval:	Date
Orig file. Copi	collected ginal Certificate of Exemption to Building Inspection lies of Certificate of Exemption to: applicant/Owner. lanning Department Exemption Binder.	Any relevant Planning or Building Inspection files. A. California Coastal Commission, 45 Fremont Street, Suite 2000, San Francisco, CA 94105 Update Permit*Plan Case Screen and Activities





C.3 and C.6 Development Review Checklist Municipal Regional Stormwater Permit (MRP)

Stormwater Controls for Development Projects

COUNTY OF SAN MATEO Planning & Building Dept. 455 County Center, 2nd Floor (650) 363-1825

http://planning.smcgov.org/

	Project Informa	ntion			
4	Enter Project Data (Fo	or "C.3 Regulated Projects," (data will be reported	in the municipality's stormwater Annual Repo	ort.)
	Project Name	Carkeek		Case Number:	1
	Project Address & Cros	ss St. Avenue Porto	la, at Columb	us St.	
	Project APN:	047-243-010	Projec	t Watershed: Ocean	
	Applicant Name:	Bruce Harris			
	Applicant Phone:	650-766-8222	Applic	ant Email Address: bharris@coasts	side.net
	Development type: (check all that apply)	Single Family Reside Single Family Reside Multi-Family Reside Commercial Industrial, Manufac Mixed-Use Streets, Roads, etc Redevelopment' as impervious surface Special land use gasoline outlets, (3) project) Institutions: schools Parks and trails, car Agricultural, wineries Kennels, Ranches	dential: A stand-aldential: Two or modential turing s defined by MRP: on a site where parategories' as depressaurants, (4) use, libraries, jails, etemp grounds, others	creating, adding and/or replacing exteriors development. creating, adding and/or replacing exteriors development has occurred. fined by MRP: (1) auto service facilities incovered parking area (stand-alone or poc.	or existing (2) retail
	Project Description ⁴ : New house on vacant lot.				ıä
	(Also note any past or future phases of the project.)	146W HOUSE OH VE	acantiot.		
.A.1	Total Area of Site	0.14	acres		
.A.2	Total Area of land distu	rbed during construction		grading, excavating and stockpile area)	0.10 acr
rtific I ce nev	eation: ertify that the information v and/or replaced imperv	n provided on this form is	s correct and ackr this form, the as-b	nowledge that, should the project exceeduilt project may be subject to additional is	mprovements.
		the form Char		Title: Engine	
	nature			Date:	
D.	one number 650-7	728-3590		dress sigmaprm@pacbell.net	

Subdivisions or contiguous, commonly owned lots, for the construction of two or more homes developed within 1 year of each other are considered common plans of development and are subject to C.3 requirements.

Roadway projects that replace existing impervious surface are subject to C.3 requirements only if one or more lanes of travel are added

See Standard Industrial Classification (SIC) codes here

Project description examples: 5-story office building, industrial warehouse, residential with five 4-story buildings for 200 condominiums. etc.

I.B Is the project a "C.3 Regulated Project" per MRP Provision C.3.b?

I.B.1 Enter the amount of impervious surface Retained, Replaced and/or Created by the project:

Table I.B.1 Impervious and Pervious Surfaces

	I.B.1.a	I.B.1.b	I.B.1.c	I.B.1.d	I.B.1.e
Type of Impervious Surface	Pre-Project Impervious Surface (sq.ft.)	Existing Impervious Surface to be Retained ⁶ (sq.ft.)	Existing Impervious Surface to be Replaced ⁶ (sq.ft.)	New Impervious Surface to be Created ⁶ (sq.ft.)	Post-Project Impervious Surface (sq.ft.) (=b+c+d)
Roof area(s)	0	0	0	2405	2405
Impervious ⁵ sidewalks, patios, paths, driveways, streets	0	0	0	790	790
Impervious ⁵ uncovered parking ⁷	0	0	0	0	0
Totals of Impervious Surfaces:	0	0	0	3195	3195
I.B.1.f - Total Impervious Surface Replaced and Create	ed (sum of total	s for columns I.E	3.1.c and I.B.1.d)	:	3195
Type of Pervious Surface	Pre-Project Pervious Surface (sq.ft.)				Post-project Pervious Surface (sq.ft.)
Landscaping	6170				2975
Pervious Paving	0				0
Green Roof	0				0
Totals of Pervious Surfaces:	6170				2975
Total Site Area (Total Impervious+Total Pervious=I.A.1)	6170			land and a second	6170

I.B.2 Please review and attach additional worksheets as required below using the Total Impervious Surface Replaced and Created in cell I.B.1.f from Table I.B.1 above and other factors:

	Check all that apply:	Check If Yes	Attach Worksheet
I.B.2.a	Does this project involve any earthwork?	X	А
I.B.2.b	Is I.B.1.f greater than or equal to 2.500 sq.ft? If YES, the Project is subject to Provision C.3.i.	X	B, C
I.B.2.c	Is the total Existing Impervious Surface to be Replaced (column I.B.1.c) 50 percent or more of the total Pre-Project Impervious Surface (column I.B.1.a)? If YES, site design, source control and treatment requirements apply to the whole site; if NO, these requirements apply only to the impervious surface created and/or replaced.		
I B.2.d	Is this project one of the Special Land Use Categories (box checked in section I.A. above) and is I.B.1.f greater than or equal to 5,000 sq.ft? If YES, project is a C.3 Regulated Project.		D. D-1, D-2
I.B.2.e	Is I.B.1.f greater than or equal to 10,000 sq.ft? If YES, project is a C.3 Regulated Project.		D. D-1, D-2
I.B.2.f	Is I.B.1.f greater than or equal to 43,560 sq.ft. (1 acre)? If YES, project may be subject to Hydromodification Management requirements.		E
I.B.2.g	Is I.A.2 (pg. 1) greater than or equal to 1 acre? If YES, obtain coverage under the state's Construction General Permit and submit to the municipality a copy of your Notice of Intent. See: www.swrcb.ca.gov/water issues/programs/stormwater/construction.shtml		
I.B.2.h	Is this a Special Project or does it have the potential to be a Special Project?		F
I.B.2.i	Is this project a High Priority Site? (Determined by the Permitting Jurisdiction. High Priority Sites can include those located in or within 100 feet of a sensitive habitat, ASBS, or body of water, or on sites with slopes, and are subject to monthly inspections from Oct 1 to April 30.)		G
B.2.10	For Municipal Staff Use Only (Alternative Certification, O&M Submittals, Project Close Out)		G

Per the MRP, pavement that meets the following definition of pervious pavement is NOT an impervious surface. Pervious pavement is defined as pavement that stores and infiltrates rainfall at a rate equal to immediately surrounding unpaved, landscaped areas, or that stores and infiltrates the rainfall runoff volume described in Provision C.3.

[&]quot;Retained" means to leave existing impervious surfaces in place, unchanged; "Replaced" means to install new impervious surface where existing impervious surface is removed anywhere on the same property; and "Created" means the amount of new impervious surface being proposed which exceeds the total existing amount of impervious surface at the property.

Uncovered parking includes the top level of a parking structure.

Worksheet A

C6 - Construction Stormwater BMPs

Identify Plan sheet showing the appropriate construction Best Management Practices (BMPs) used on this project: (Applies to all projects with earthwork)

Yes	Plan Sheet	Best Management Practice (BMP)
	BMP Sheet	Control and prevent the discharge of all potential pollutants, including pavement cutting wastes, paints, concrete, petroleum products, chemicals, wash water or sediments, rinse water from architectural copper, and non-stormwater discharges to storm drains and watercourses.
	BMP Sheet	Store, handle, and dispose of construction materials/wastes properly to prevent contact with stormwater.
	BMP Sheet	Do not clean, fuel, or maintain vehicles on-site, except in a designated area where wash water is contained and treated.
	BMP Sheet	Train and provide instruction to all employees/subcontractors re: construction BMPs.
		Protect all storm drain inlets in vicinity of site using sediment controls such as berms, fiber rolls, or filters.
		Limit construction access routes and stabilize designated access points.
	BMP Sheet	Attach the San Mateo Countywide Water Pollution Prevention Program's construction BMP plan sheet to project plans and require contractor to implement the applicable BMPs on the plan sheet.
X	C-1	Use temporary erosion controls to stabilize all denuded areas until permanent erosion controls are established.
		Delineate with field markers clearing limits, easements, setbacks, sensitive or critical areas, buffer zones, trees, and drainage courses.
		 Provide notes, specifications, or attachments describing the following: Construction, operation and maintenance of erosion and sediment controls, include inspection frequency; Methods and schedule for grading, excavation, filling, clearing of vegetation, and storage and disposal of excavated or cleared material; Specifications for vegetative cover & mulch, include methods and schedules for planting and fertilization; Provisions for temporary and/or permanent irrigation.
X	C-1	Perform clearing and earth moving activities only during dry weather.
		Use sediment controls or filtration to remove sediment when dewatering and obtain all necessary permits.
X	C-1	Trap sediment on-site, using BMPs such as sediment basins or traps, earthen dikes or berms, silt fences, check dams, soil blankets or mats, covers for soil stock piles, etc.
		Divert on-site runoff around exposed areas; divert off-site runoff around the site (e.g., swales and dikes).
X	C-1	Protect adjacent properties and undisturbed areas from construction impacts using vegetative buffer strips, sediment barriers or filters, dikes, mulching, or other measures as appropriate.

Worksheet B

C3 - Source Controls

Select appropriate source controls and identify the detail/plan sheet where these elements are shown.

Yes	Detail/Plan Sheet No.	Features that require source control measures	Source Control Measures (Refer to Local Source Control List for detailed requirements)			
		Storm Drain	Mark on-site inlets with the words "No Dumping! Flows to Bay" or equivalent.			
		Floor Drains	Plumb interior floor drains to sanitary sewer ⁸ [or prohibit].			
		Parking garage	Plumb interior parking garage floor drains to sanitary sewer. ⁸			
	-	Landscaping	 Retain existing vegetation as practicable. Select diverse species appropriate to the site. Include plants that are pest-and/or disease-resistant, drought-tolerant, and/or attract beneficial insects. Minimize use of pesticides and quick-release fertilizers. Use efficient irrigation system; design to minimize runoff. 			
		Pool/Spa/Fountain	Provide connection to the sanitary sewer to facilitate draining.8			
		Food Service Equipment (non-residential)	Provide sink or other area for equipment cleaning, which is: Connected to a grease interceptor prior to sanitary sewer discharge. Large enough for the largest mat or piece of equipment to be cleaned. Indoors or in an outdoor roofed area designed to prevent stormwater run-on and run-off, and signed to require equipment washing in this area.			
		Refuse Areas	 Provide a roofed and enclosed area for dumpsters, recycling containers, etc., designed to prevent stormwater run-on and runoff. Connect any drains in or beneath dumpsters, compactors, and tallow bin areas serving food service facilities to the sanitary sewer.⁸ 			
		Outdoor Process Activities 9	Perform process activities either indoors or in roofed outdoor area, designed to prevent stormwater run-on and runoff, and to drain to the sanitary sewer. ⁸			
		Outdoor Equipment/ Materials Storage	 Cover the area or design to avoid pollutant contact with stormwater runoff. Locate area only on paved and contained areas. Roof storage areas that will contain non-hazardous liquids, drain to sanitary sewer⁸, and contain by berms or similar. 			
		Vehicle/ Equipment Cleaning	 Roofed, pave and berm wash area to prevent stormwater run-on and runoff, plumb to the sanitary sewer⁸, and sign as a designated wash area. Commercial car wash facilities shall discharge to the sanitary sewer.⁸ 			
		Vehicle/ Equipment Repair and Maintenance	 Designate repair/maintenance area indoors, or an outdoors area designed to prevent stormwater run-on and runoff and provide secondary containment. Do not install drains in the secondary containment areas. No floor drains unless pretreated prior to discharge to the sanitary sewer.⁸ Connect containers or sinks used for parts cleaning to the sanitary sewer.⁸ 			
		Fuel Dispensing Areas	 Fueling areas shall have impermeable surface that is a) minimally graded to prevent ponding and b) separated from the rest of the site by a grade break. Canopy shall extend at least 10 ft. in each direction from each pump and drain away from fueling area. 			
		Loading Docks	 Cover and/or grade to minimize run-on to and runoff from the loading area. Position downspouts to direct stormwater away from the loading area. Drain water from loading dock areas to the sanitary sewer.⁸ Install door skirts between the trailers and the building. 			
		Fire Sprinklers	Design for discharge of fire sprinkler test water to landscape or sanitary sewer. ⁸			
		Miscellaneous Drain or Wash Water	 Drain condensate of air conditioning units to landscaping. Large air conditioning units may connect to the sanitary sewer.⁸ Roof drains from equipment drain to landscaped area where practicable. Drain boiler drain lines, roof top equipment, all wash water to sanitary sewer.⁸ 			
		Architectural Copper Rinse Water	 Drain rinse water to landscaping, discharge to sanitary sewer⁸, or collect and dispose properly offsite. See flyer "Requirements for Architectural Copper." 			

Any connection to the sanitary sewer system is subject to sanitary district approval.
 Businesses that may have outdoor process activities/equipment include machine shops, auto repair, industries with pretreatment facilities.

Worksheet C

Low Impact Development – Site Design Measures

Select Appropriate Site Design Measures (Required for C.3 Regulated Projects; all other projects are encouraged to implement site design measures, which may be required at municipality discretion.) Projects that create and/or replace 2,500 – 10,000 sq.ft. of impervious surface, and stand-alone single family homes that create/replace 2,500 sq.ft. or more of impervious surface, must include **one of Site Design Measures a through f** (Provision C.3.i requirements). ¹⁰ Larger projects must also include applicable Site Design Measures g through i. Consult with municipal staff about requirements for your project.

Select appropriate site design measures and Identify the Plan Sheet where these elements are shown.

Yes	Plan Sheet Number	
		Direct roof runoff into cisterns or rain barrels and use rainwater for irrigation or other non-potable use.
		b. Direct roof runoff onto vegetated areas.
		c. Direct runoff from sidewalks, walkways, and/or patios onto vegetated areas.
×	C-1	d. Direct runoff from driveways and/or uncovered parking lots onto vegetated areas.
		e. Construct sidewalks, walkways, and/or patios with pervious or permeable surfaces.
		f. Construct bike lanes, driveways, and/or uncovered parking lots with pervious surfaces.
		g. Limit disturbance of natural water bodies and drainage systems; minimize compaction of highly permeable soils; protect slopes and channels; and minimize impacts from stormwater and urban runoff on the biological integrity of natural drainage systems and water bodies;
		h. Conserve natural areas, including existing trees, other vegetation and soils.
X	C-1	i. Minimize impervious surfaces.

Regulated Projects can also consider the following site design measures to reduce treatment system sizing:

Yes	Plan Sheet Number	
		j. Self-treating area (see Section 4.2 of the C.3 Technical Guidance)
		k. Self-retaining area (see Section 4.3 of the C.3 Technical Guidance)
		I. Plant or preserve interceptor trees (Section 4.1, C.3 Technical Guidance)

See MRP Provision C.3.a.i.(6) for non-C.3 Regulated Projects, C.3.c.i.(2)(a) for Regulated Projects, C.3.i for projects that create/replace 2,500 to 10,000 sq.ft. of impervious surface and stand-alone single family homes that create/replace 2,500 sq.ft. or more of impervious surface.
5
Final Draft October 31, 2014



San Mateo County

Planning and Building Department **Certificate of Compliance Type A** (for parcel legalization)

455 County Center • Redwood City • CA • 94063 Mail Drop PLN 122 • Phone: 650 • 599 • 7310

Companion Page

Instructions

Please fill out the general Planning Permit Application Form and this form when applying for a Certificate of Compliance Type A. You must also submit all items listed below.

2. Basic Information	
Civil Engineer/Land Surveyor (only if required) Name: BGT (BRYAH TAYLOR) Phone: C50-212-1030	Address: 1206 S. AMPHLIETT BLVD, Sur San Matteo Zip: 94402 License #: 755/
3. Project Information	
Street/road frontage or closest access:	Existing development/uses on property:
AVE. PORTOLD & COLUMBUS	NONE
Water supply:	
well water district: <u>CC W D</u> Sewage disposal:	Does legalization sought match current Assessor's Parcel boundaries?
septic sanitary district: EL GRANADA	
A Application Popularies	

THE PROPERTY OF THE PROPERTY O

- Fees
- Land Division history, tracing history of parcel(s), including previous parcel(s) of which it is a part, back to last legal parcel or to its original creation. History shall include:
 - (1) the date the subject parcel was first created;
 - (2) all deed references (Document # or Volume/Book/Page);
 - (3) a map depicting the parcel boundaries; and
 - (4) a chain of title narrative that traces all such deed

- history from the parcel's initial creation to the present (current owner), with graphics references, where necessary, on accompanying maps
- If this legalization is triggered by the Witt/Abernathy cases, consult the 1-8-2010 "Legalization of Parcels" policy.
- Topographic and Boundary Survey of Parcel(s) ₩
- Building permit history on the house or other principal use may be required, obtainable from the Building records or the "parcel history" from the Assessors Office.

NOTE: If, upon review of the Type A application, it is determined that a Type B Certificate of Compliance is required, a topographic and boundary survey will be required, as well as other possible property improvements and planning applications.



Columbus Ave

Siding: Weiss Cascade River Rock



Roofing: Certainteed Style



Rock Veneer: Eldorado Stone Manzanita Cliffstone





GENERAL NOTES

- A. Before submitting a proposal for this work, the bidder shall visit the site and learn the existing conditions. He shall examine the plans and specifications and base his bid on them. During construction, no changes from plans and specifications shall be made without written consent of the Architect and Owner. Structural changes must be approved by the Architect and Structural Engineer.
- B. The General Contractor (G.C.) shall obtain and pay for all permits (except those paid for by the Owner) and licenses and shall give all notices. The G.C. is required to comply with all current Codes, Ordinances, & Regulations related to this project. Any conflict between drawings, specifications and ordinances shall be immediately referred to the Architect in writing. The G.C. for this work shall be currently licensed by the State of California. The employees and Subcontractors used by the G.C. to construct and finish the work shown on the plans must all be skilled workmen under the directions of a competent foreman. The G.C. shall continuously maintain adequate protection of all work from damage and shall protect the Owner's property and adjacent property from injury, damage, or loss arising from this contract. Sales tax shall be paid by the G.C. and included in the bid.
- C. The G.C. shall, at all times, keep the premises and streets free of waste and rubbish caused by the work, and at completion, shall remove all rubbish, surplus materials and equipment and leave the work 'broom clean'. The G.C. shall verify the location of all existing underground utilities prior to excavation and shall maintain, keep in service, and protect against damage, all existing utilities and city services during construction. Any existing utilities to be abandoned shall be properly disconnected, plugged, or capped as required by code and/or sound construction practices. G.C. to provide an operation and maintenance manual will be provided to occupant or owner per Section 4.410.1.
- D. The Owner may order extra work or make changes by altering, adding to, or deducting from the work. The Contract sum shall be adjusted accordingly and adequate records shall be kept by the G.C. to substantiate any additional charges. All such work shall be executed under the conditions of the original Contract Documents.
- E. The Owner shall not be liable or responsible for any accident, loss, injury, or damages happening or accruing during the term of the performance of the work and in connection therewith, to persons and/or property. The G.C. shall have in full force and effect during the life of this Contract, full coverage Liability and Workmen's Compensation Insurance, which shall comply with California laws and will not be canceled or changed during the term of this Contract without notice being given to the Owner, and shall require all intermediate and Subcontractors to take out and maintain similar policies of insurance. All such policies shall be with insurance companies acceptable to the Owner. Unless expressly stated otherwise, the Owner will take out and carry a comprehensive insurance policy including fire, extended coverage, vandalism and malicious mischief protecting both his interest and that of the G.C.
- F. In addition to quarantees called for elsewhere in these specifications, the G.C. shall guarantee all work for a period of one (1) year after notice of completion is filed, against defective materials or faulty workmanship, that is discovered and reported within that period.

- 6. In general the drawings will indicate dimensions, position, type of construction, specifications, qualities and methods. Any work indicated on the drawings, and not mentioned in the specifications, or vice versa, shall be furnished as though fully set forth in both. Work not particularly detailed, marked, or specified shall be the same as similar parts that are detailed, marked or specified. The larger the scale of the drawing, the more precedent, i.e.: 3 inches per foot scale governs 1/4 inch per foot scale. Written dimensions on these drawings shall have precedence over scaled dimensions. Written dimensions are approximate and must be verified by G.C. The G.C. shall verify, and be responsible for all existing conditions and dimensions prior to, and during, all phases of
- H. If any Subcontractor finds any lack of information, discrepancy, and/or omissions in these drawings, or if the Subcontractor is unclear as to the drawings' meaning and/or intent, the Subcontractor shall contact the G.C., who shall then contact the Architect at once for interpretation and/or clarification before proceeding with that portion of the work.
- I. The G.C. shall provide adequate concealed blocking and anchoring for all ceiling- and wall-mounted equipment, hardware, fixtures, and accessories.
- J. All products listed in these drawings by ICBO/NER number shall be installed per the report and manufacturer's written instructions. Product substitution for products listed shall also have an ICBO/NER-approved written evaluation report and be approved and listed by other nationally-recognized testing agencies.
- K. Exterior openable windows and doors shall be weatherstripped. All open joints, penetrations, and other openings in the building envelope shall be sealed, caulked, gasketed, and/or weatherstripped to limit, or eliminate, air leakage.
- L. See structural sheets for structural materials, dimensions and details.
- M. See attached Title 24 forms and/or calculation for project energy efficiency requirements.
- N. A capillary break shall be installed if a slab on grade foundation system is used. the use of a 4" thick bas of 1/2" or larger clean aggregate under a 6 mil vapor retarder with joint lapped not less than 6" will be provided per Section 4.505.2 and R506.2.3.
- O. Upon request, verification of compliance with the relevant Codes may include construction documents, plans, specifications, builder or installer certification, inspection reports, or other methods acceptable to the Building Official which show substantial conformance.

SITE DATA APN: 047-243-010 ZONING: R-1/S-17/CD/DR OCCUPANCY GROUP: R-3/U

TYPE OF CONSTRUCTION: V-N

APPLICABLE CODES

2013 CALIFORNIA ENERGY CODE 2013 CALIFORNIA FIRE CODE

TO THE CALIFORNIA BUILDING CODE

SAN MATEO COUNTY


SAN MATEO COUNTY ZONING AND BUILDING ORDINANCES 2013 CALIFORNIA RESIDENTIAL CODE

2013 CALIFORNIA GREEN BUILDING STANDARDS CODE


2013 CALIFORNIA BUILDING CODE AND AMENDMENTS 2013 CALIFORNIA MECHANICAL CODE 2013 CALIFORNIA PLUMBING CODE 2013 CALIFORNIA ELECTRICAL CODE

ANY APPLICABLE COUNTY CODES, ORDINANCES OR AMENDMENTS

	AREA (SQ. FT.)	%	AREA (SQ. F	=T.)	%	AREA (SQ.	FT.)	%	AREA (SQ. FT.)	%
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PARCEL COVERAGE	<u> </u>			2159	34.9		2159	34.9	2160	35. <i>0</i>
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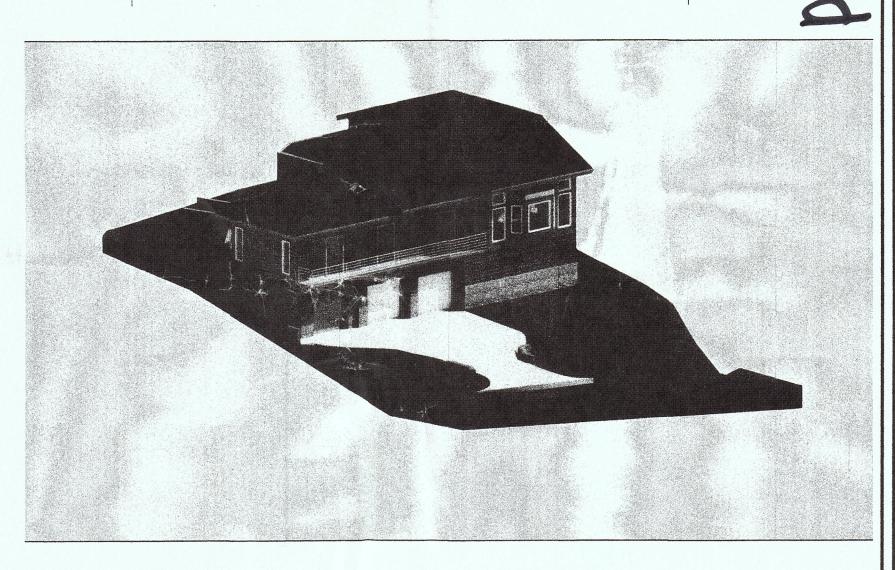


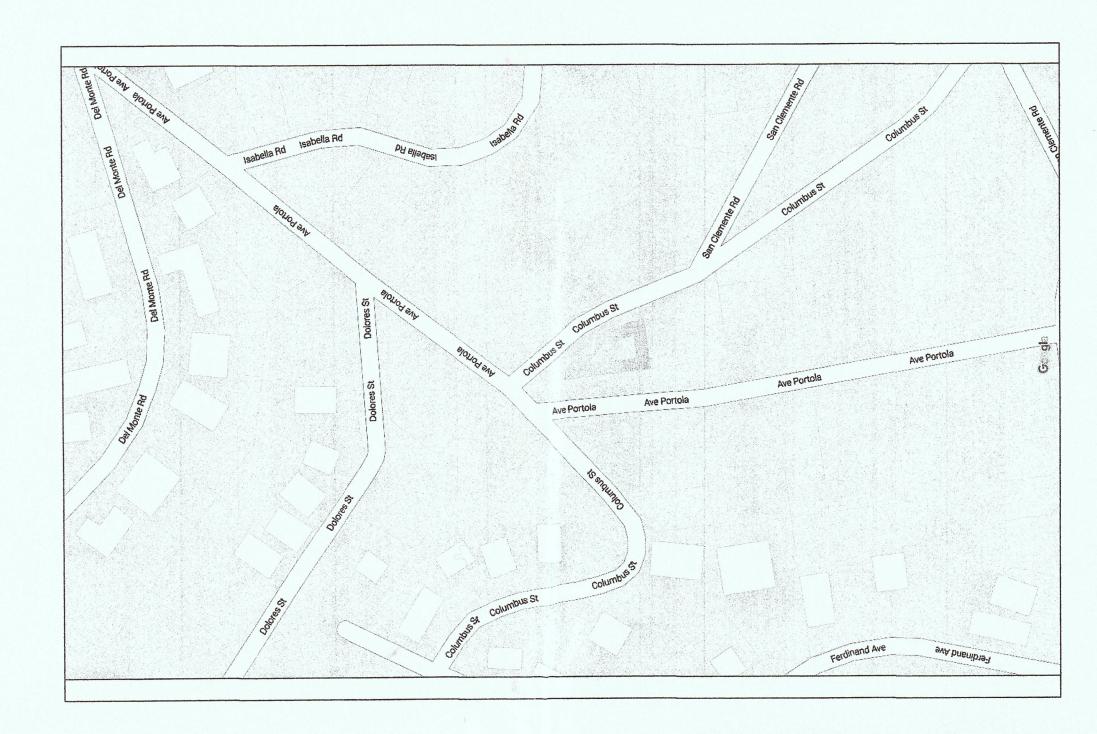
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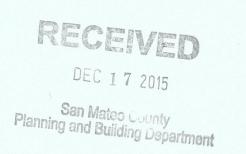



DRAWING INDEX

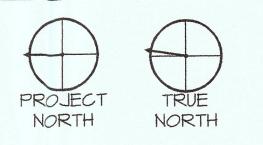SHEET	TITLE
CS	COVER SHEET
SU	SURVEY BY BGT SURVEYING
GP	GRADING PLAN
A2.1	FIRST FLOOR PLANS
A2.2	SECOND FLOOR PLANS
A2.3	THIRD FLOOR PLANS
A3.1	EAST & NORTH ELEVATIONS
A3.2	WEST & SOUTH ELEVATIONS
LP	LANDSCAPE PLAN
C-1	DRAINAGE PLAN






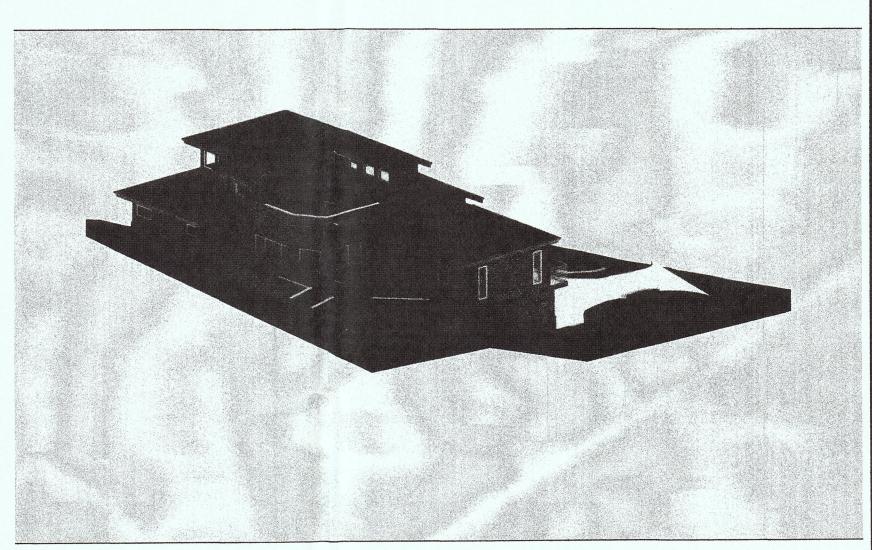

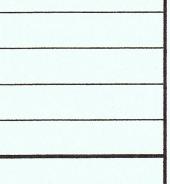

REVISIONS

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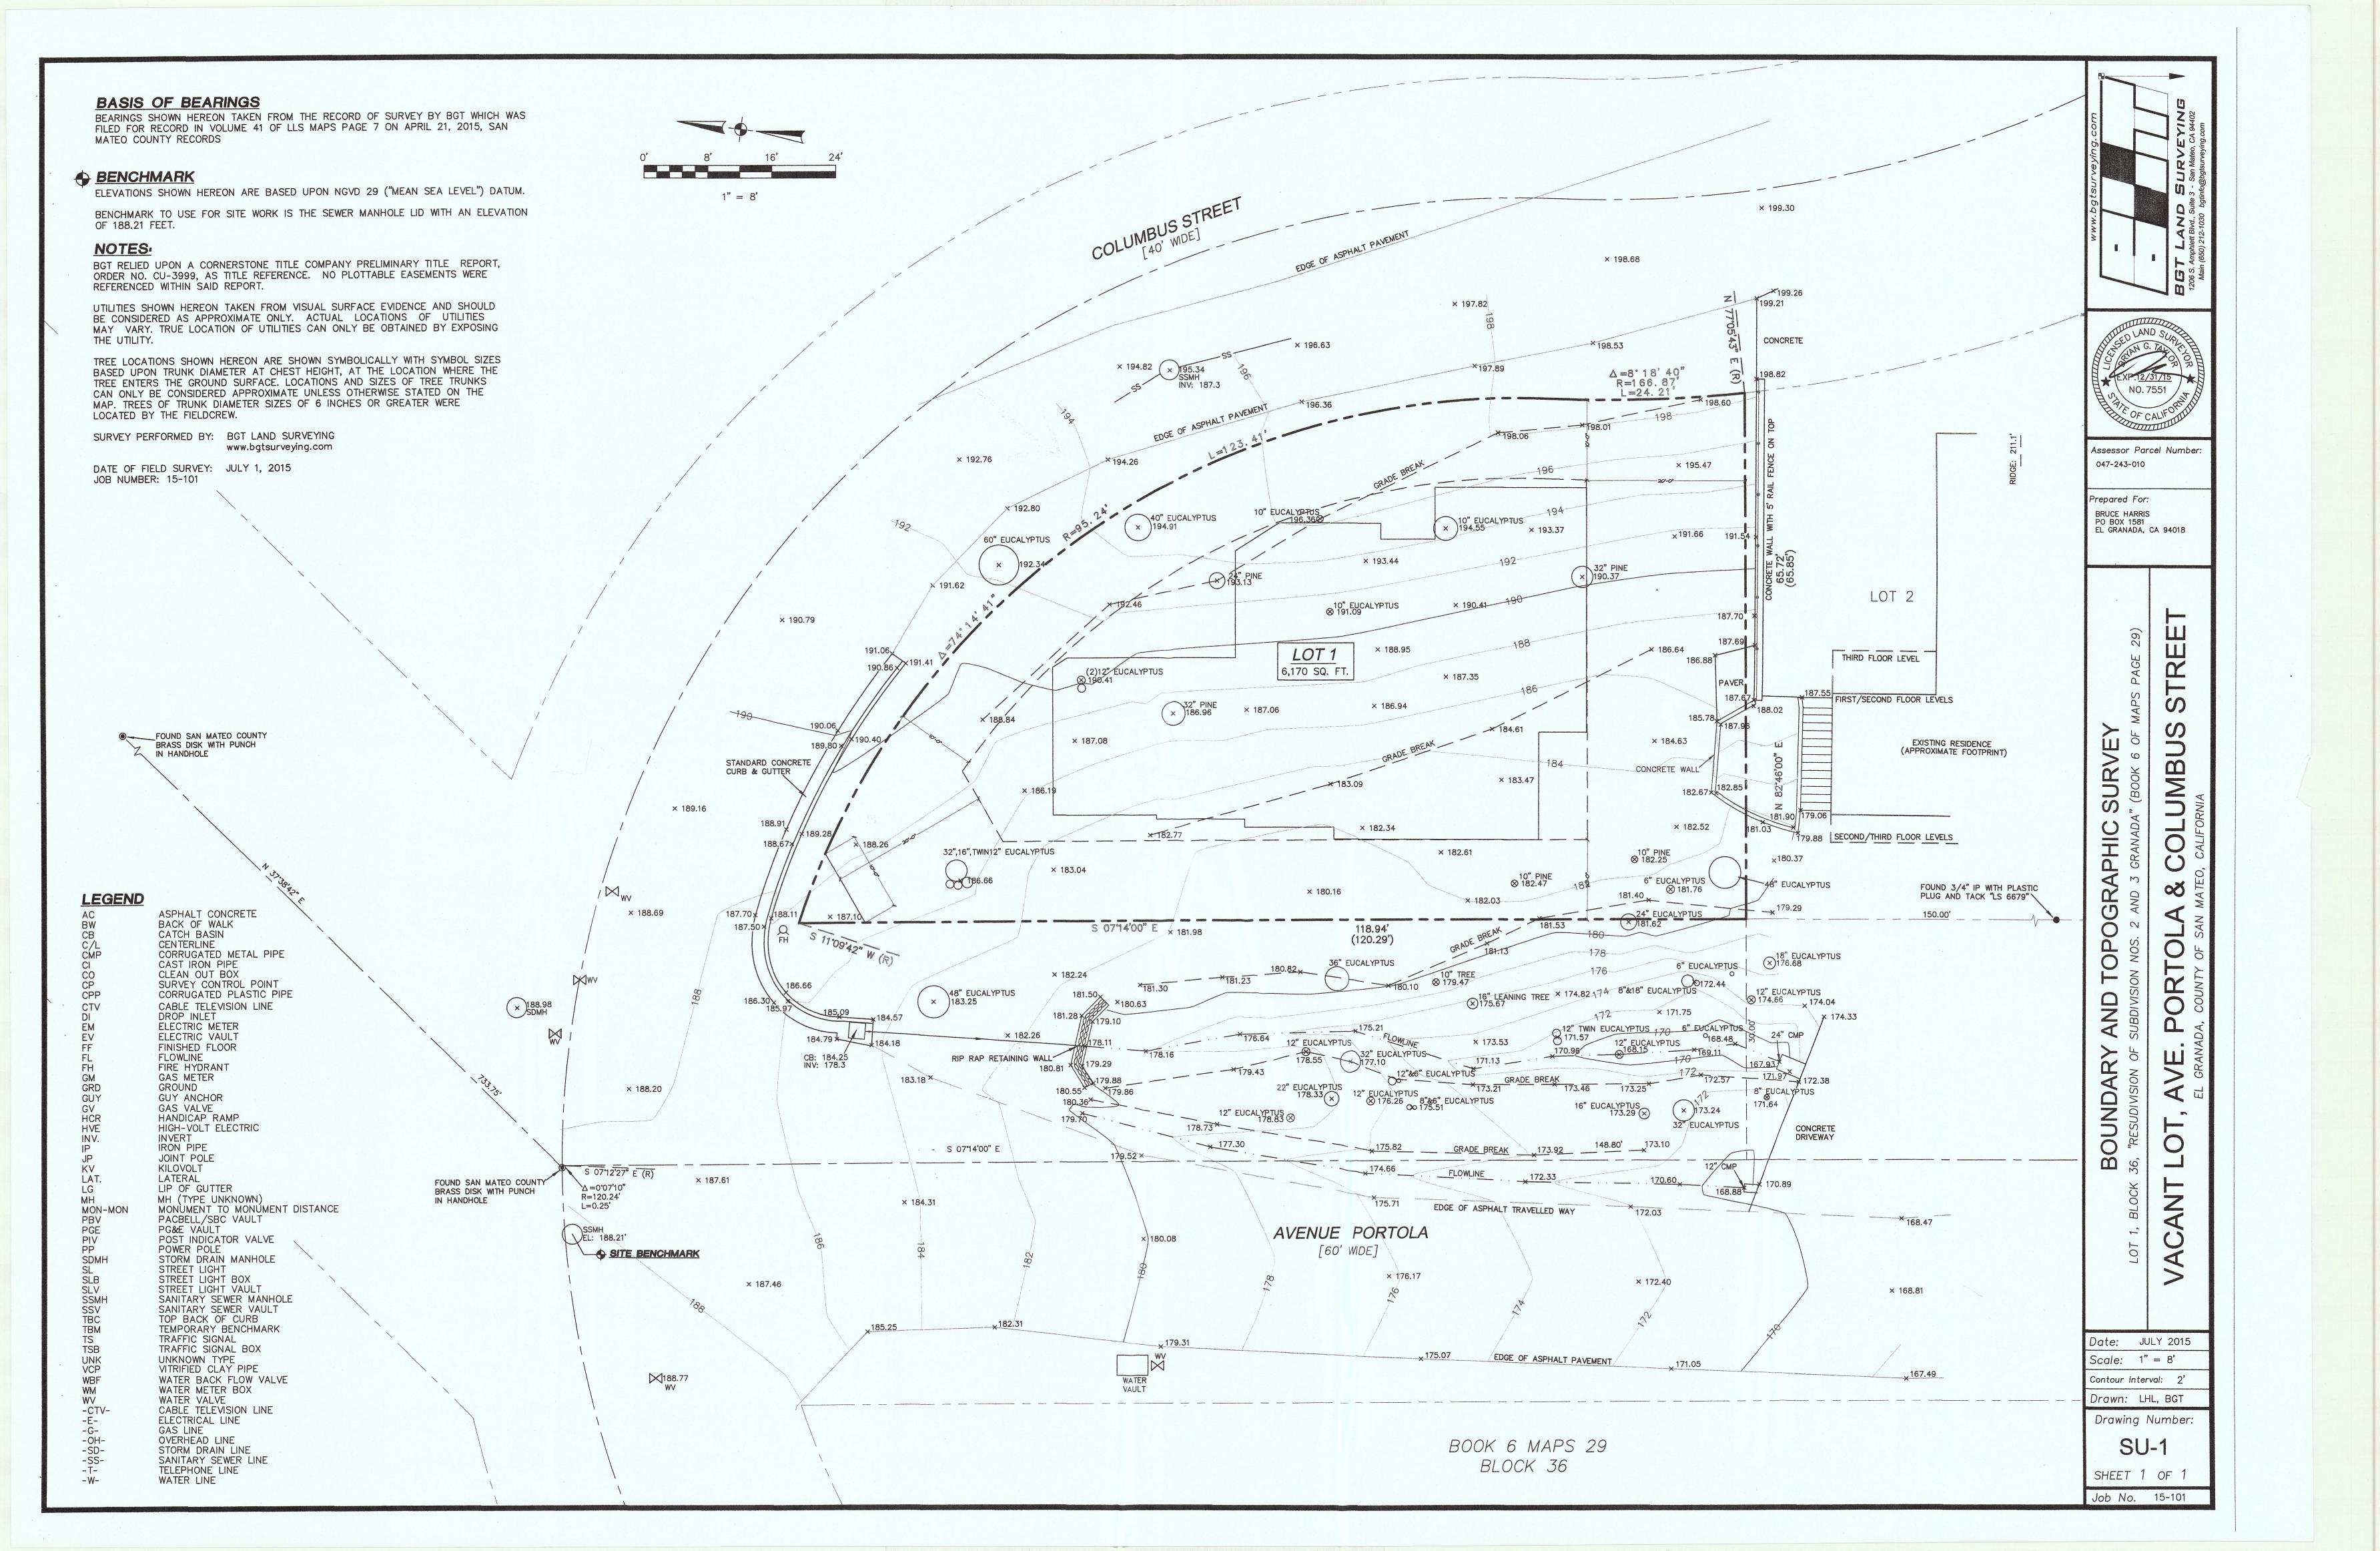
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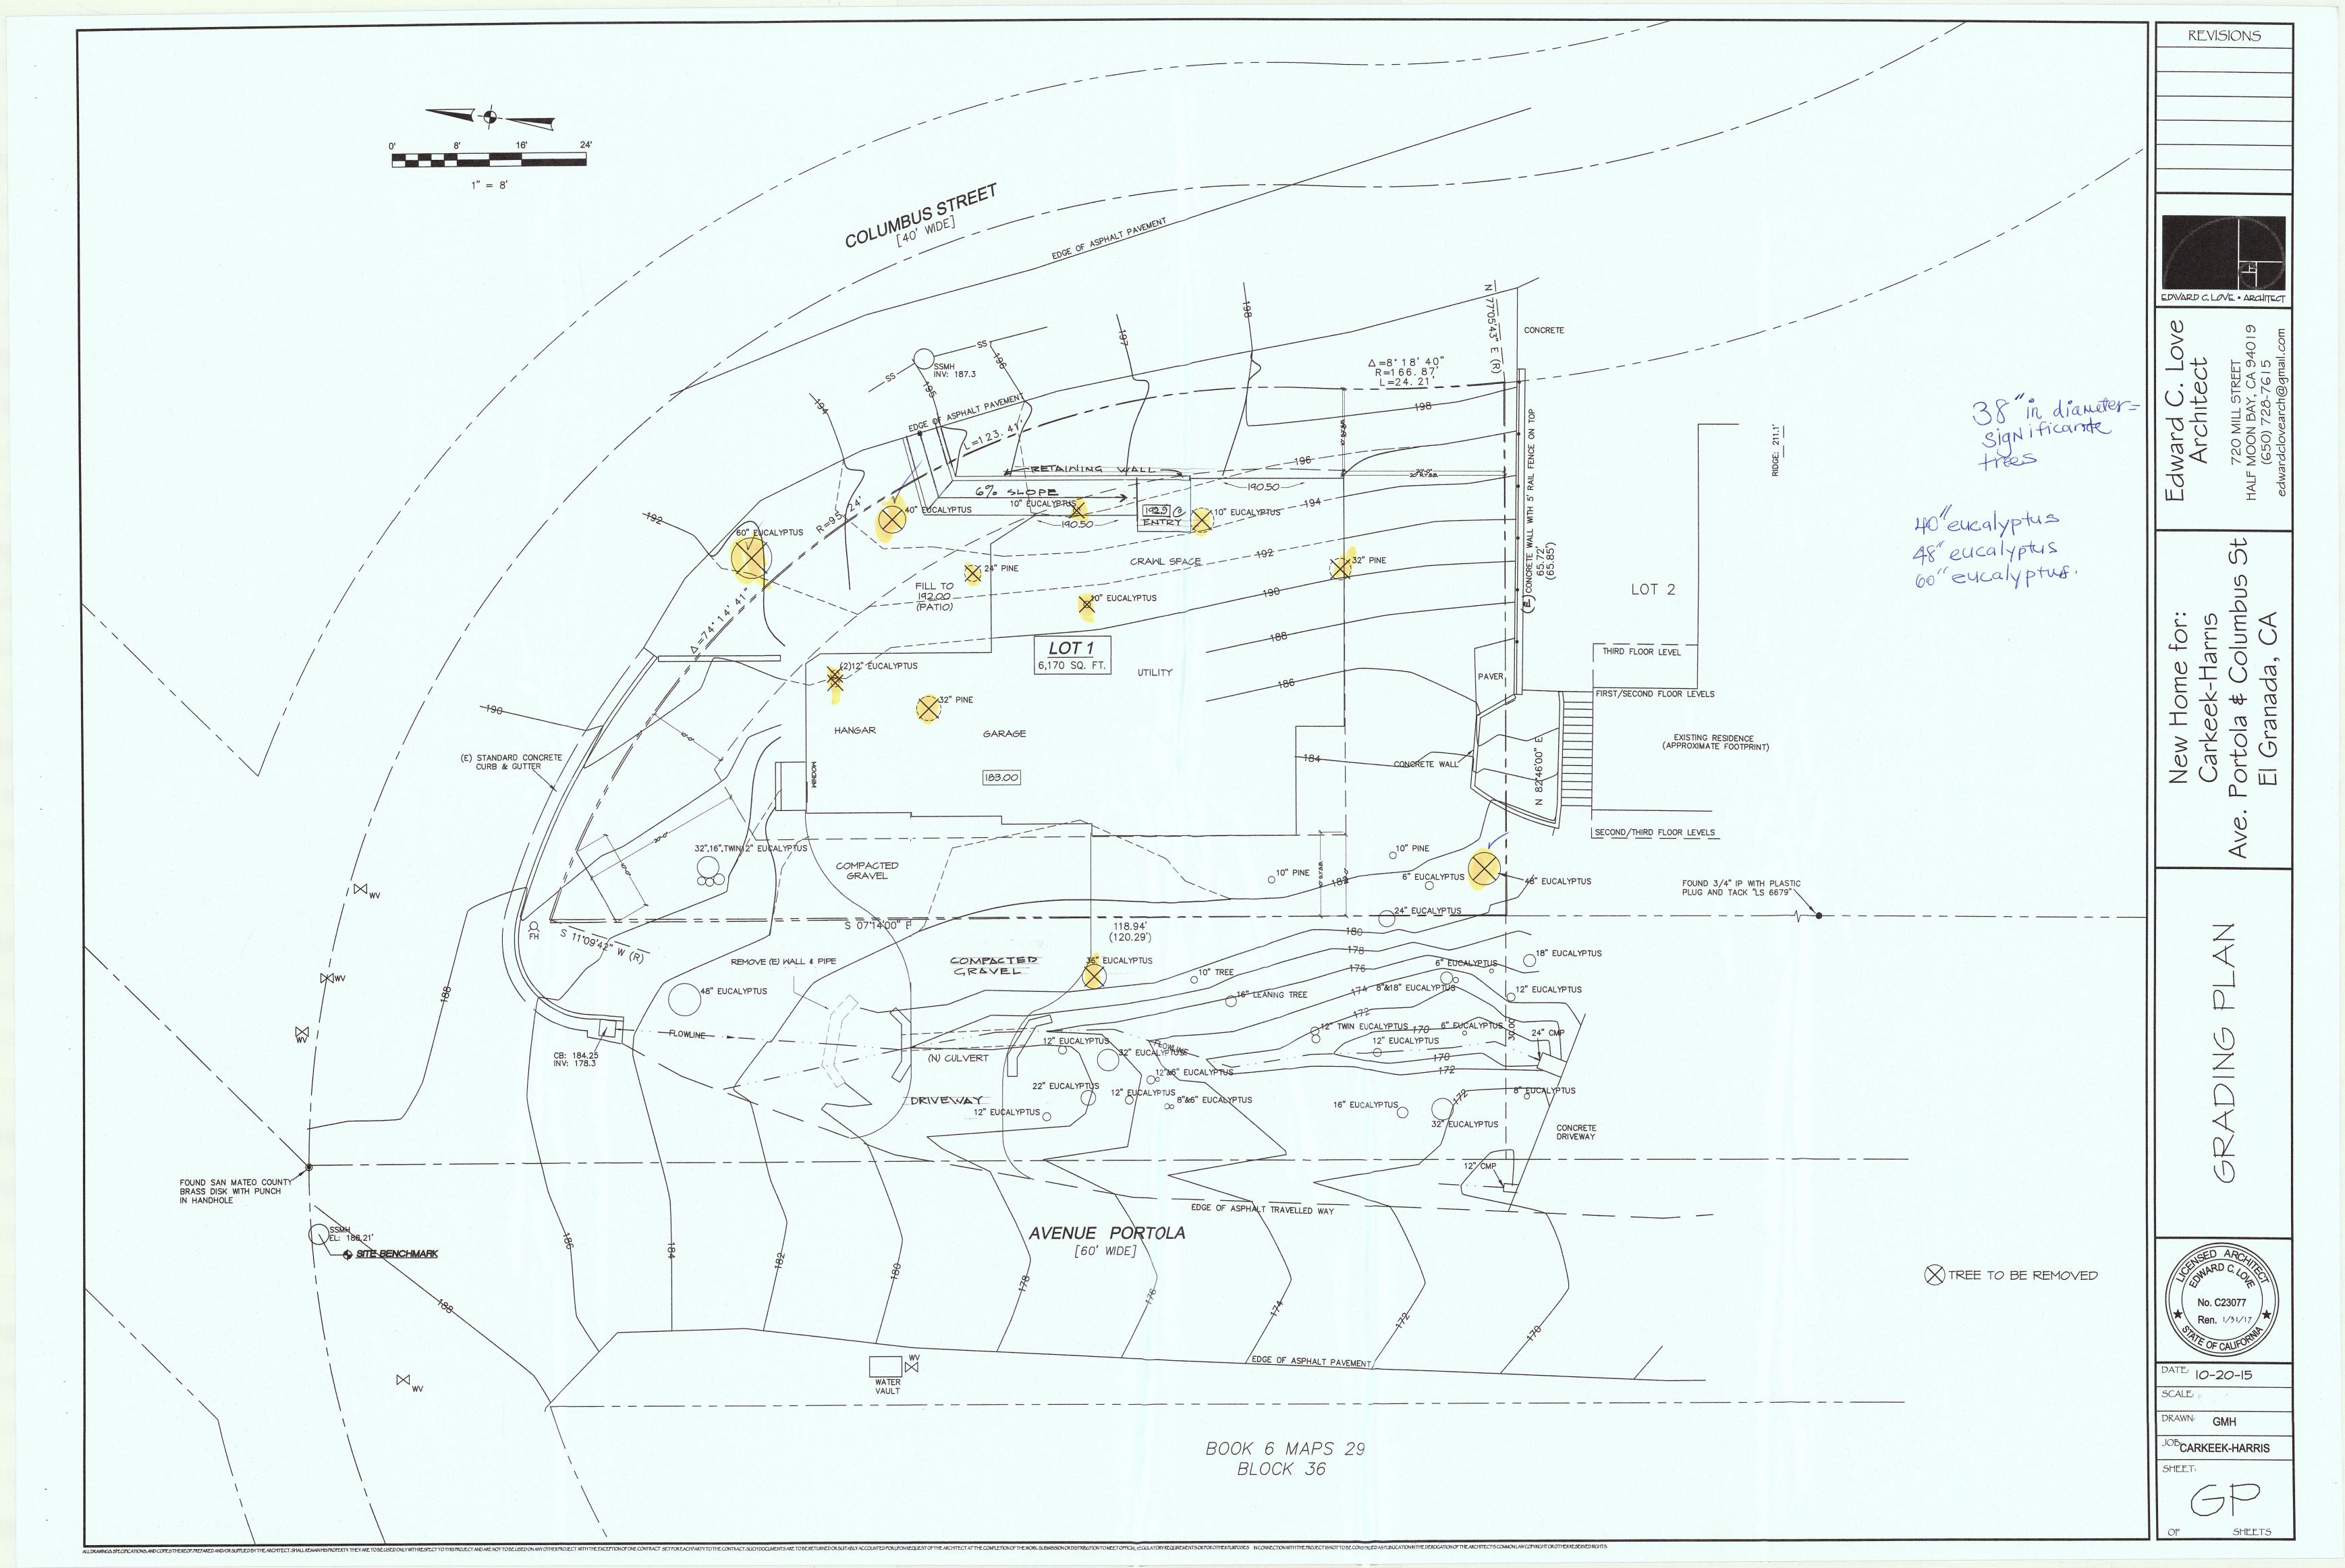


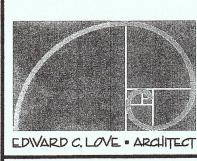
12-14-15

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JOB CARKEEK-HARRIS






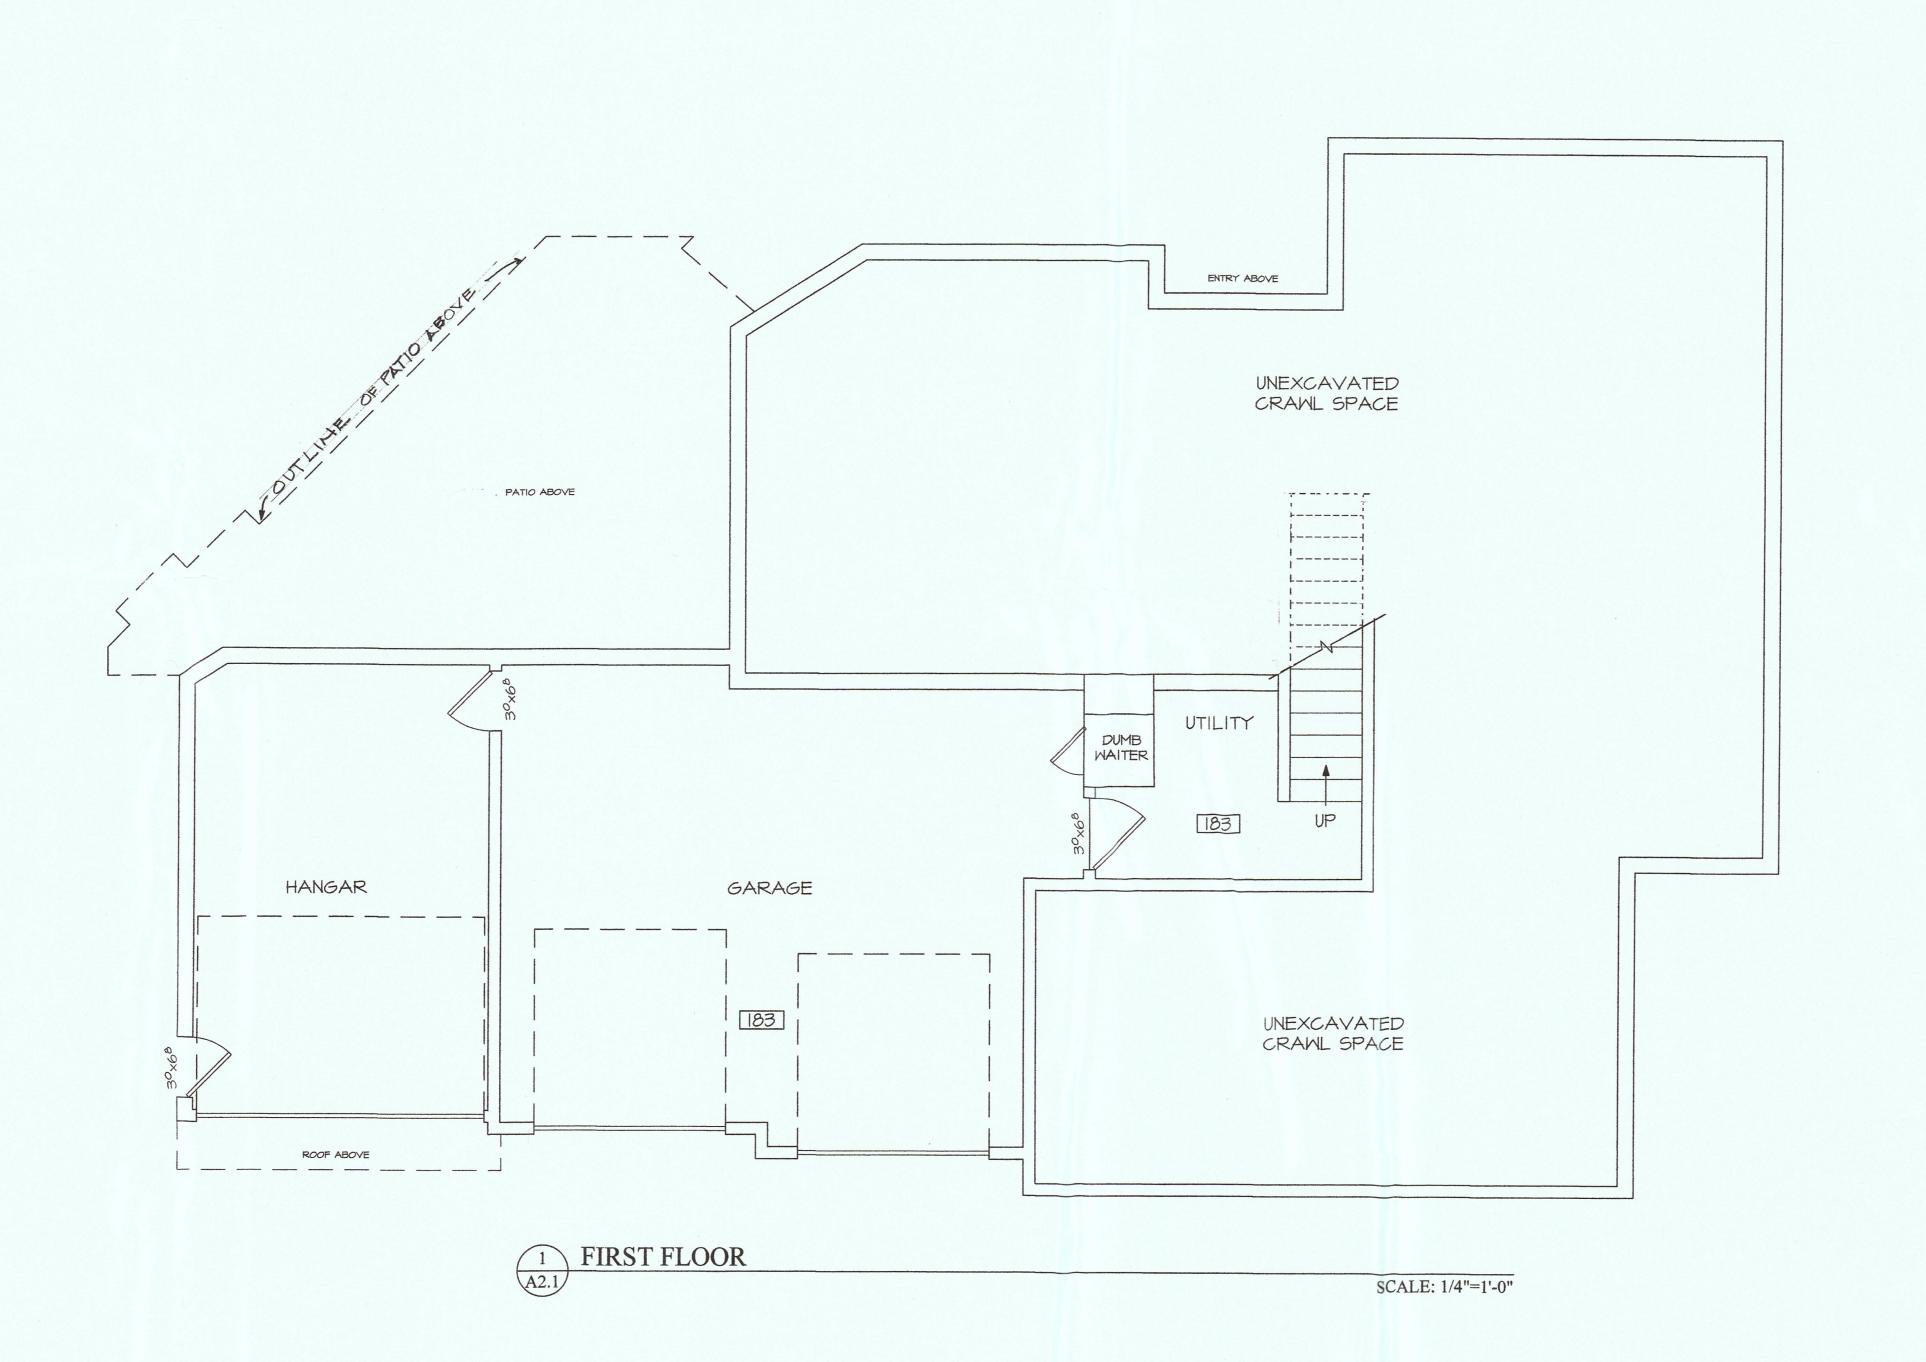

EDWARD C. LOVE · ARCHITECT

REVISIONS

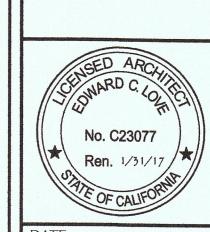

SCALE: 1/4" = 1'

DRAWN: GMH

JOB CARKEEK-HARRIS

SHEET:


SHEETS

SCALE: 1/4"=1'-0"

EDWARD C. LOVE · ARCHITECT Edward C. Love Architect

REVISIONS


New Home for: Carkeek-Harris Portola & Columbus 9 El Granada, CA

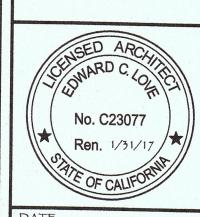

DATE: 12-14-15 SCALE 1/4" = 1"

DRAWN: GMH

JOB CARKEEK-HARRIS

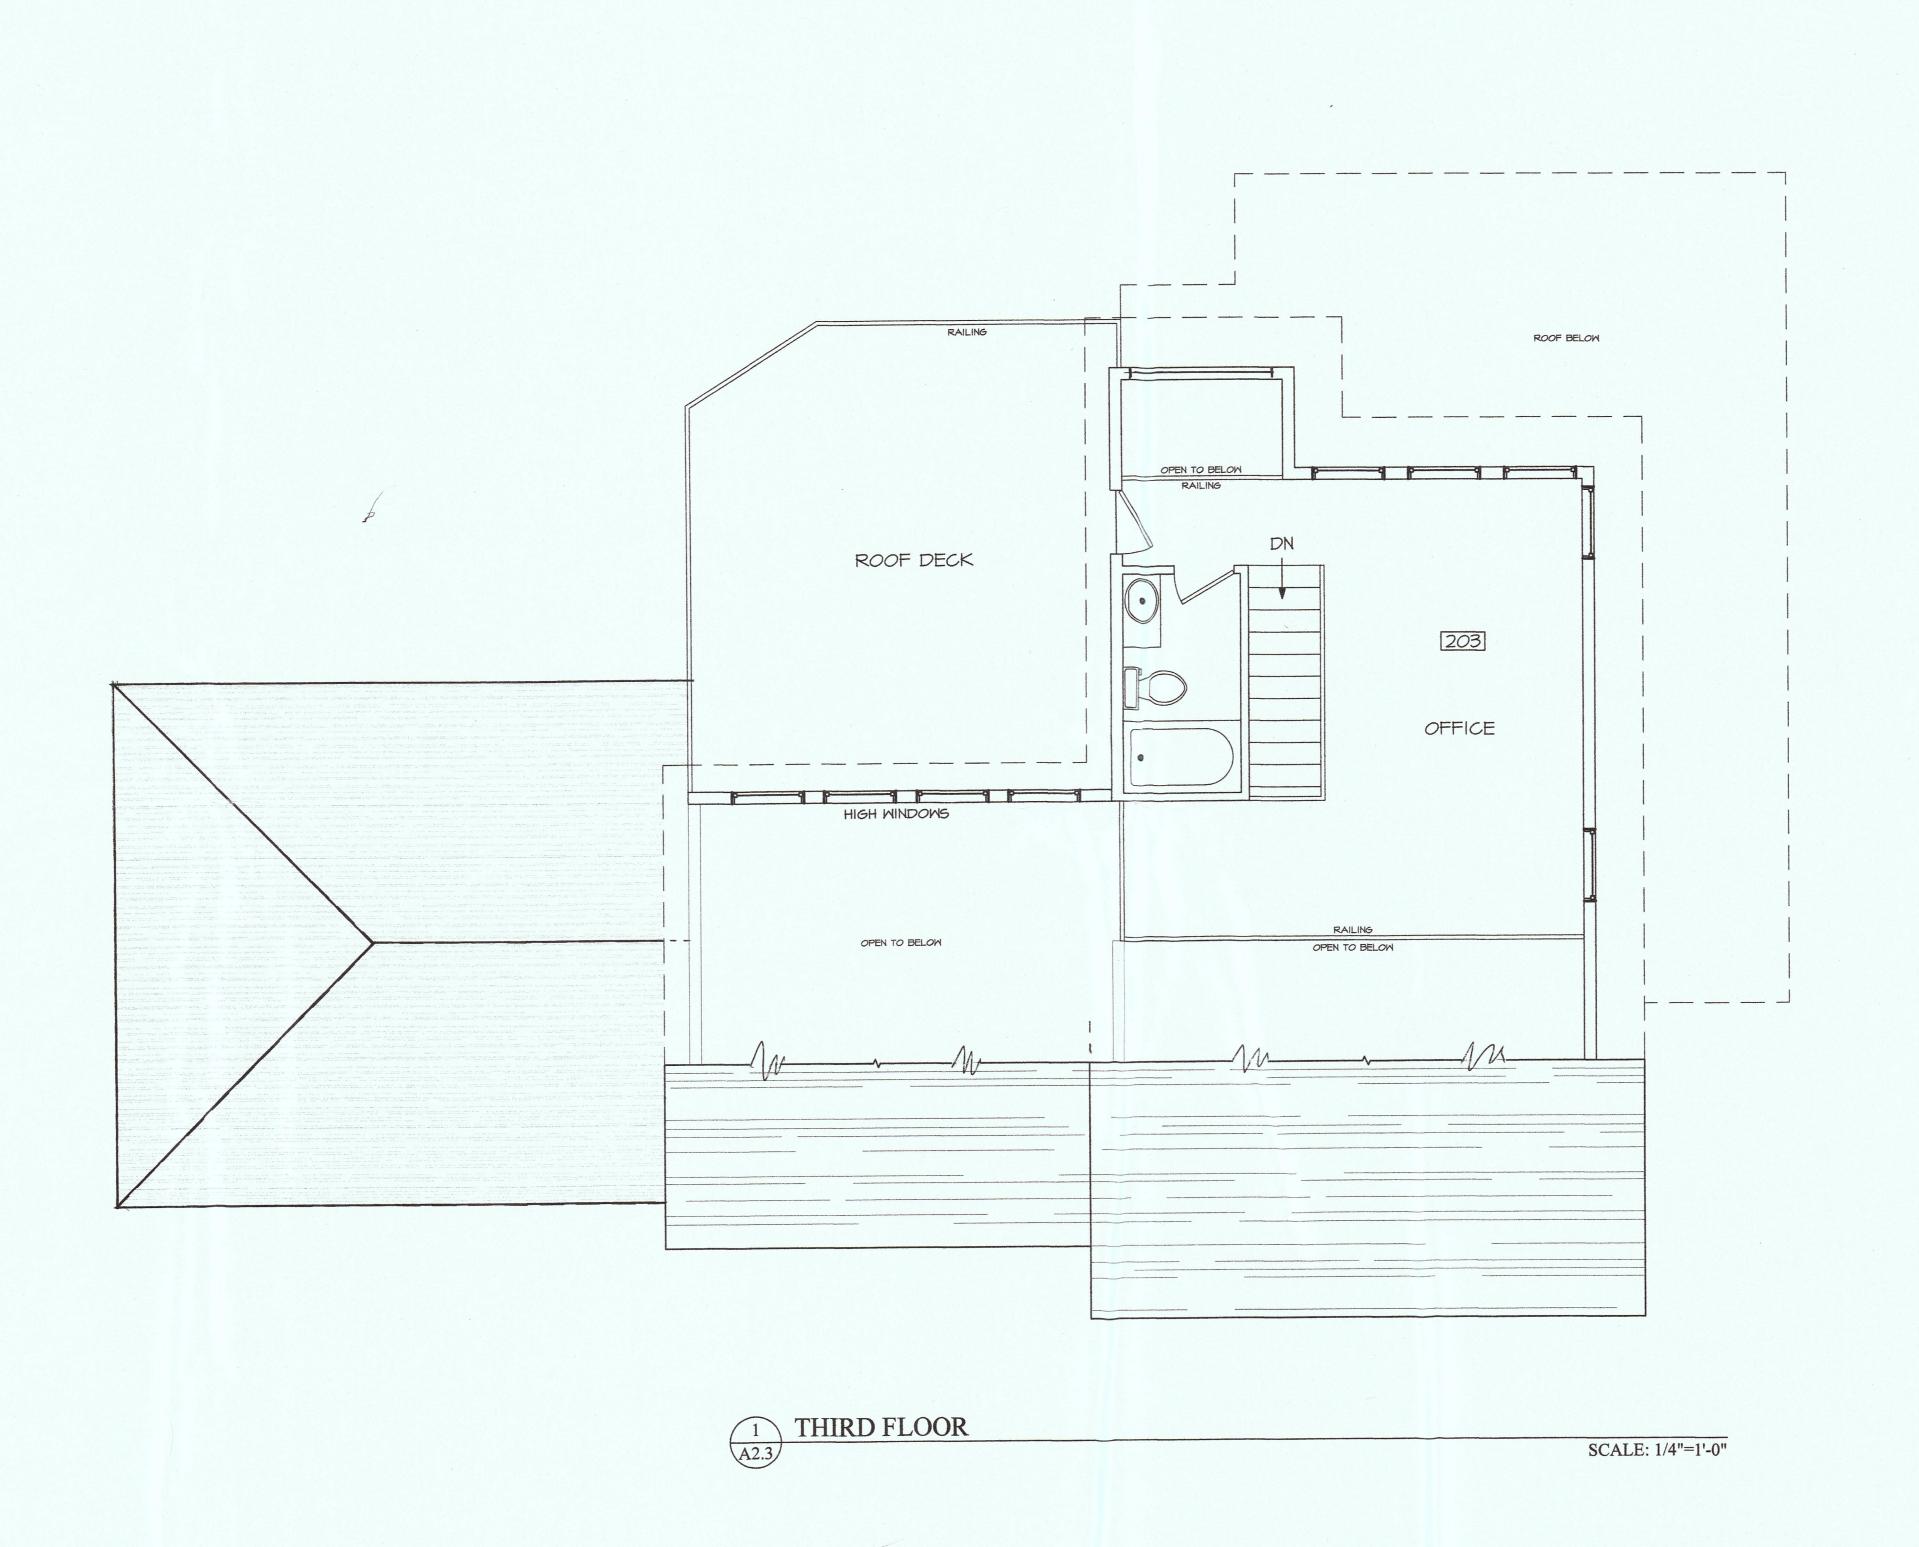

ALI DRAWWAYS. SPYCIFICATIONS. AND COPIES THEREOF, FREPARED AND/OR SUPPLIED BY THE ARCHITECT, SHALL REMAIN HIS PROJECT, WITH THE EXCEPTION OF ONE CONTRACT. SELF POR EACH PARTY TO THE CONTRACT SELF POR EACH PARTY TO THE C

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REVISIONS


EDWARD C. LOVE · ARCHITECT

Ave

DATE: 12-14-15

DRAWN: GMH

JOB CARKEEK-HARRIS

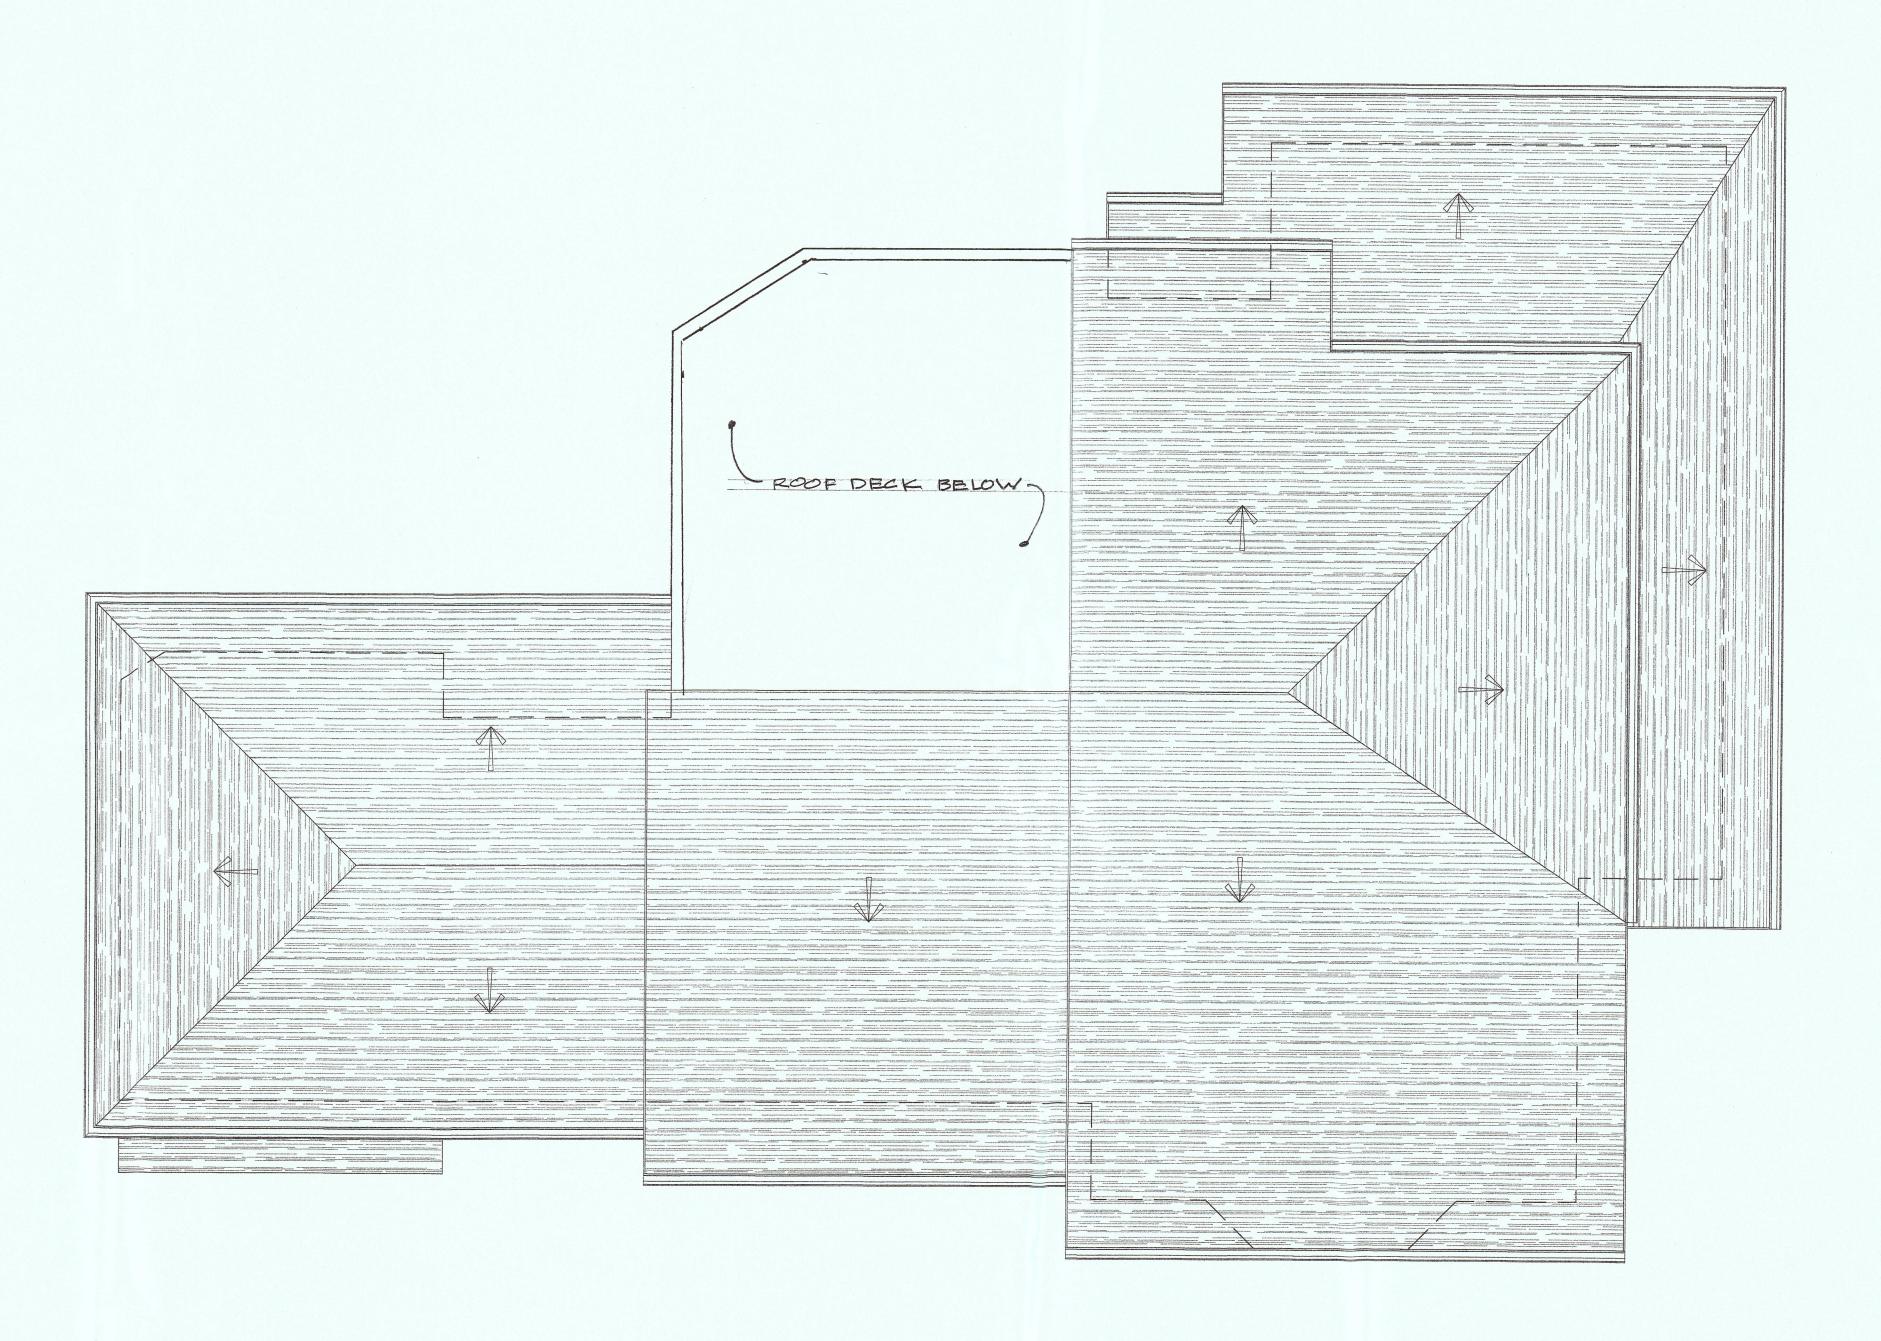

ALL DRAWINGS. SPECIFICATIONS, AND COPIES THEREOP, PREPARED AND/OR SUPPLIED BY THE ARCHITECT. SHALL REMAIN HIS PROPERTY. THEY ARE TO BE USED ON LYWITH RESPECT TO THIS PROJECT AND ARE NOT TO BE USED ON LAW COPYRIGHT OR OTHER PROJECT. WITH THE EXCEPTION OF ONE CONTRACT. SECTION WITH THE PROJECT IS NOT TO BE CONSTRUED AS PUBLICATION IN THE DEROGATION OF THE ARCHITECTS. SOMMON LAW COPYRIGHT OR OTHER RESERVED RIGHTS.

SCALE: 1/4"=1'-0"

New Home for: Carkeek-Harris Ave. Portola & Columbus 9 El Granada, CA

REVISIONS

EDWARD C. LOVE · ARCHITECT

Edward C. Love Architect

ROOF PLAN

No. C23077
Ren. 1/31/17

Ren. 1/31/17

DATE: 12-14-15

SCALE: 1/4" = 1'

DRAWN: **GMH**

JOB CARKEEK-HARRIS


A2.4

SHEETS



LEFT ELEVATION (EAST) COLUMBUS ST

SCALE: 1/4"=1'-0"

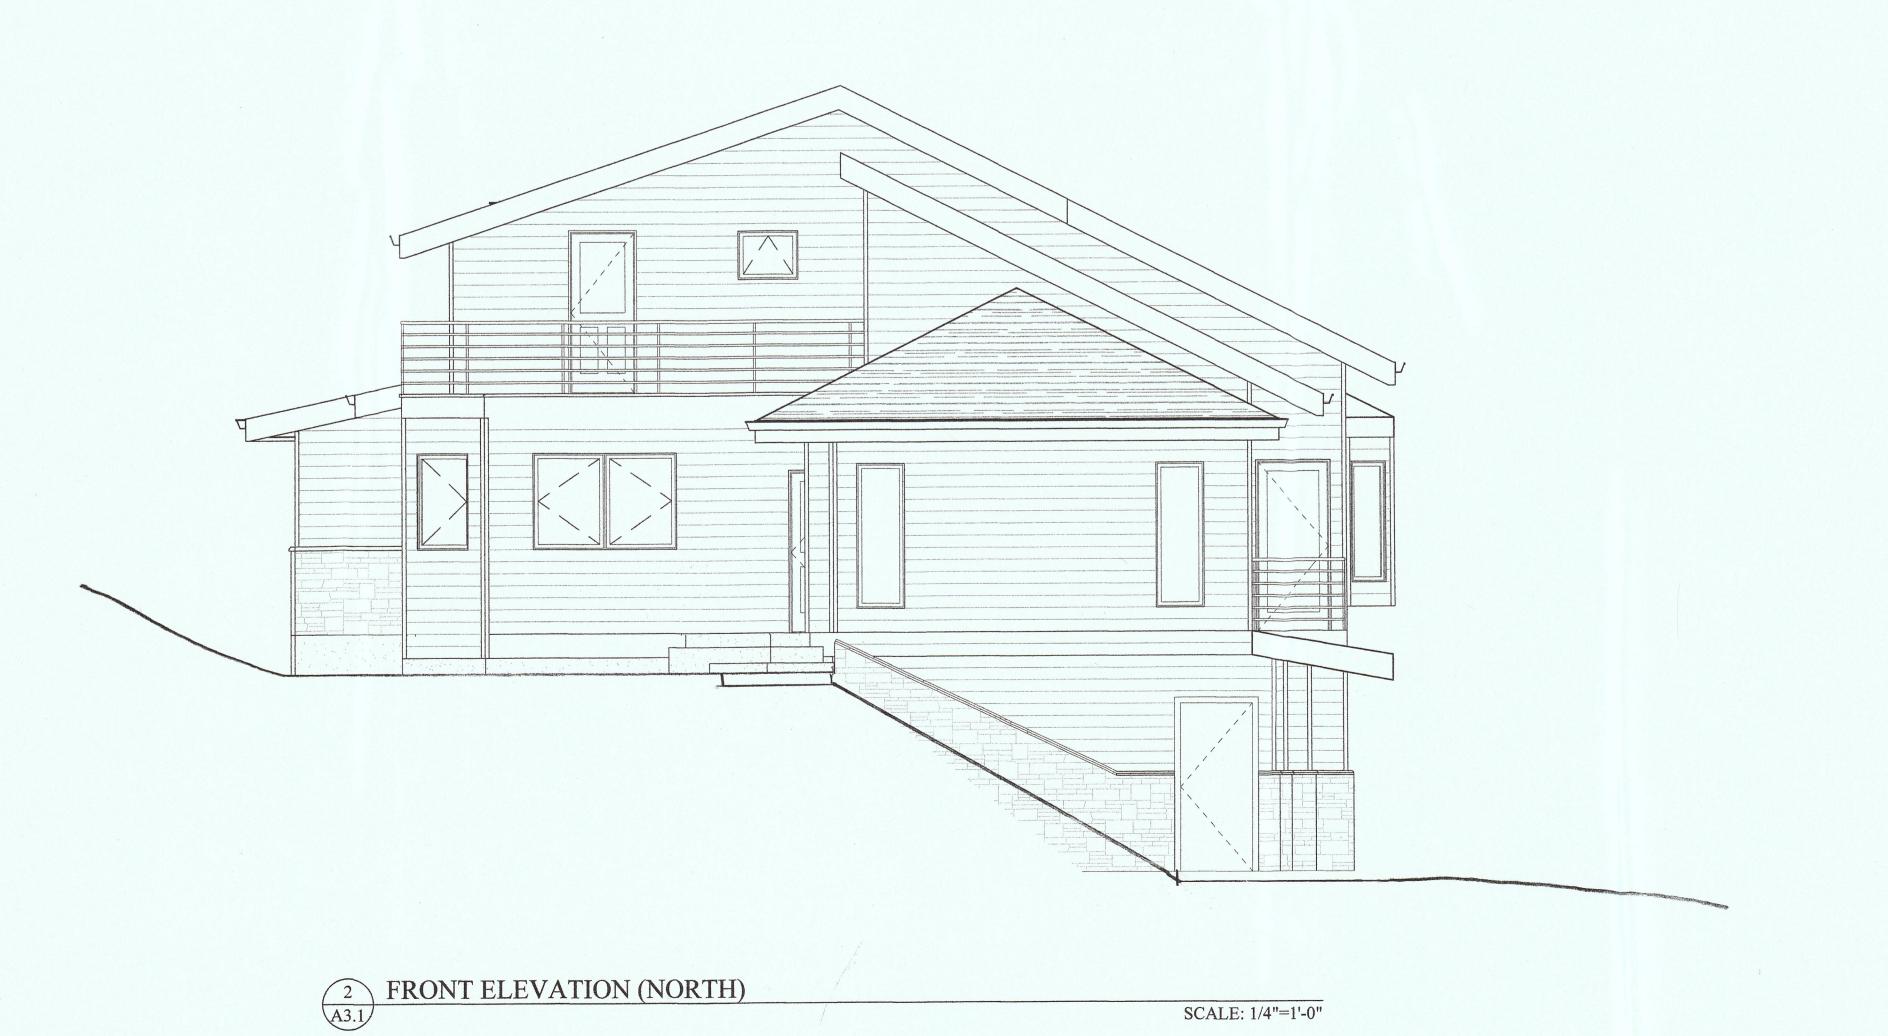


New Home for: Carkeek-Harris Portola & Columbus 9 El Granada, CA

REVISIONS

EDWARD C. LOVE - ARCHITECT

Edward C. Lov Architect

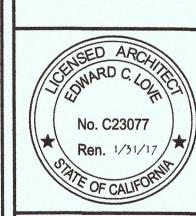


DATE: 12-14-15

DRAWN: GMH

JOB CARKEEK-HARRIS

SCALE: 1/4"=1'-0"

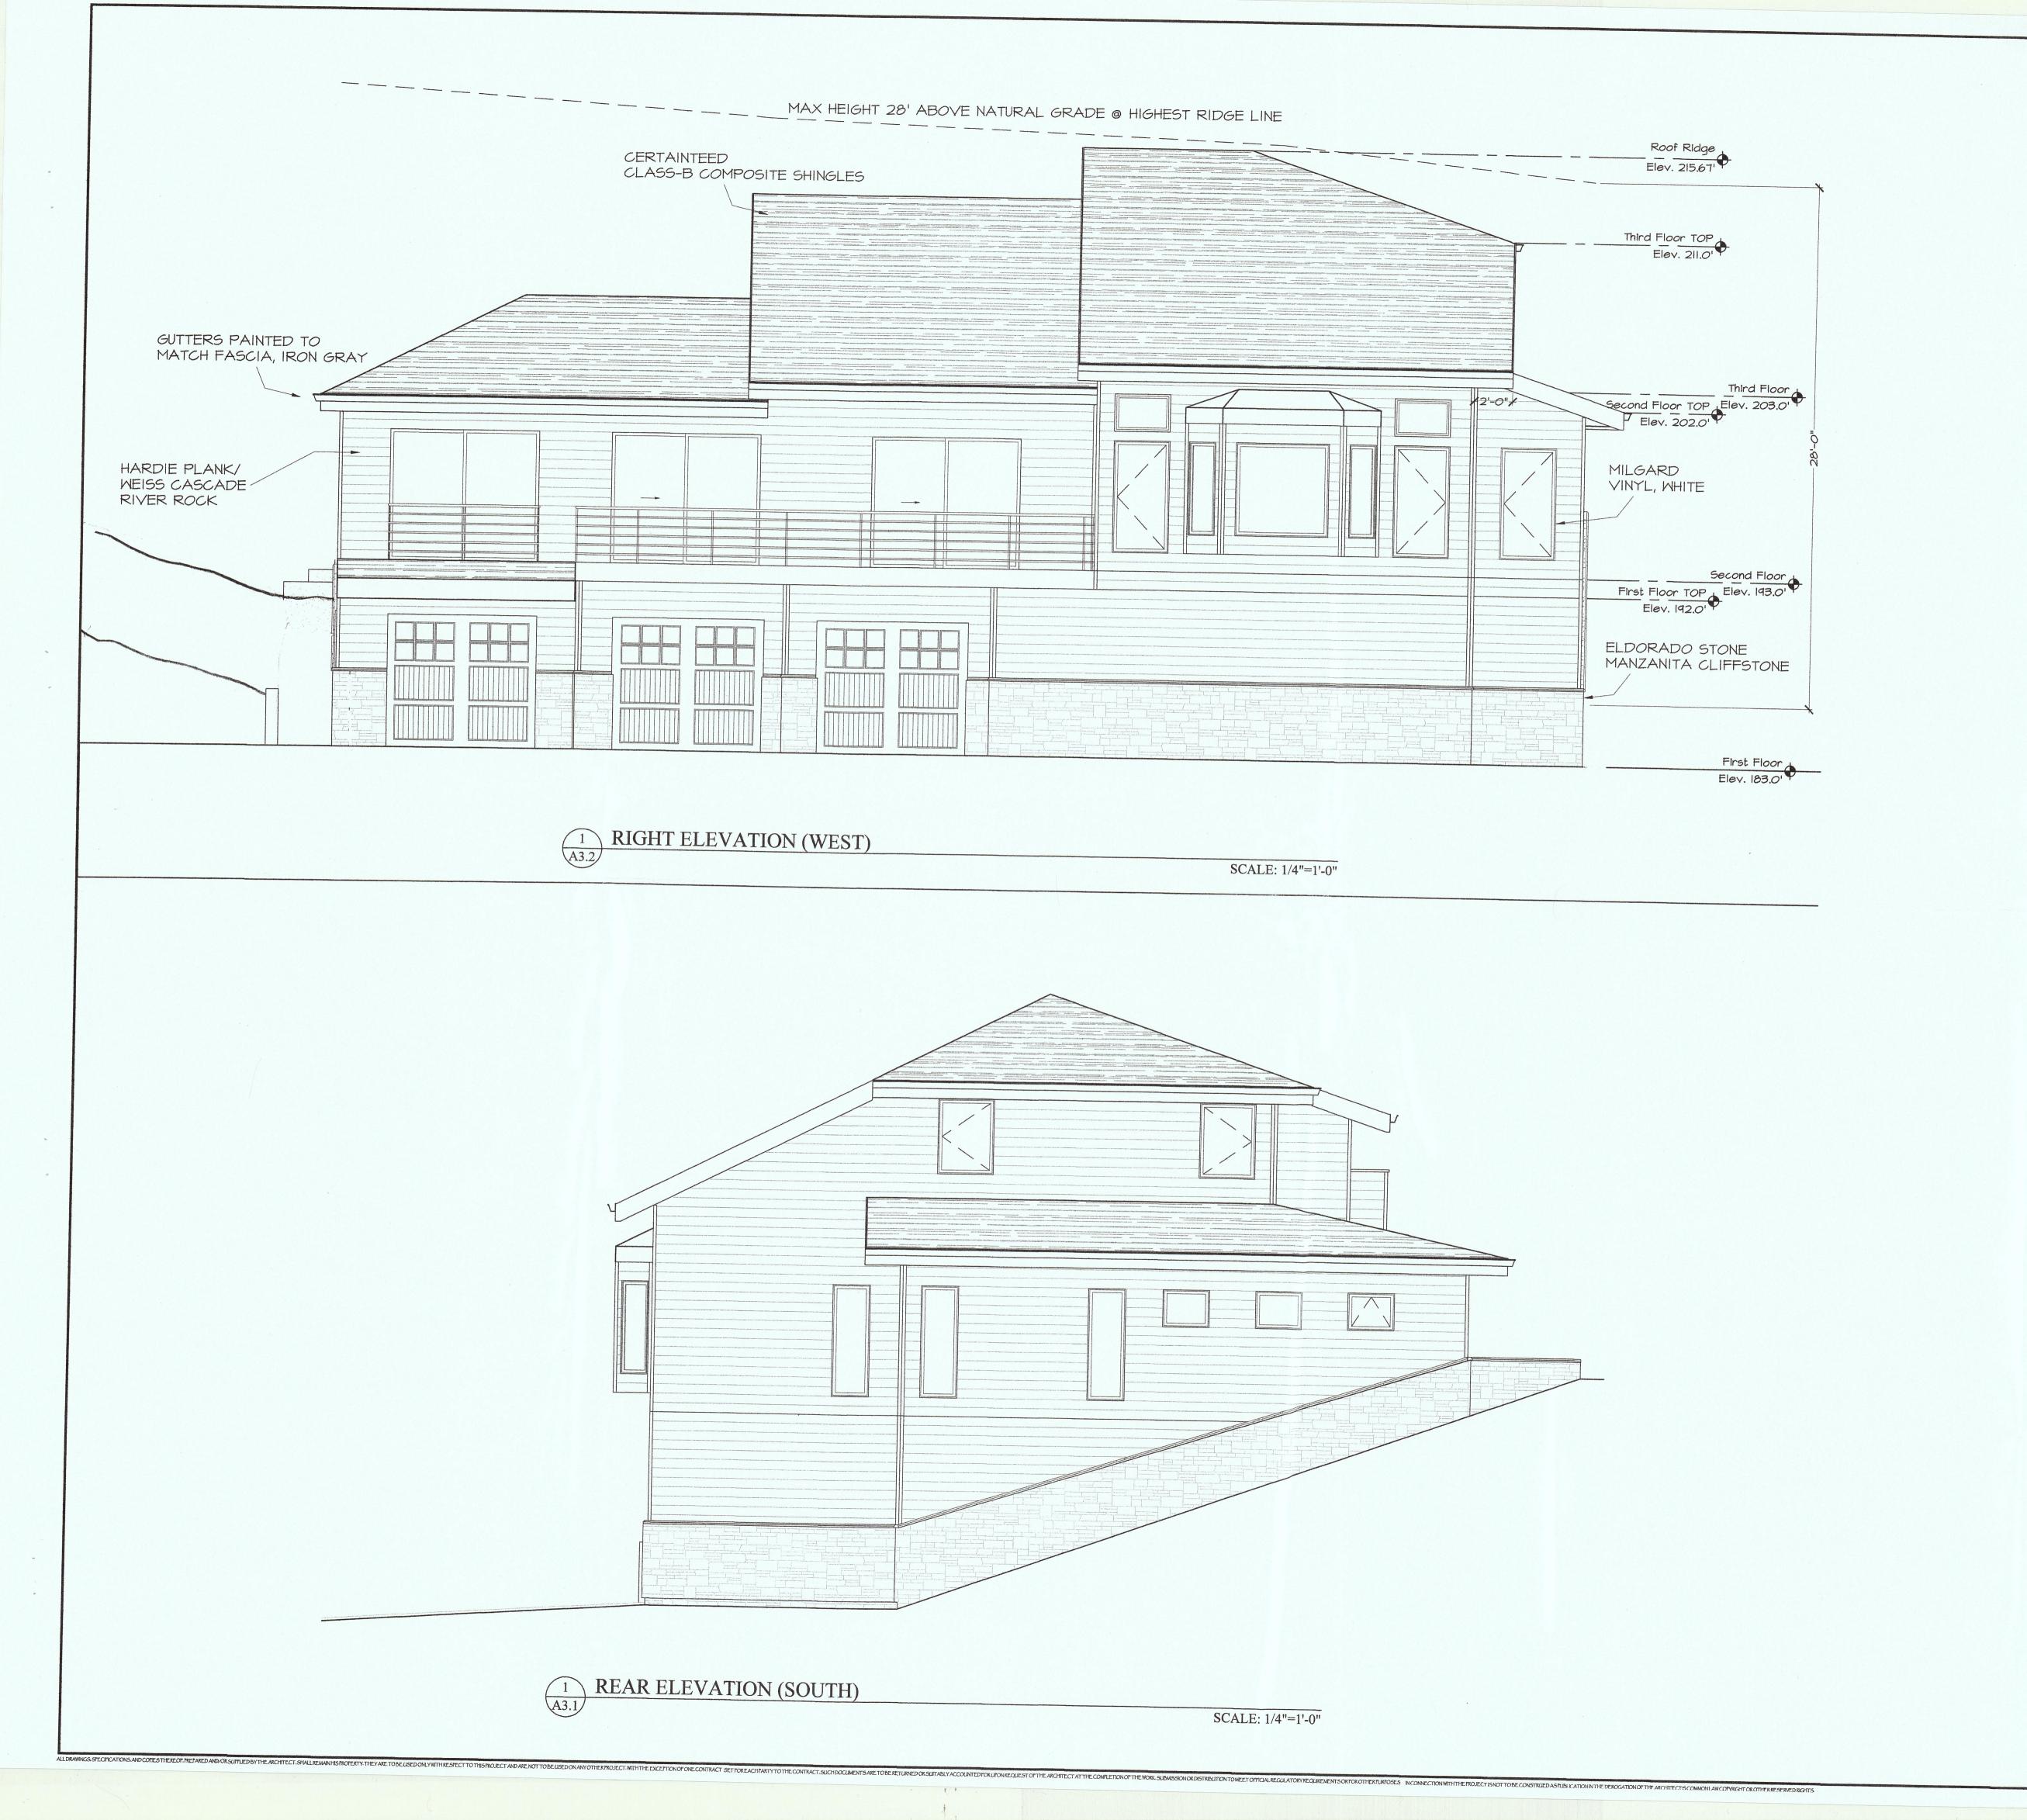

REVISIONS

EDWARD C. LOVE - ARCHITECT

DATE: 12-14-15

SCALE: 1/4" = 1'

JOB CARKEEK-HARRIS

LANDSCAPE PLAN CARKEEK-HARRISIS MONTARA, CA MORTH Sale 31" = 8'-0" DATE: 11/14/15 CARPENTERIA CALIFORNICA BUSH ANEMONE GREVILLES CANZERRA 1-54 MYRICA CALIFORNICA
PACIFIC WAY MYRTCE 5-59HL HOKED SUNEDLENS SWEET HAKSA 1-50AL 3-500 ROCK WALL PLUMBAGO CAPENSIS CAPE PLUMBAGO Q-SOPE WESTRINGIA ROSMANINIFOLIUS WESTRINGIA -AGONIS FLERUOSA
PEPPERMINT WILLOW 3-500 CORDIFOLIA EUPUTUPU Rizary VIBURNIFOLIUM 1-150xl EVERGREEN CURRENT 5-1941 8 - lage HAKED SUAVEOLEMS SWEET HAKEA O TREE REMOULD 1-5gel ON CONCRETE TO BERGLICED | FOIL! MYRICA CALFORNICA
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1-3-1 WITH 15 gel TREES 3- SIGNIFICANT TREES PENDOUED Agovis Flexuosa HOUSE PERPERMINT WILLOW HAKEA SUAVEOLENS SWEET HAKEA 1-15gg (1-546 HANGAIR GATZAGE HAKEA SUAVEOLENS NEPHROLEPIS CORDIFOLIA KUPU KUPU 3- lagget SWEET HAKEA 2-586 * TO BE PRUNED PLUMBAGO CAPENSS CAPE PLUMBAGO 2-5001 PEPPERWINT WILLOW PLANT TOTACS GRAUEL DRIVEWAY -* TO BE PRUNED MYRICA CALIFORNICA PACIFIC WAX MYRTLE 1- SOAL 3-15pl TRES' 26-5gH SHRUBS * TO BE PRONED-19 - 1 ops ((E) DRAINAGE * TO BE PRUNEY) EN EUC. EN EUC Ex. Euc. * TO BE HAND WATER ED Phone Bago capensis Cape Plumbago RIBES VIBURNIFOLIUM 3- 5gel EVERGREEN CURRENT 3-1946 AVENUE PORTOLA FLORA FARM 340 PURISSIMA ST. HALF MODN BAY, CL. MULCH - ALL GARDEN ARSAS TO BE MULCHED DRAWN BY & JERRY WHITING LIC. #549103 SPRINKLER! DRIP HUNTER X C 400 I 4 W/RAIN SENSOR RAINBIRD DASASUF 075 VALUE RAINBIRD RBY 075 MPTX - 3 FILTER/REGULATOR 12" PEPCO INBING Yy" PEPCO LATERAL SW 10-10PK BMITTERS


EDWARD C. LOVE = ARCHITECT

REVISIONS

Award C. Love
Architect
720 MILL STREET

New Home for: Carkeek-Harris

> LANDSCAPE PIAN

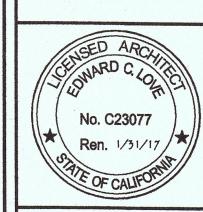


DATE: 12-14-15


SCALE: 1/4" = 1'

DRAWN: **GMH**

JOB CARKEEK-HARRIS
SHEET

SHEETS

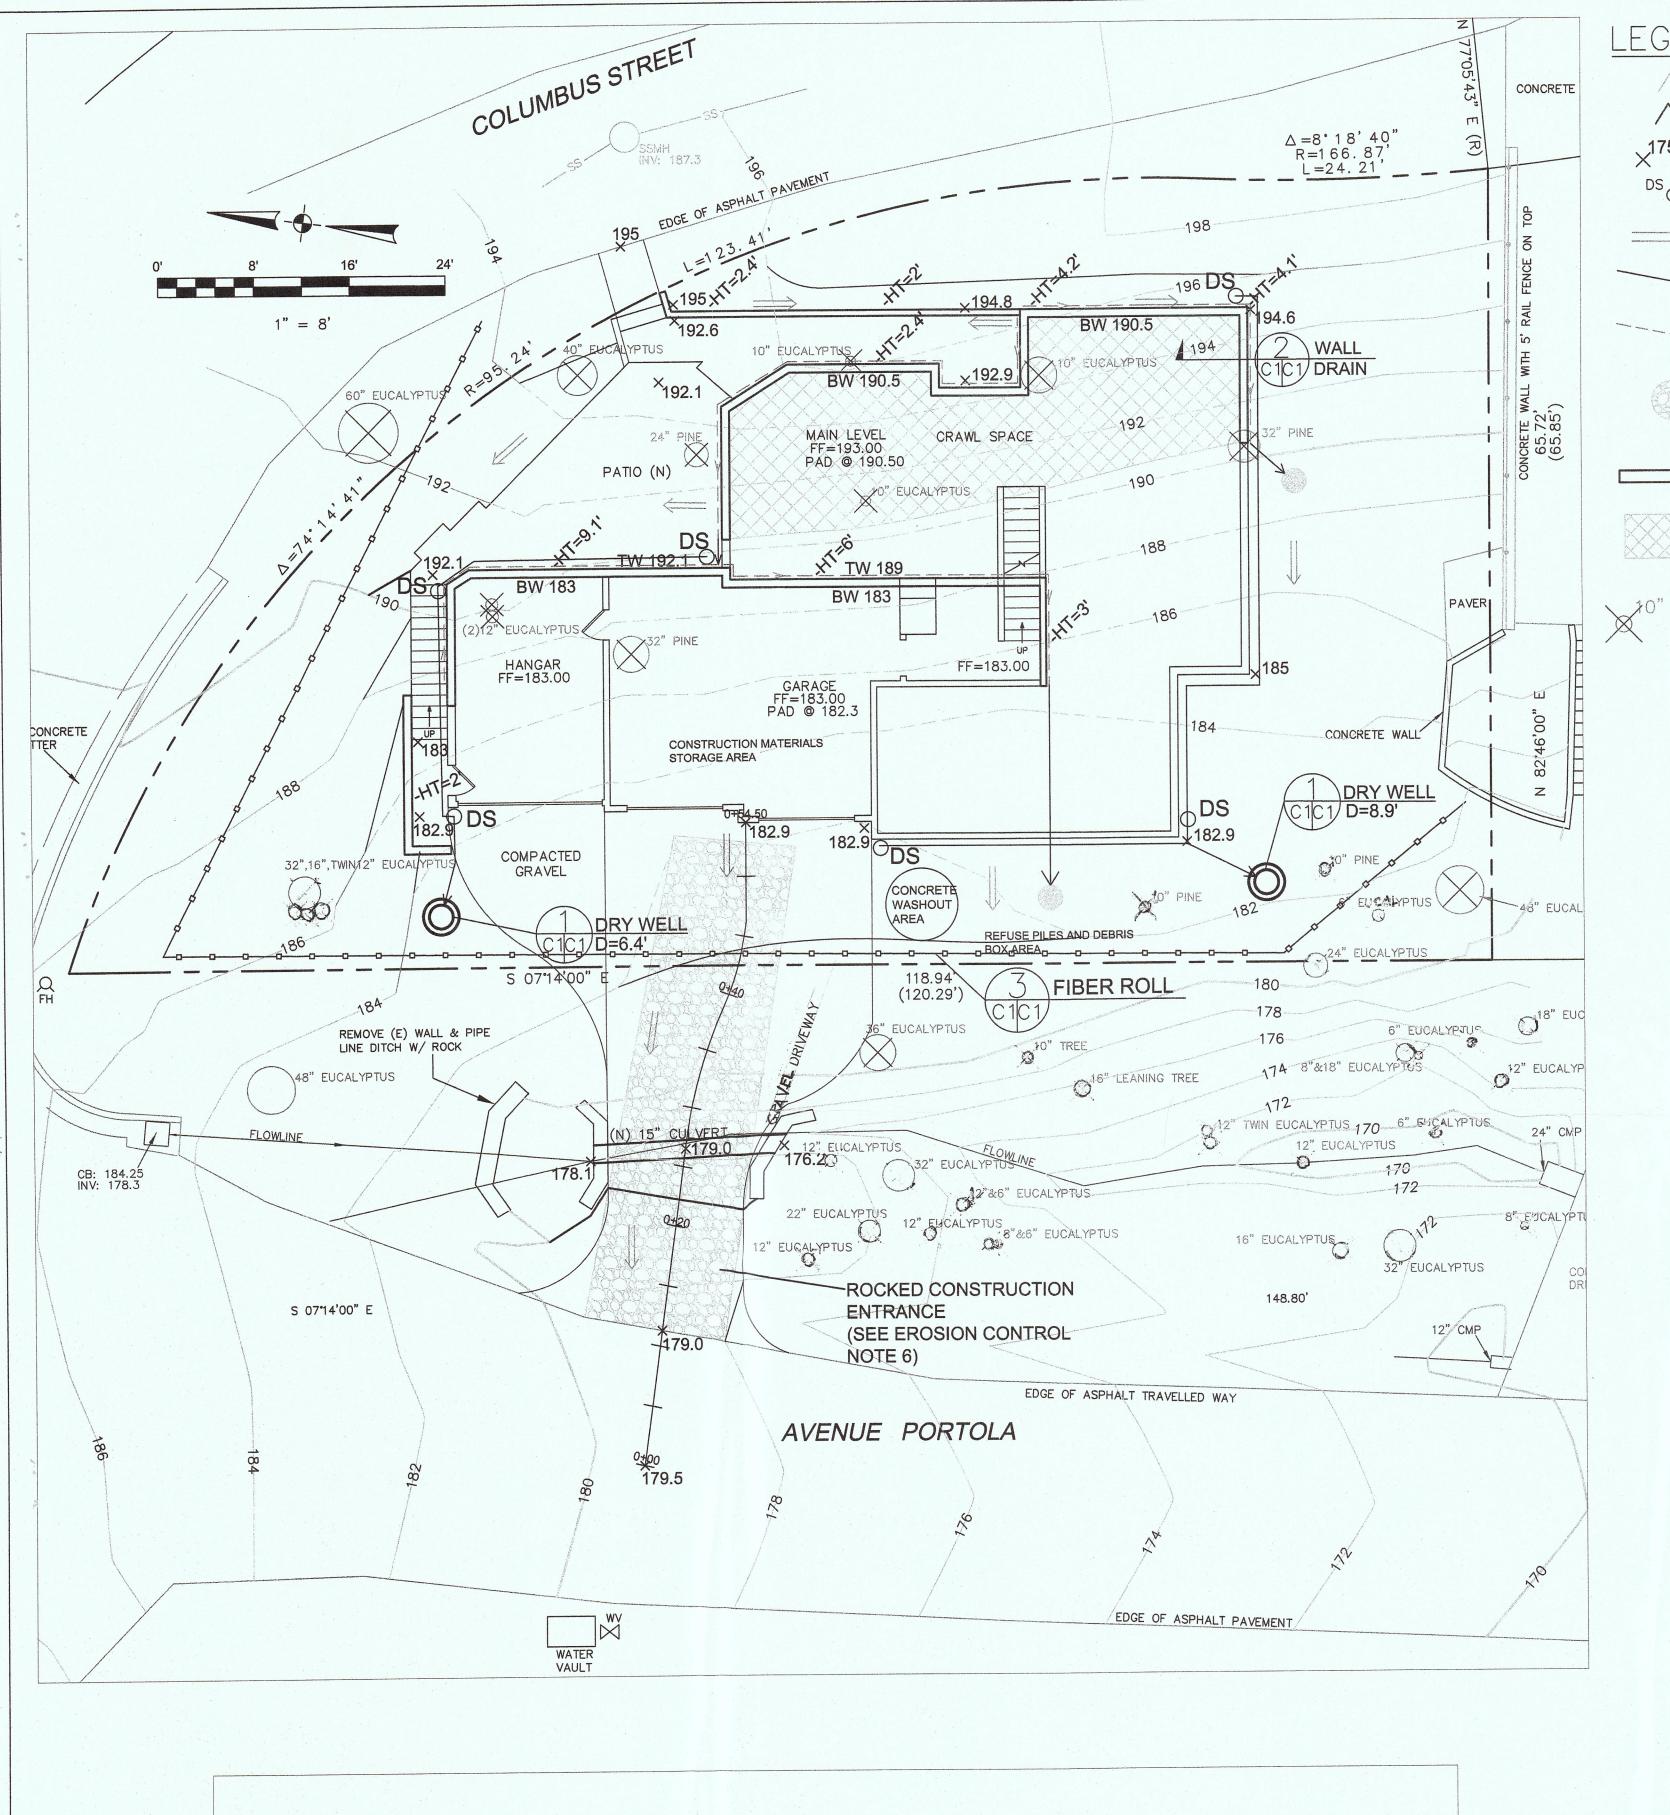

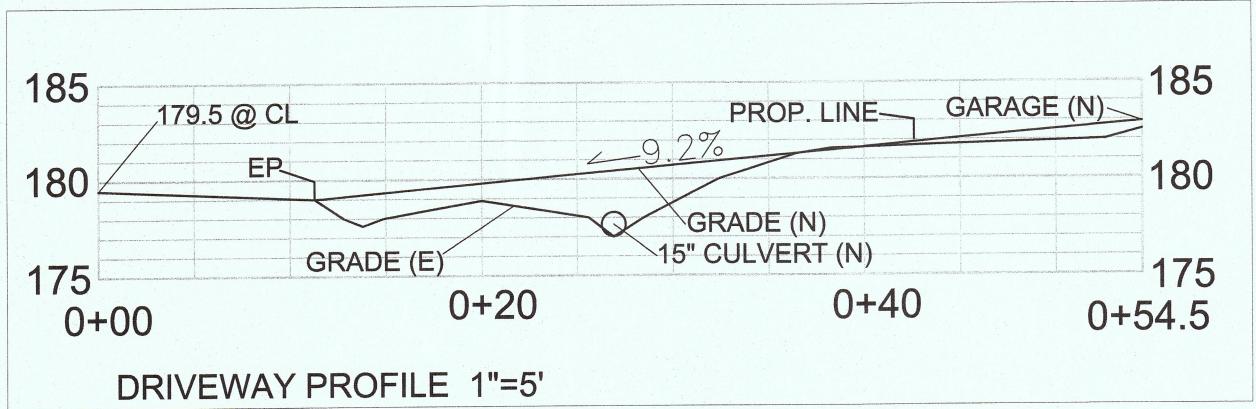

LEGEND

EXISTING CONTOURS

// PROPOSED CONTOURS

175.2 PROPOSED SPOT ELEVATION

DOWNSPOUT

DIRECTION OF SURFACE DRAINAGE FLOW

3" SOLID PLASTIC DRAIN PIPE, SDR 35 @ 1% MINIMUM SLOPE.

3" PERFORATED PLASTIC DRAIN PIPE, SDR 35 @ 1% MINIMUM SLOPE.

ENERGY DISSIPATER: 2-FT DIAMETER, 4-INCHES DEEP, FILLED WITH 2-4 INCH COBBLES

PROPOSED RETAINING WALL

CUT PAD FOR CRAWL SPACE

TREE TO BE REMOVED

GENERAL NOTES

- 1. PLANS PREPARED AT THE REQUEST OF:
- SUSAN CARKEEK, OWNER 2. SURVEY AND TOPOGRAPHY BY BGT LAND SURVEYING, SURVEYED
- IN JULY, 2015.
- 3. ELEVATION DATUM ASSUMED. 4. THIS IS NOT A BOUNDARY SURVEY.

GRADING NOTES

CUT VOLUME: 205 CY FILL VOLUME: 25 CY TOTAL: 240 CY CUT/FILL

1. ABOVE VOLUMES ARE APPROXIMATE.


2. MAXIMUM GRADIENT OF ANY MODIFIED SLOPES SHALL BE 2:1 (H:V). 3. ALL GRADING SHALL CONFORM TO LOCAL CODES AND ORDINANCES. 4. ALL TRENCHES IN PROPOSED LANDSCAPE AREAS SHALL BE BACKFILLED WITH COMPACTED APPROVED GRANULAR MATERIAL TO


WITHIN ONE FOOT OF FINISHED GRADE, AND THEN FILLED WITH HAND TAMPED SOILS.


DRAINAGE NOTES


1. DRAINAGE INTENT: IT IS THE INTENT OF THE DRAINAGE SYSTEM TO CONVEY ROOF AND DRIVEWAY RUNOFF TO A SAFE LOCATION, AND TO MINIMIZE EXCESSIVE MOISTURE AROUND FOUNDATIONS.

2. ALL ROOF DRAIN LINES SHALL LEAD TO DRY WELLS SHOWN. 5. ALL DRAINAGE PIPES SHALL BE 3" DIAMETER SOLID PIPE, SLOPED AT 1% MINIMUM.

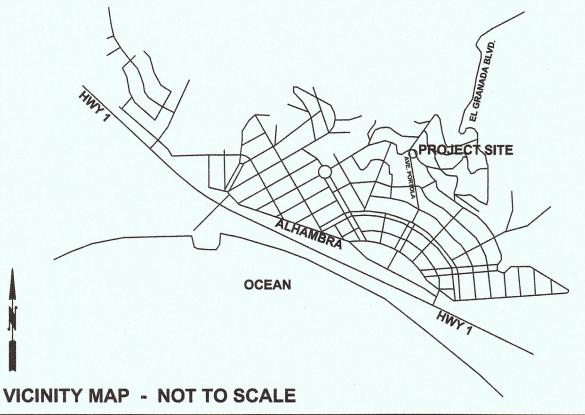

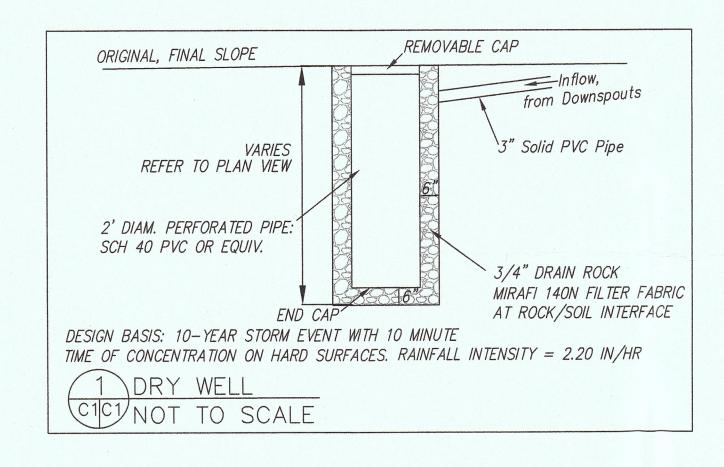

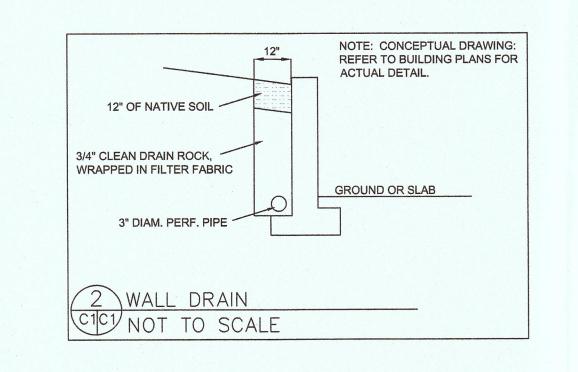

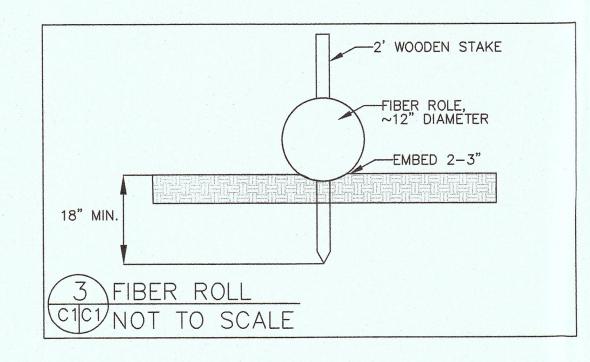

EROSION CONTROL NOTES

FIBER ROLL INSTALL AT LOCATIONS SHOWN. AFIX AS SHOWN IN DETAIL 3.

1. GRADING MAY TAKE PLACE DURING WET WEATHER AFTER OCTOBER 1 PROVIDED THE FOLLOWING PROVISIONS ARE FOLLOWED 2. NO GRADING SHALL TAKE PLACE DURING RAINY WEATHER OR FOR A PERIOD OF AT LEAST 24 HOURS FOLLOWING RAIN. 3. ALL EXPOSED SOIL SHALL BE TEMPORARILY PROTECTED FROM EROSION WITH JUTE

4. ALL STOCKPILED SOIL SHALL BE COVERED AT ALL TIMES AND REMOVED FROM SITE AS SOON AS POSSIBLE, IF SCHEDULED FOR OFF-HAUL. 5. ALL EXPOSED SURFACES SHALL BE PERMANENTLY PROTECTED FROM EROSION WITH SEEDING AND/OR LANDSCAPING. SEED MIX SHALL BE 75 LB PER ACRE ANNUAL RYGRASS OR APPROVED SUBSTITUTE. SEED SHALL BE COVERED WITH STRAW MULCH AT A RATE OF 2 TONS/ACRE. 6. ROCKED CONSTRUCTION ENTRANCE SHALL BE 50 FEET LONG BY 13 FEET WIDE AND

CONFORM TO THE FOLLOWING A. THE MATERIAL FOR THE PAD SHALL BE 2 TO 3 INCH STONE. B. PAD SHALL BE NOT LESS THAN 8" THICK.

C. THE ENTRANCE SHALL BE MAINTAINED IN A CONDITION THAT WILL PREVENT TRACKING OR FLOWING OF SEDIMENT ONTO PUBLIC RIGHT-OF-WAY. THIS MAY REQUIRE PERIODIC TOP DRESSING WITH ADDITIONAL STONE AS CONDITIONS DEMAND, AND REPAIR AND/OR CLEANOUT OF ANY MEASURES USED TO TRAP SEDIMENT. ALL SEDIMENT SPILLED, DROPPED, WASHED, OR TRACKED ONTO PUBLIC RIGHT-OF-WAY SHALL BE REMOVED IMMEDIATELY.

D. WHEN NECESSARY, WHEELS SHALL BE CLEANED TO REMOVE SEDIMENT PRIOR TO ENTRANCE ONTO PUBLIC RIGHT-OF-WAY. WHEN WASHING IS REQUIRED, IT SHALL BE DONE ON AN AREA THAT DRAINS TO THE CONCRETE WASHOUT AREA. 7. CONCRETE WASHOUT AREA SHALL BE SURROUNDED BY A SINGLE LAYER OF SAND BAGS TO CONTAIN FLUIDS. CHANNEL INTO AREA SHALL BE CLEARED TO ALLOW TIRE DEBRIS (SEE NOTE 6.D. ABOVE)

EROSION CONTROL POINT OF CONTACT

THIS PERSON WILL BE RESPONSIBLE FOR EROSION CONTROL AT THE SITE AND WILL BE THE COUNTY'S MAIN POINT OF CONTACT IF CORRECTIONS ARE REQUIRED. NAME: CHARLES KISSICK

TITLE/QUALIFICATION: ENGINEER

650-728-3590 SIGMAPRM@PACBELL.NET

USE OF PLASTIC SHEETING BETWEEN OCTOBER 1st AND APRIL 30th IS NOT ACCEPTABLE
 UNLESS FOR USE ON STOCKPILES WHERE THE STOCKPILE IS ALSO PROTECTED WITH
 FIBER ROLLS CONTAINING THE BASE OF THE STOCKPILE.

SECTION AND DETAIL CONVENTION


REFERENCE SHEET No. ON WHICH SECTION OR DETAIL IS SHOWN

No. 62264

REFERENCE SHEET No. FROM WHICH SECTION OR DETAIL IS TAKEN

GRADING, DRAINAGE EROSION CONTROL PLA

SHEET

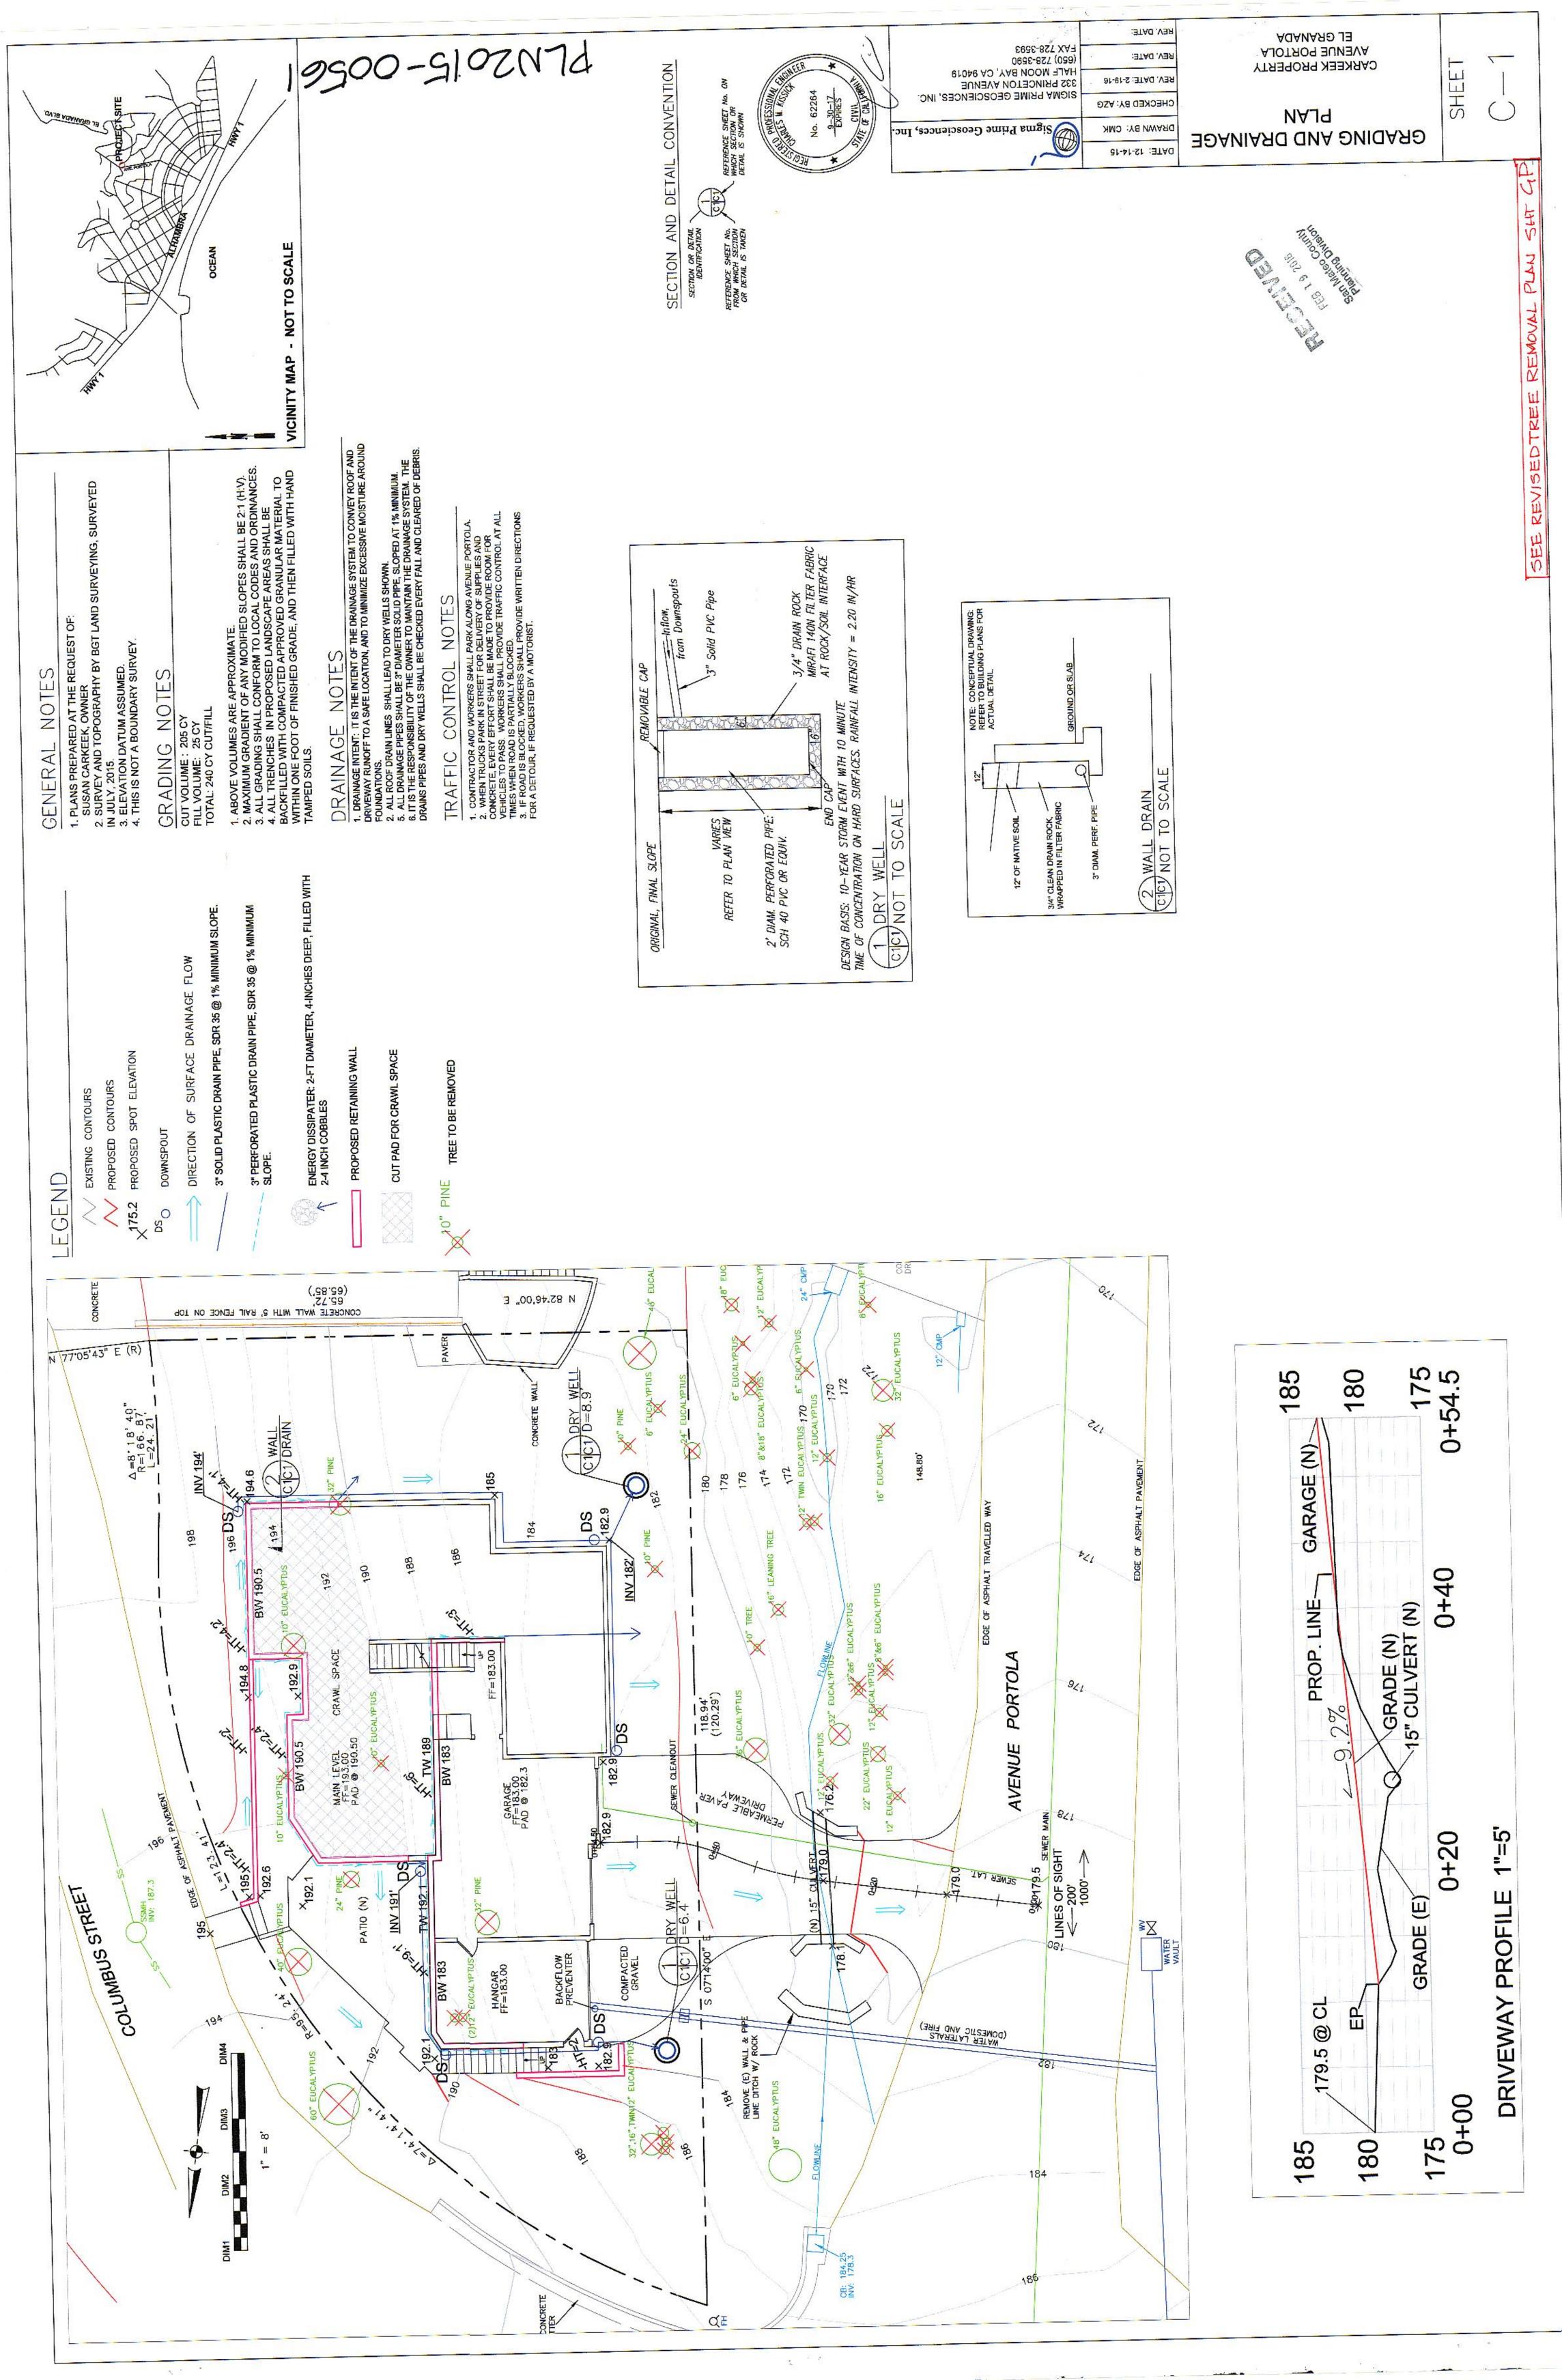

SHTGP

SEE REVISED TREE REMOVAL PLAN

EROSION CONTROL PLAN

DEAWN BY: CMK DATE: 12-14-15

STANDESSIONAL HOSOCAL No. 62264 9-30-17 EXPIRES SATE OF CALLED Sigma Prime Geosciences, Inc.

NOTES FIBER ROLL INSTALL AT LOCATIONS SHOWN. AFIX AS SHOWN IN DETAIL 3. CONTROL

CONCRETE

-ROCKED CONSTRUCTION ENTRANCE (SEE EROSION CONTROL NOTE 6)

PORTOLA

AVENUE

SITE

20.24 20.24

CONTACT POINT OF EROSION CONTROL

@PACBELLNET TTLE/QUALIFICATION

EROSION

GRADING MAY TAKE PLACE DURING WET WEATHER AFTER OCTOBER 1 PROVIDED THE OLLOWING PROVISIONS ARE FOLLOWED.

NO GRADING SHALL TAKE PLACE DURING RAINY WEATHER OR FOR A PERIOD OF AT EAST 24 HOURS FOLLOWING RAIN.

ALL EXPOSED SOIL SHALL BE TEMPORARILY PROTECTED FROM EROSION WITH JILTER FROM LY PROTECTED FROM EROSION WITH BE 75 LB PER ACRE ANNUAL L BE COVERED WITH STRAW MULCH TIMES AND REMOVED FROM SITE

SEDIMENT SPILLED, DROPPED, WASHED, OR TRACKED ONTO PUBLIC RIGHT-OF-WAY SHALL BE REMOVED IMMEDIATELY.

SHALL BE REMOVED IMMEDIATELY.

D. WHEN NECESSARY, WHEELS SHALL BE CLEANED TO REMOVE SEDIMENT PRIOR TO D. WHEN NECESSARY, WHEELS SHALL BE CHTRANCE ONTO PUBLIC RIGHT-OF-WAY. WHEN WASHING IS REQUIRED, IT SHALL BE DONE ON AN AREA THAT DRAINS TO THE CONCRETE WASHOUT AREA.

7. CONCRETE WASHOUT AREA SHALL BE SURROUNDED BY A SINGLE LAYER OF SAND BAGS TO CONTAIN FLUIDS. CHANNEL INTO AREA SHALL BE CLEARED TO ALLOW TIRE DEBRIS (SEE NOTE 6.D. ABOVE) ENTRANCE SHALL BE 50 FEET LONG BY 13 FEET WIDE AND THE MATERIAL FOLLOWING:
HE MATERIAL FOLLOWING:
HE MATERIAL FOR THE PAD SHALL BE 2 TO 3 INCH STONE.
AD SHALL BE NOT LESS THAN 8" THICK.
HE ENTRANCE SHALL BE MAINTAINED IN A CONDITION THAT HE ENTRANCE SHALL BE MAINTAINED IN A CONDITION THAT SING OR PLOWING OF SEDIMENT ONTO PUBLIC RIGHT-OF-W DIG TOP DRESSING WITH ADDITIONAL STONE AS CONDITION TO PARCHED ONTO PUE RANDYOR CLEANOUT OF ANY MEASURES USED TO TRAP SIR ANDYOR CLEANOUT OF ANY MEASURES USED TO TRAP SIR ANDYOR CLEANOUT OF ANY MEASURES USED TO TRAP SIR ANDYOR CLEANOUT OF ANY MEASURES USED TO TRAP SIR

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THIS PERSON WILL BE RESPONSIBLE FOR EROSION CONTROL AT THE SITE AND WILL COUNTYS MAIN POINT OF CONTACT IF CORRECTIONS ARE REQUIRED. CHARLES KISSICK

USE OF PLASTIC SHEETING BETWEEN OCTOBER 1st AND APRIL 30th IS NOT ACCEPTABLE, UNLESS FOR USE ON STOCKPILES WHERE THE STOCKPILE IS ALSO PROTECTED WITH FIBER ROLLS CONTAINING THE BASE OF THE STOCKPILE.

• THE TREE PROTECTION SHALL BE IN PLACE BEFORE ANY GRUBBING IS STARTED.

-FIBER ROLE, ~12" DIAMETER S FIBER ROLL CICINOT TO SCALE

WOODEN STAKE

NOTES SEDIMENT CONTROL AND EROSION GENERAL

There will be no stockpiling of soil. All excavated soil will be hauled off-site as it is excavated.

N 77'05'43" E (R)

Δ=8·18' 40" R=166.87' L=24.21'

- Perform clearing and earth-moving activities only during dry weather. Measures to ensure adequate erosion and sediment control shall be installed prior to earth-moving
- Stabilize all denuded areas and maintain erosion control measures continuously between Measures to ensure adequate erosion and sediment control are required year-round. activities and construction. October 1 and April 30.
 - Store, handle, and dispose of construction materials and wastes properly, so as to prevent their contact with stormwater.
- cutting wastes, paints, concrete, petroleum products, chemicals, wash water or sediments, and non-stormwater discharges to storm drains and watercourses. Control and prevent the discharge of all potential pollutants, including pavement

(65.85°) 65.72° CONCRETE WALL WITH 5' RAIL FENCE ON TOP

194

×192.9

BW 190.5

×192.1

24" PINE

PATIO (N)

BW 190.5

×194.8

192.6

ŽΠ

C. YK

190

2/1/X TW 189

BW 183

X X X

BW 183

GARAGE

CONSTRUCTION STORAGE AREA

(E) STANDARD CONCRETE CURB & GUTTER

LATE.

196

198

EDGE OF ASPHALT PAVEMENT

COLUMBUS STREET

- Use sediment controls or filtration to remove sediment when dewatering site and obtain
 - Avoid cleaning, fueling, or maintaining vehicles on-site, except in a designated area Regional Water Quality Control Board (RWQCB) permit(s) as necessary. where wash water is contained and treated.
 - Limit and time applications of pesticides and fertilizers to prevent polluted runoff.
 - Limit construction access routes to stabilized, designated access points
- Avoid tracking dirt or other materials off-site; clean off-site paved areas and sidewalks using dry sweeping methods.
- Train and provide instruction to all employees and subcontractors regarding the Watershed

(APPROXIMATE FOOTPRINT)

85.40,00, E

PAVER

- The areas delineated onh the plans for parking, grubbing, storage etc., shall not be Protection Maintenance Standards and construction Best Management Practices. Placement of erosion materials is required on weekends and during rain events.
- Dust control is required year-round. enlarged or "run over."
- Erosion control materials shall be stored on-site

FOUND 3/4" IP WITH PLASTIC PLUG AND TACK "LS 6679"

₩ EUCALY

411

176.2×

178

180

ROL

FIBER

118.94 (120.29')

PERMEABLE DAVER

ROCK &

REMOVE (E) WAI

184

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X

187

CONCRETE WASHOUT AREA

182.9


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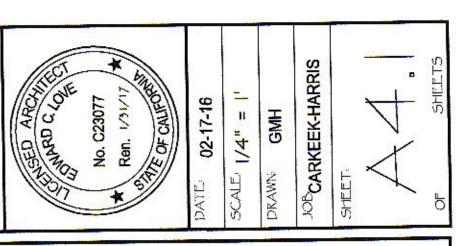
COMPACTED

× 11-12 182.9 ☐

SECOND/THIRD FLOOR LEVELS

- Use of plastic sheeting between October 1st and April 30th is not acceptable, unless for use on stockpiles where the stockpile is also protected with fiber rolls containing the base of the stockpile. The tree protection shall be in place before any grading, excavating or grubbing is started.



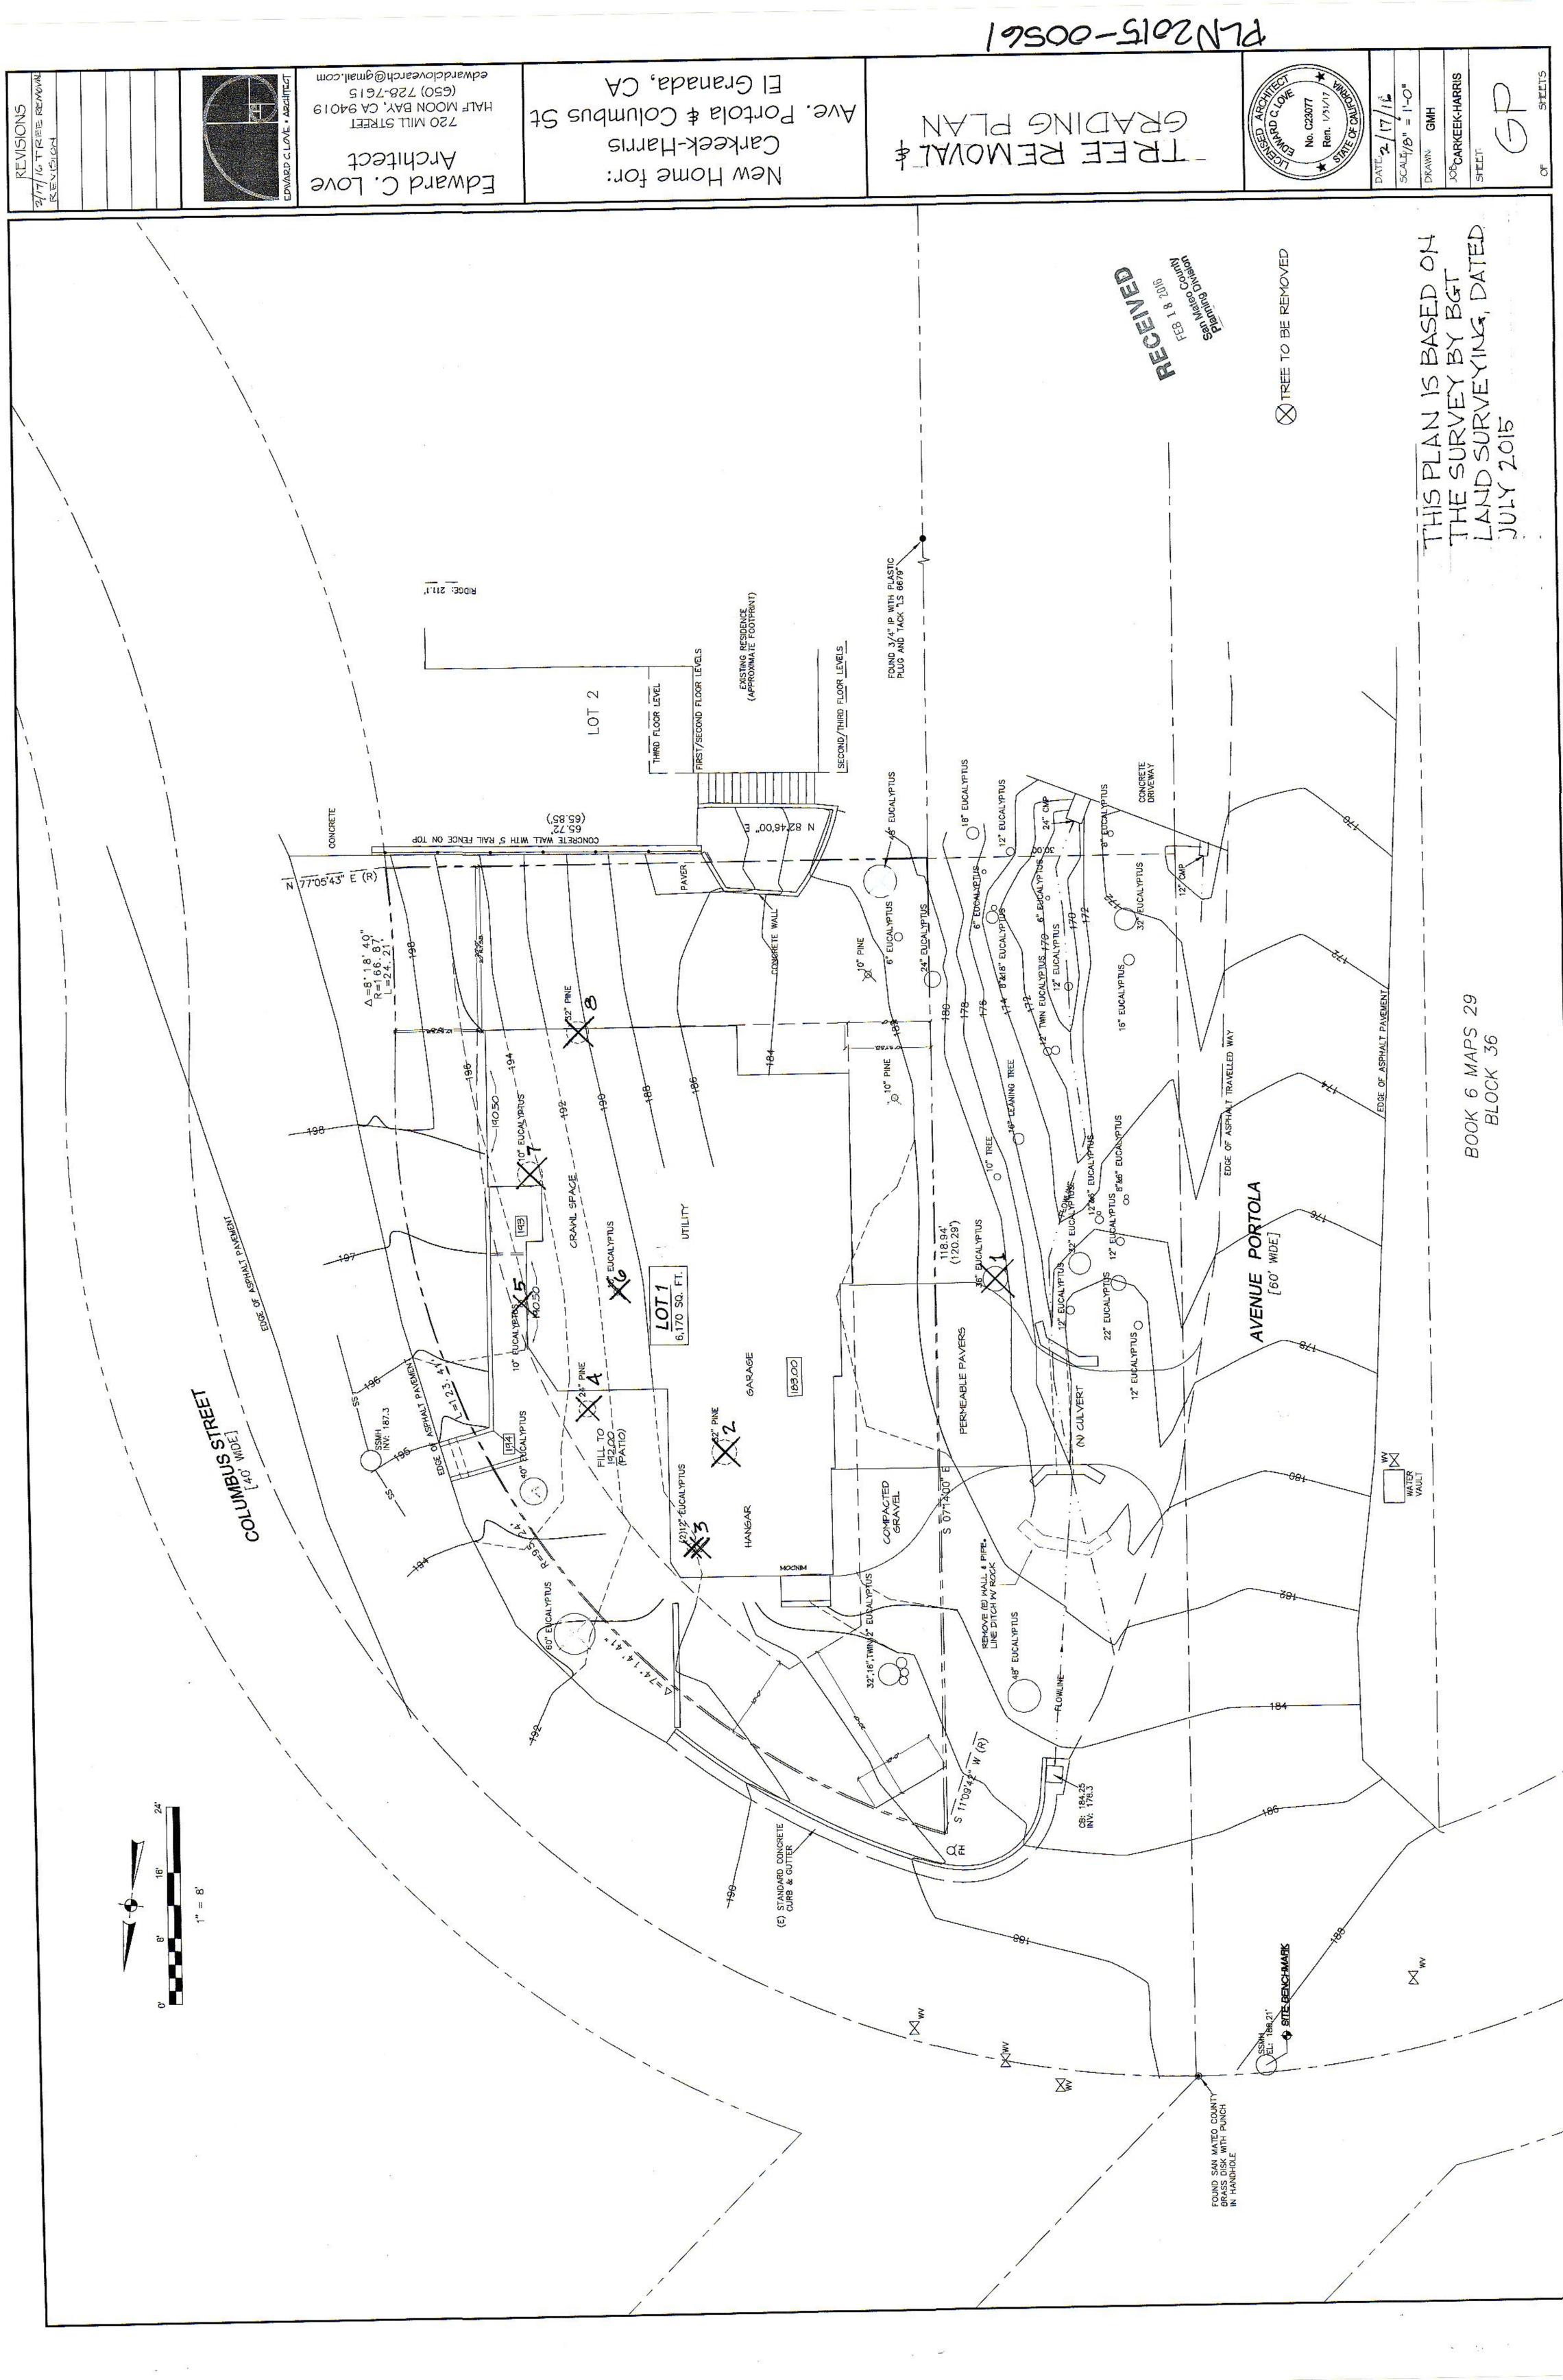


REVISIONS


720 MILL STREET HALF MOON BAY, CA 94019 (650) 728-7615 edwardclovearch@gmail.com

El Granada, CA Carkeek-Harris

Ave. Portola & Columbus St

New Home for:

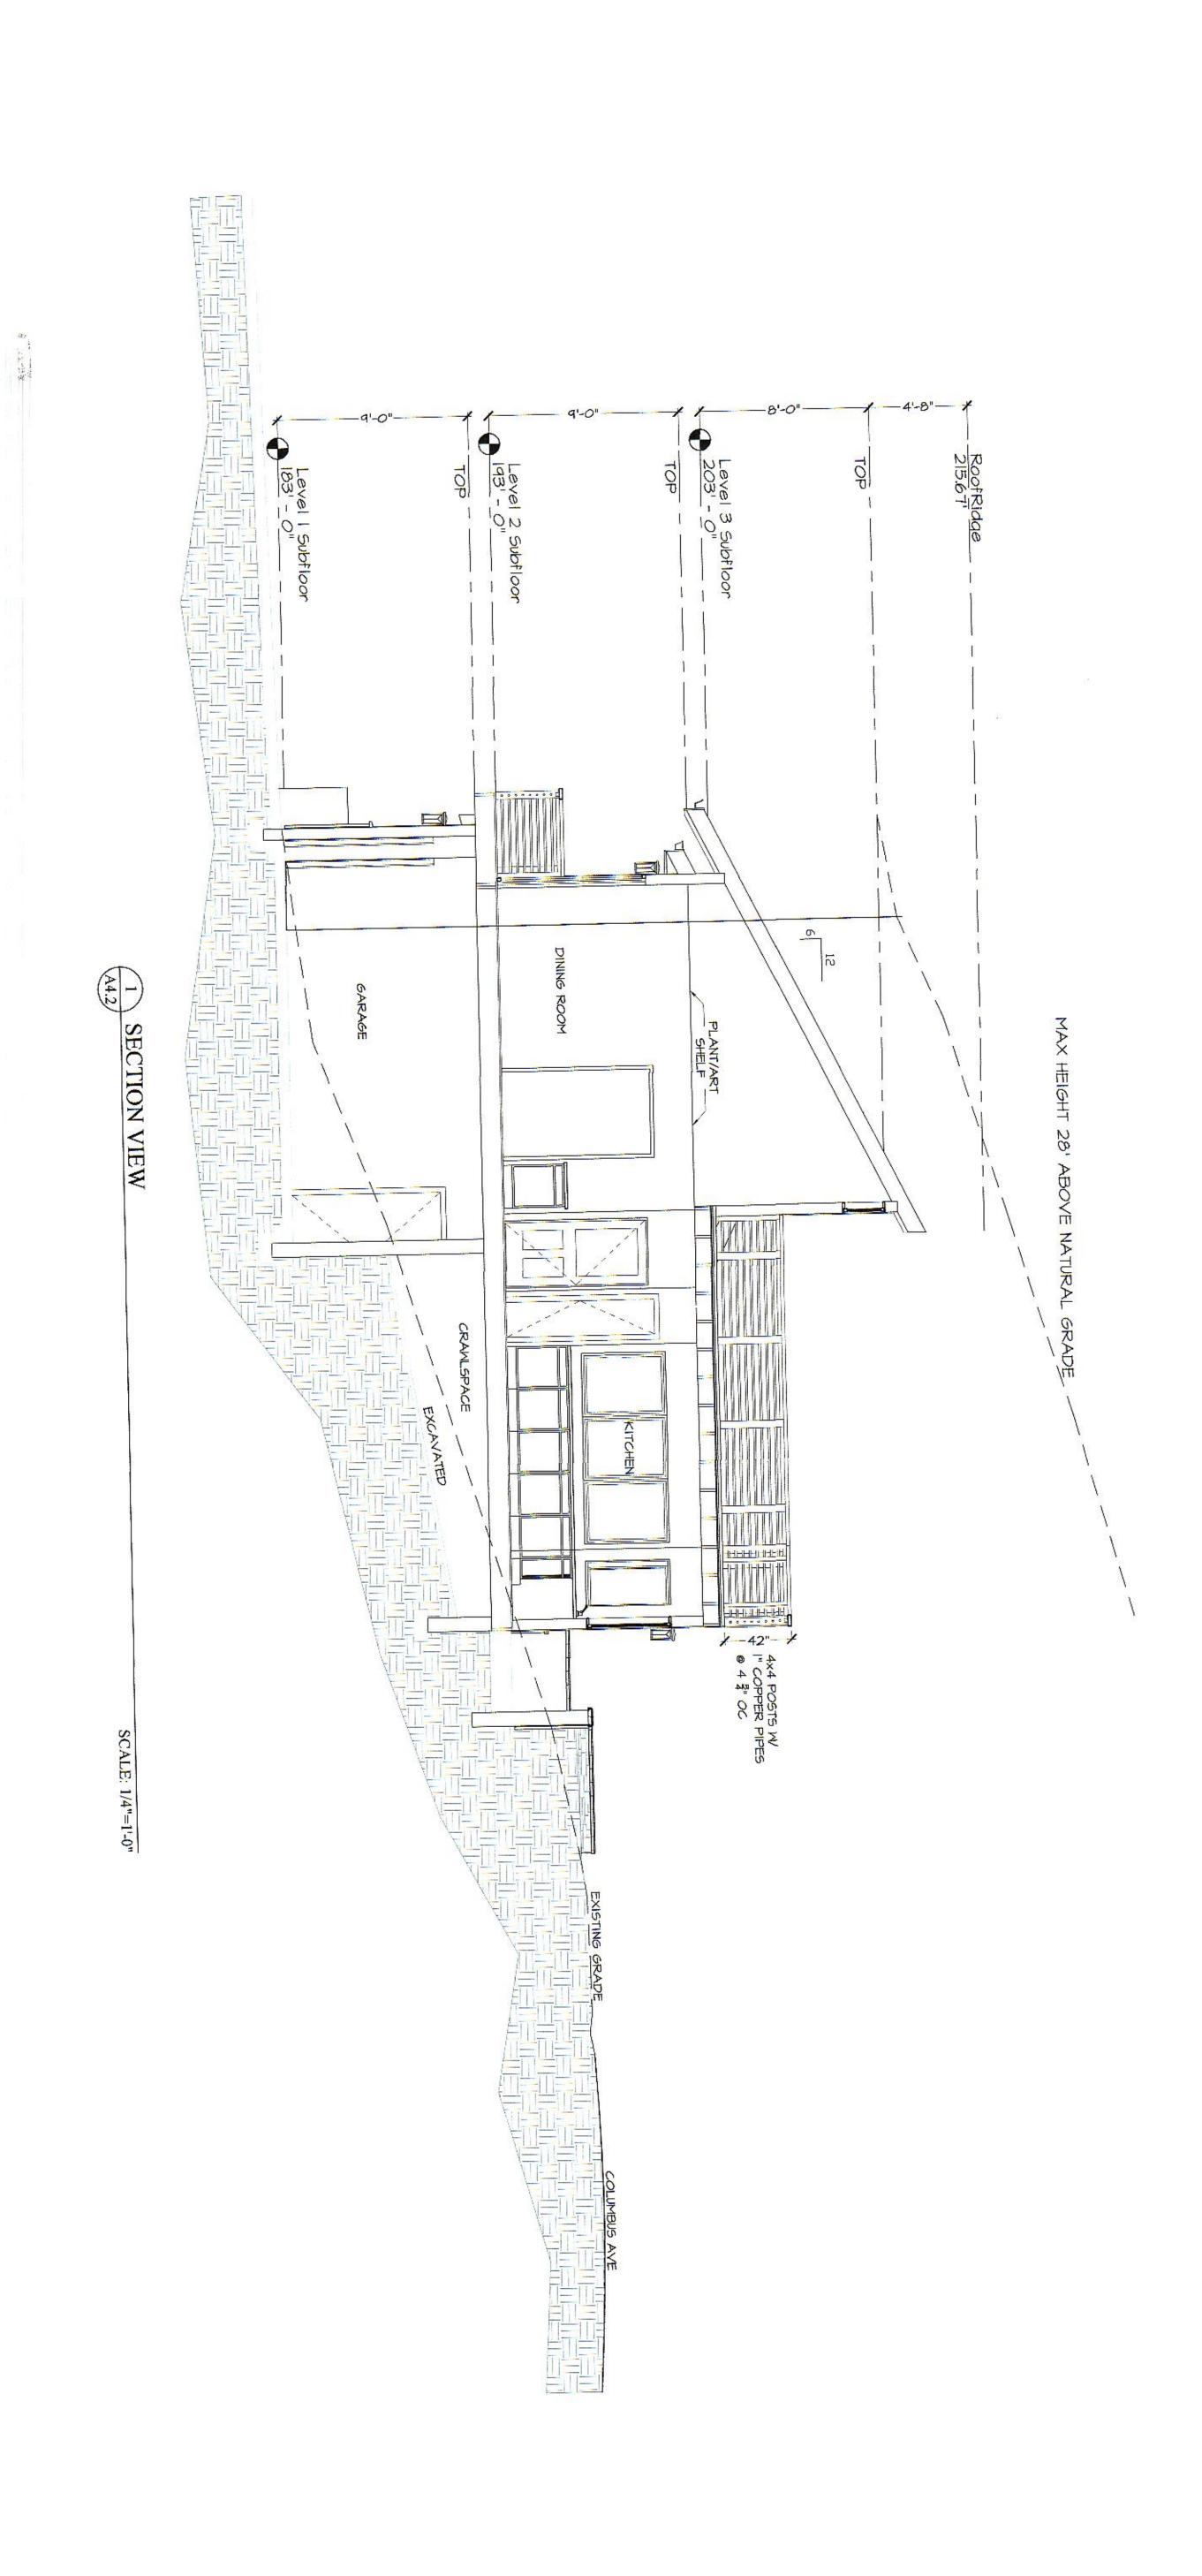


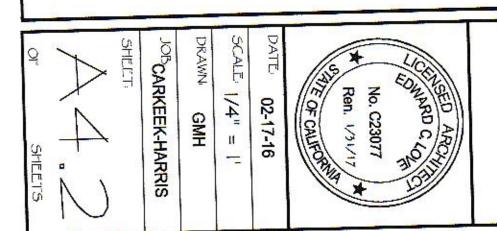



SECTION VIEW

New Home for: Carkeek-Harris Ave. Portola & Columbus St El Granada, CA Edward C. Love Architect

720 MILL STREET
HALF MOON BAY, CA 94019
(650) 728-7615
edwardclovearch@gmail.com

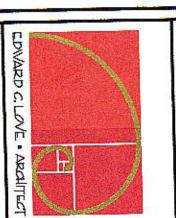

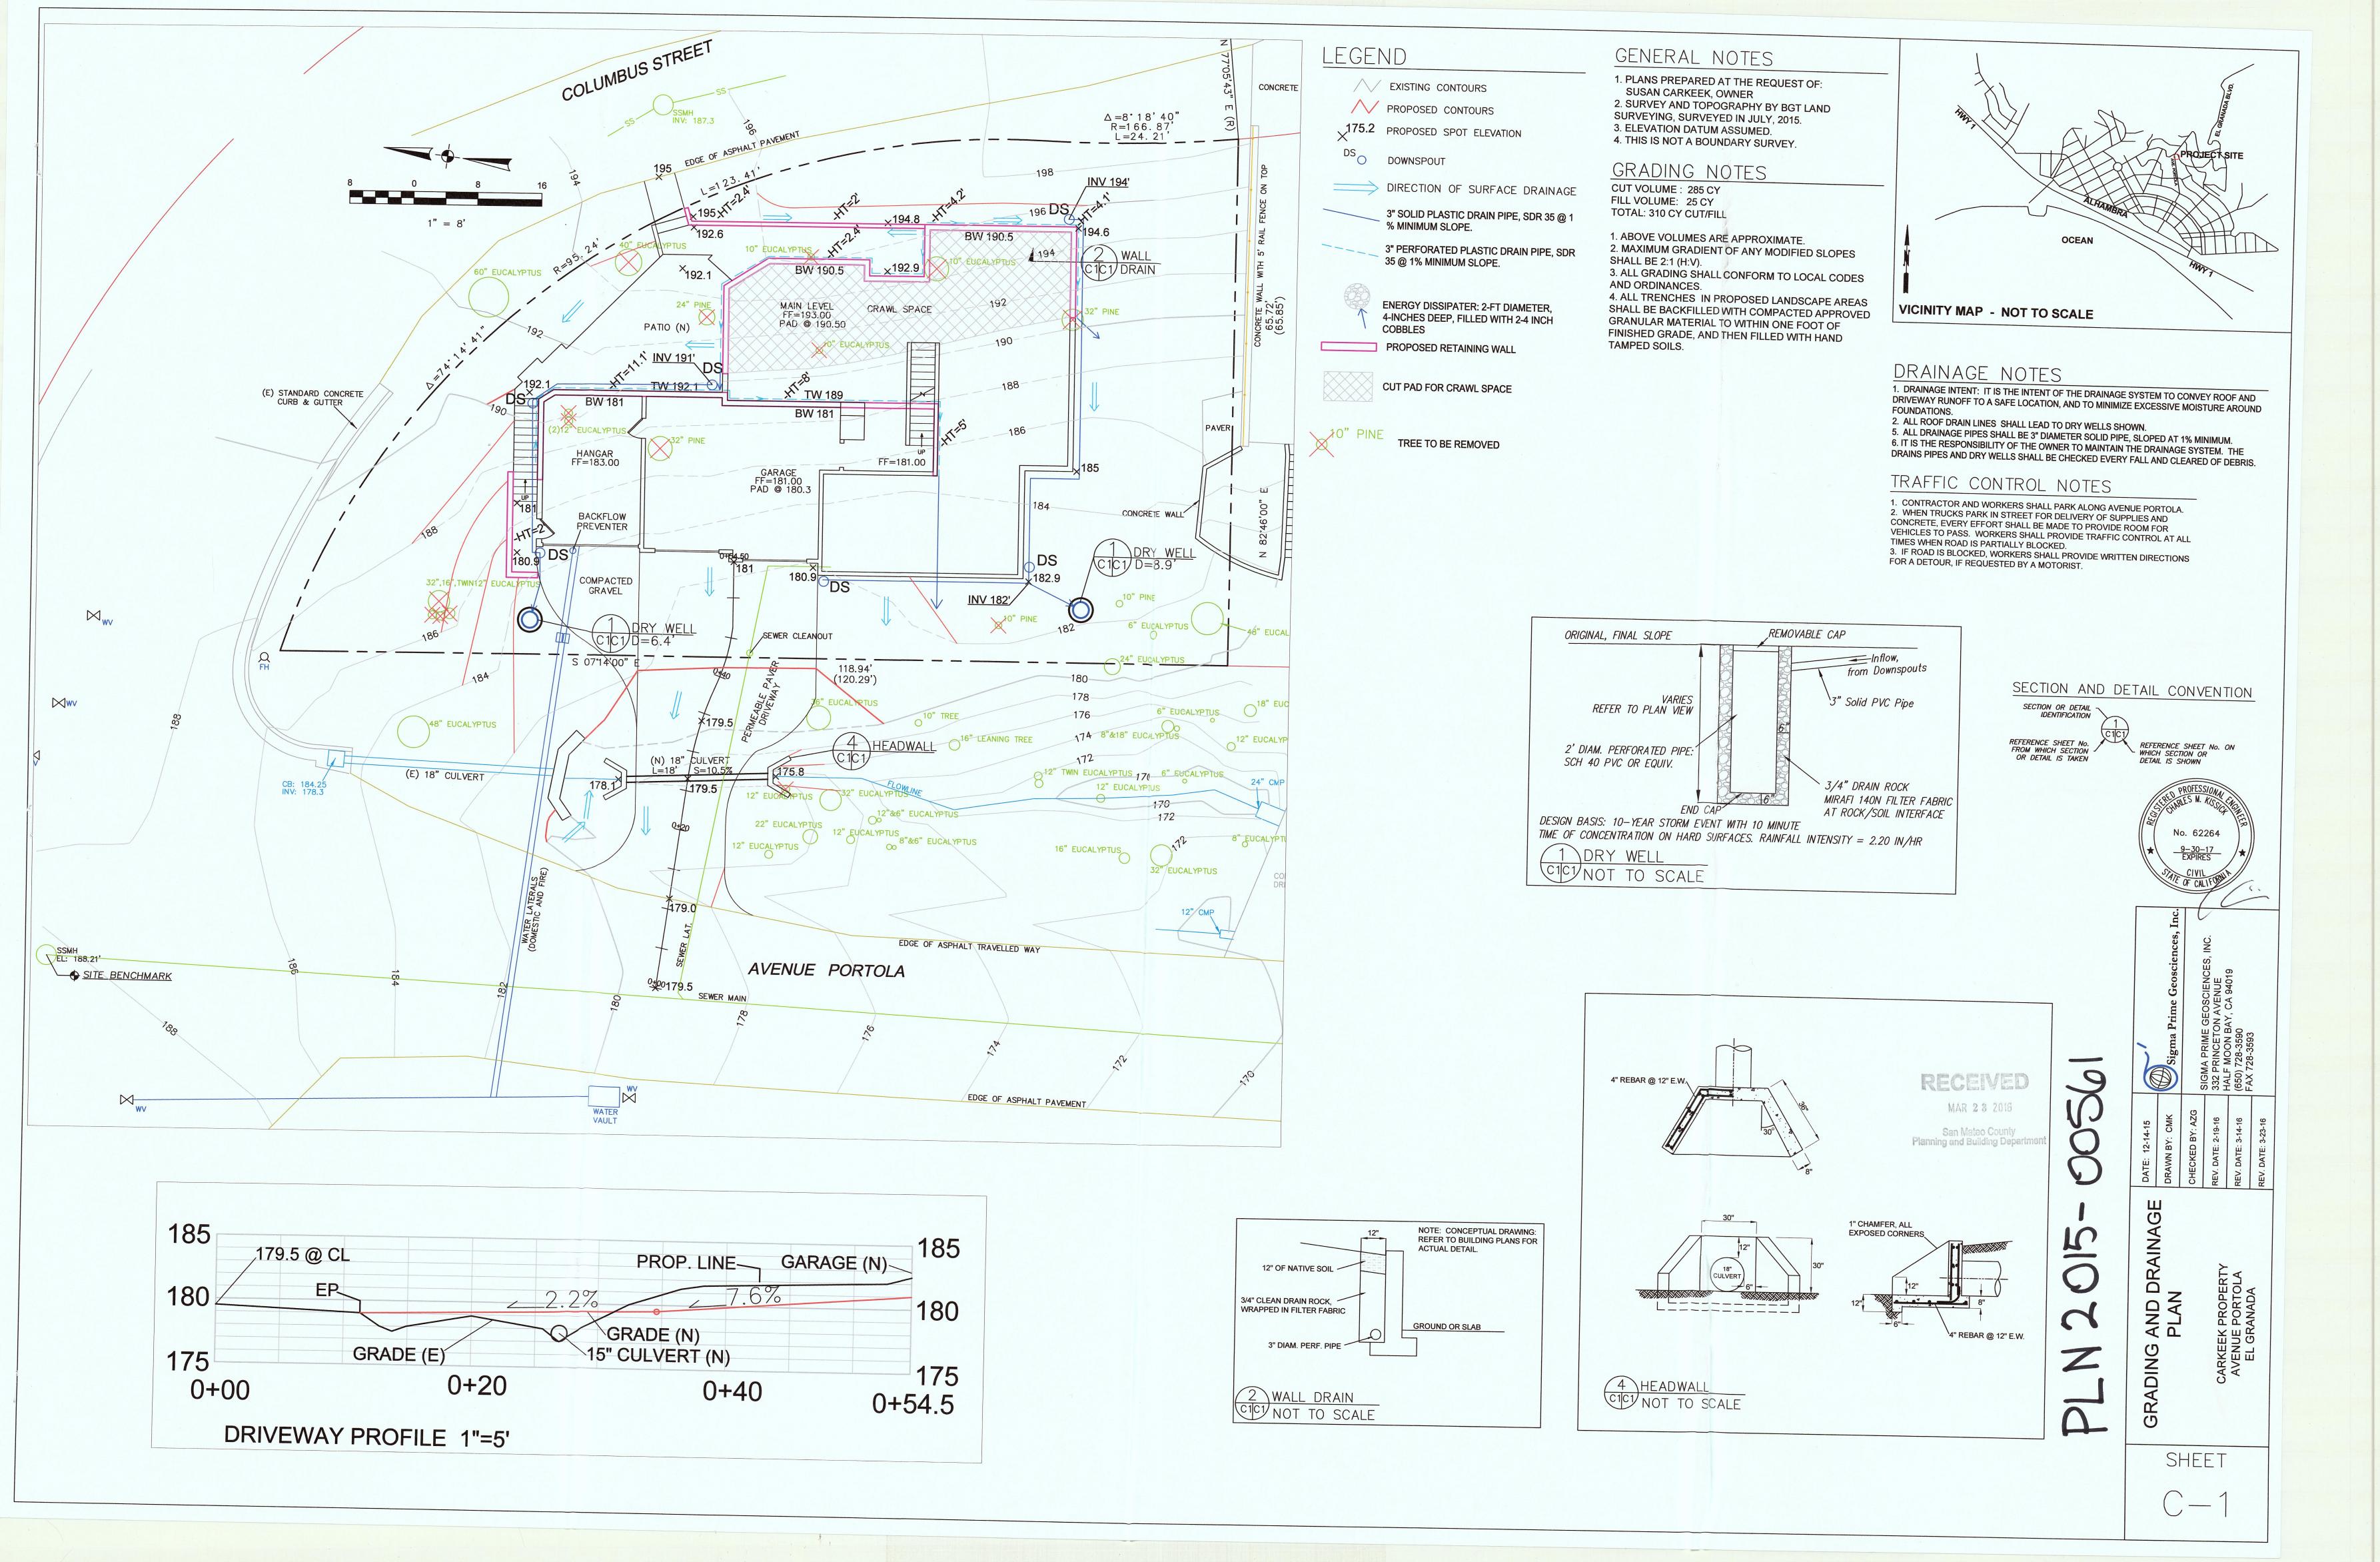

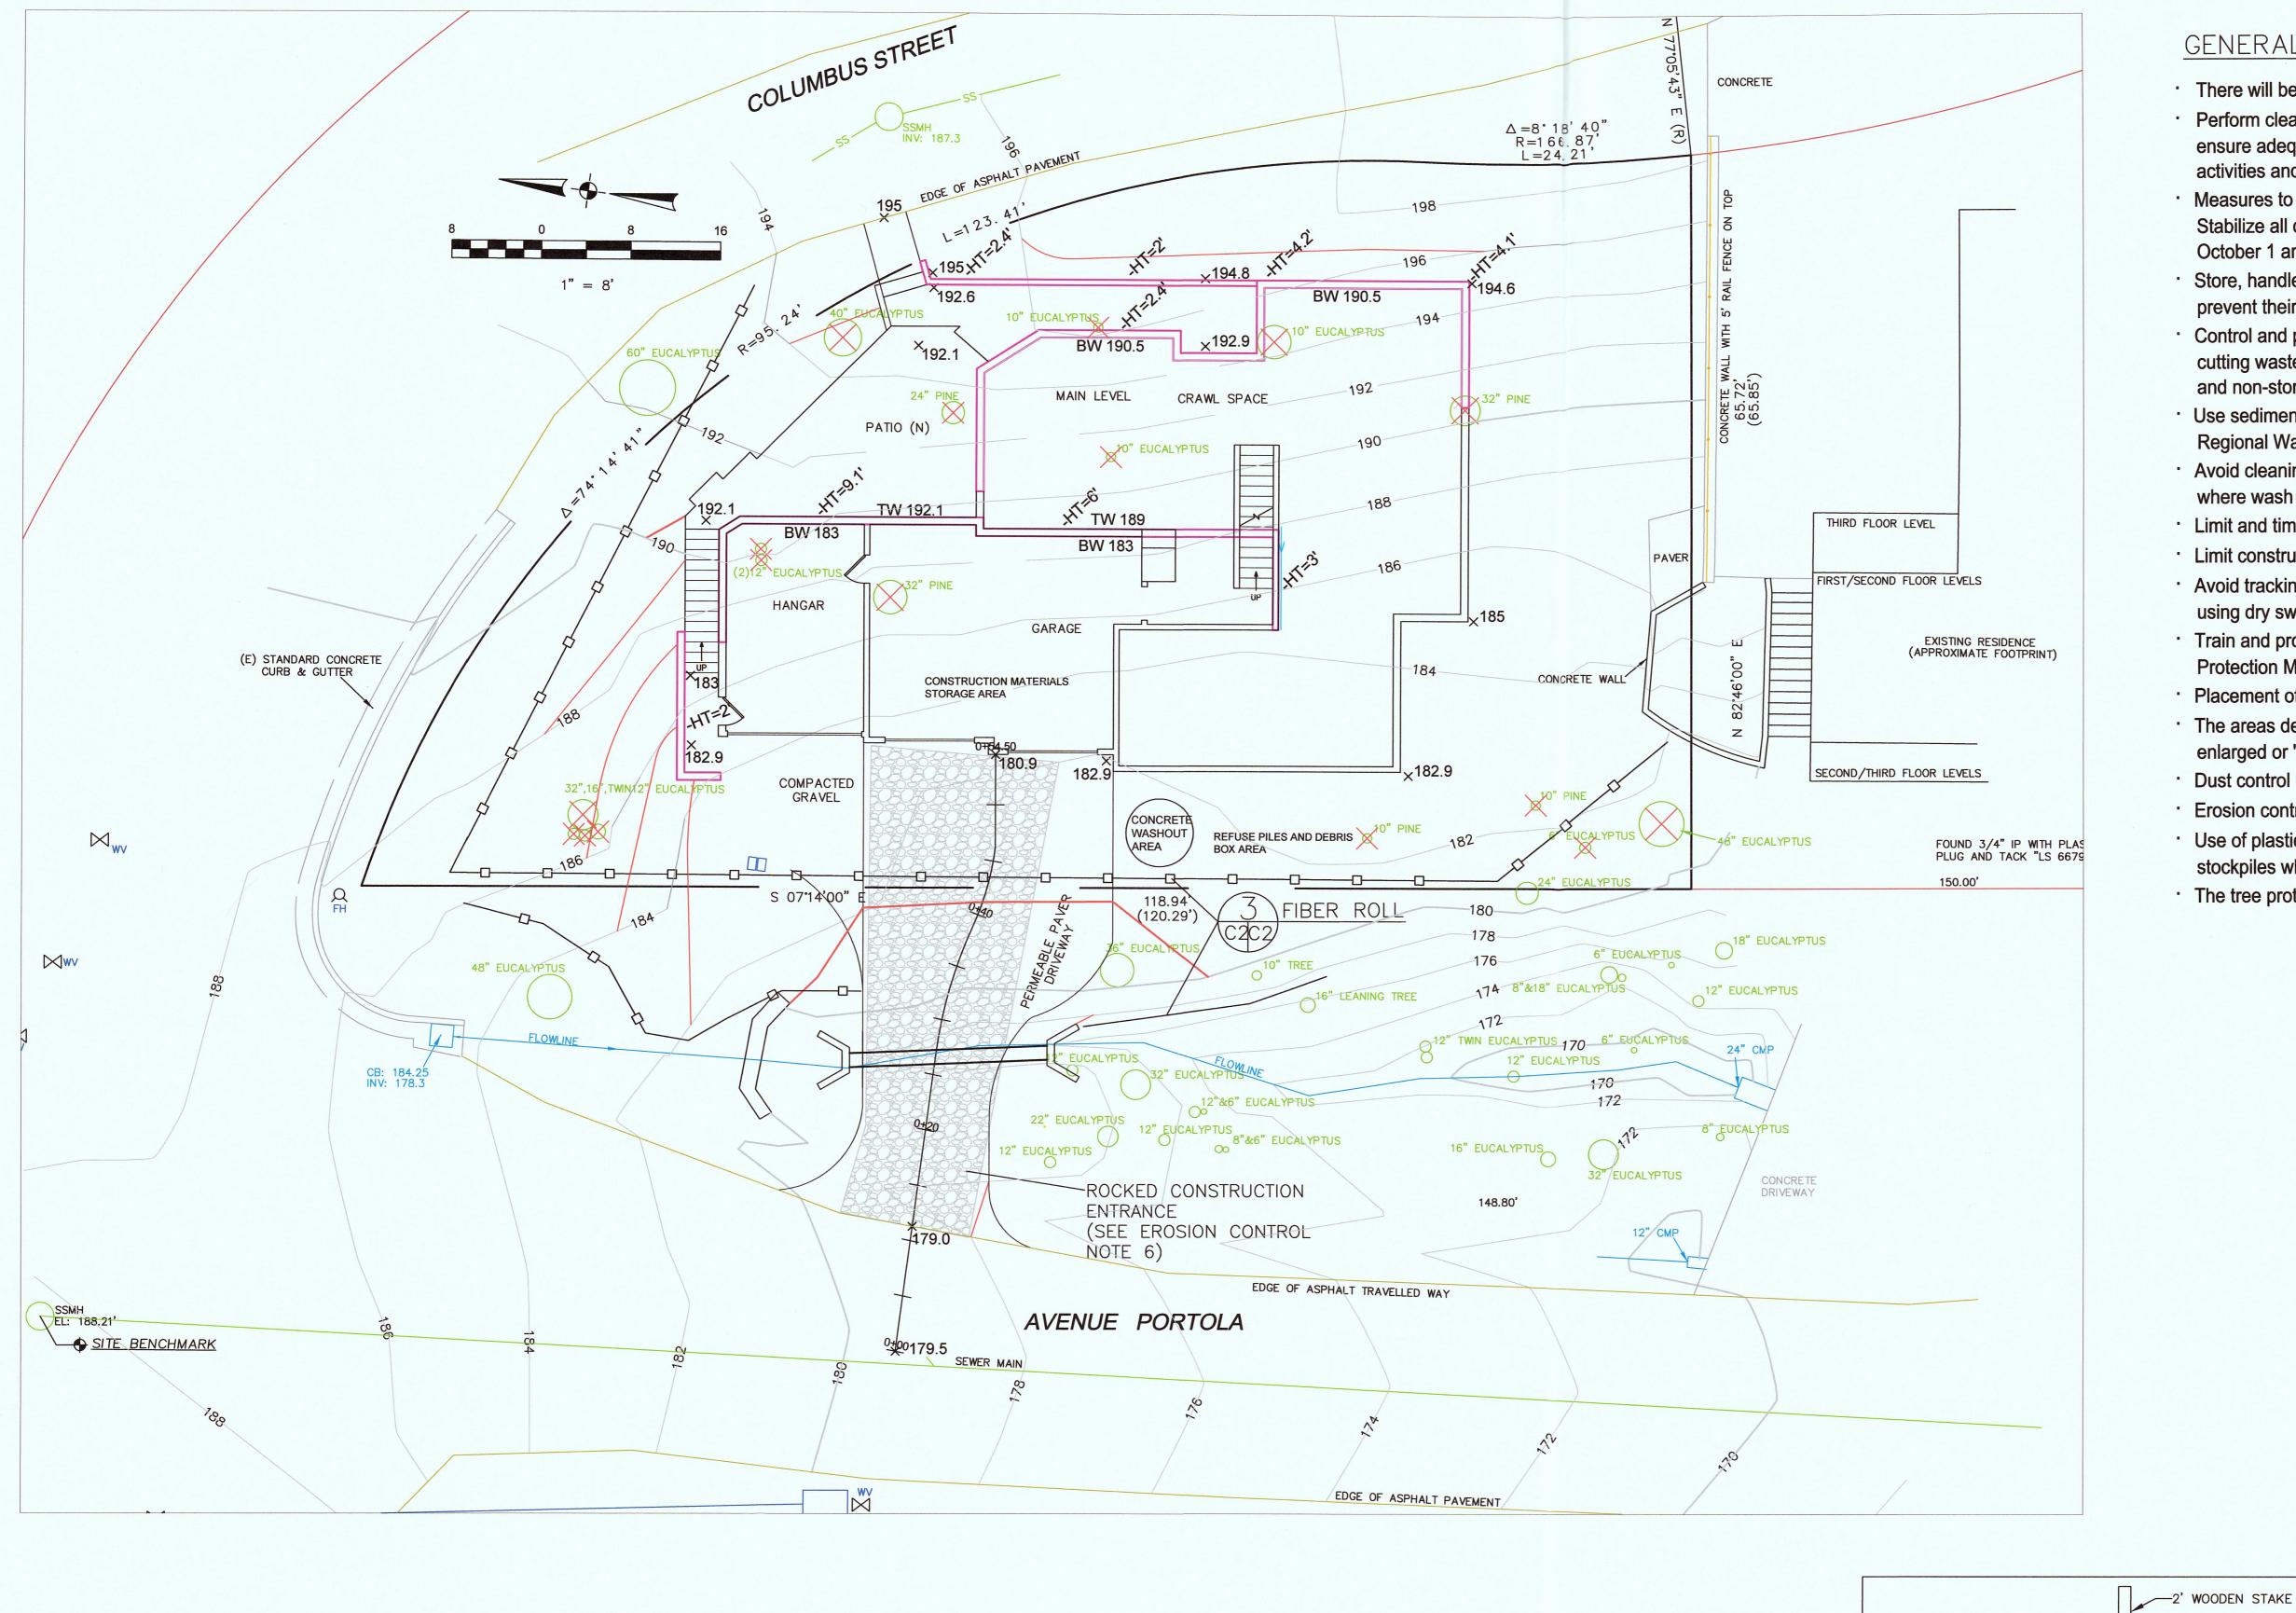

GENERAL EROSION AND SEDIMENT CONTROL NOTES


- · There will be no stockpiling of soil. All excavated soil will be hauled off-site as it is excavated.
- · Perform clearing and earth-moving activities only during dry weather. Measures to ensure adequate erosion and sediment control shall be installed prior to earth-moving activities and construction.
- · Measures to ensure adequate erosion and sediment control are required year-round. Stabilize all denuded areas and maintain erosion control measures continuously between October 1 and April 30.
- · Store, handle, and dispose of construction materials and wastes properly, so as to prevent their contact with stormwater.
- · Control and prevent the discharge of all potential pollutants, including pavement cutting wastes, paints, concrete, petroleum products, chemicals, wash water or sediments, and non-stormwater discharges to storm drains and watercourses.
- · Use sediment controls or filtration to remove sediment when dewatering site and obtain Regional Water Quality Control Board (RWQCB) permit(s) as necessary.
- · Avoid cleaning, fueling, or maintaining vehicles on-site, except in a designated area where wash water is contained and treated.
- · Limit and time applications of pesticides and fertilizers to prevent polluted runoff.
- · Limit construction access routes to stabilized, designated access points
- · Avoid tracking dirt or other materials off-site; clean off-site paved areas and sidewalks using dry sweeping methods.
- · Train and provide instruction to all employees and subcontractors regarding the Watershed Protection Maintenance Standards and construction Best Management Practices.
- · Placement of erosion materials is required on weekends and during rain events.
- The areas delineated onh the plans for parking, grubbing, storage etc., shall not be enlarged or "run over."
- · Dust control is required year-round.

−FIBER ROLE, ~12" DIAMETER

—EMBED 2−3"

18" MIN.

- · Erosion control materials shall be stored on-site
- · Use of plastic sheeting between October 1st and April 30th is not acceptable, unless for use on stockpiles where the stockpile is also protected with fiber rolls containing the base of the stockpile.
- The tree protection shall be in place before any grading, excavating or grubbing is started.

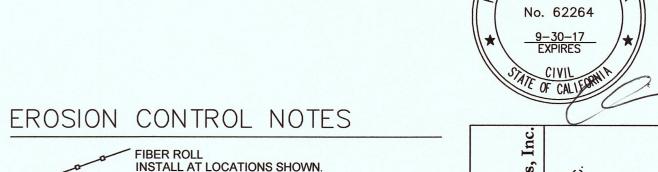

1. GRADING MAY TAKE PLACE DURING WET WEATHER AFTER OCTOBER 1 PROVIDED THE FOLLOWING PROVISIONS ARE FOLLOWED. 2. NO GRADING SHALL TAKE PLACE DURING RAINY WEATHER OR FOR A PERIOD OF AT LEAST 24 HOURS FOLLOWING RAIN.

AFIX AS SHOWN IN DETAIL 3.

3. ALL EXPOSED SOIL SHALL BE TEMPORARILY PROTECTED FROM EROSION WITH JUTE 4. ALL STOCKPILED SOIL SHALL BE COVERED AT ALL TIMES AND REMOVED FROM SITE AS SOON AS POSSIBLE, IF SCHEDULED FOR OFF-HAUL. 5. ALL EXPOSED SURFACES SHALL BE PERMANENTLY PROTECTED FROM EROSION WITH SEEDING AND/OR LANDSCAPING. SEED MIX SHALL BE 75 LB PER ACRE ANNUAL RYGRASS OR APPROVED SUBSTITUTE. SEED SHALL BE COVERED WITH STRAW MULCH


AT A RATE OF 2 TONS/ACRE. 6. ROCKED CONSTRUCTION ENTRANCE SHALL BE 50 FEET LONG BY 13 FEET WIDE AND CONFORM TO THE FOLLOWING: A. THE MATERIAL FOR THE PAD SHALL BE 2 TO 3 INCH STONE. B. PAD SHALL BE NOT LESS THAN 8" THICK.

C. THE ENTRANCE SHALL BE MAINTAINED IN A CONDITION THAT WILL PREVENT TRACKING OR FLOWING OF SEDIMENT ONTO PUBLIC RIGHT-OF-WAY. THIS MAY REQUIRE PERIODIC TOP DRESSING WITH ADDITIONAL STONE AS CONDITIONS DEMAND, AND REPAIR AND/OR CLEANOUT OF ANY MEASURES USED TO TRAP SEDIMENT. ALL SEDIMENT SPILLED, DROPPED, WASHED, OR TRACKED ONTO PUBLIC RIGHT-OF-WAY SHALL BE REMOVED IMMEDIATELY. D. WHEN NECESSARY, WHEELS SHALL BE CLEANED TO REMOVE SEDIMENT PRIOR TO

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EROSION CONTROL POINT OF CONTACT THIS PERSON WILL BE RESPONSIBLE FOR EROSION CONTROL AT THE SITE AND WILL BE THE COUNTY'S MAIN POINT OF CONTACT IF CORRECTIONS ARE REQUIRED. NAME: SUSAN CARKEEK TITLE/QUALIFICATION: OWNER flyonthewall@coastside.net USE OF PLASTIC SHEETING BETWEEN OCTOBER 1st AND APRIL 30th IS NOT ACCEPTABLE,
 UNLESS FOR USE ON STOCKPILES WHERE THE STOCKPILE IS ALSO PROTECTED WITH
 FIBER ROLLS CONTAINING THE BASE OF THE STOCKPILE.

SHEET

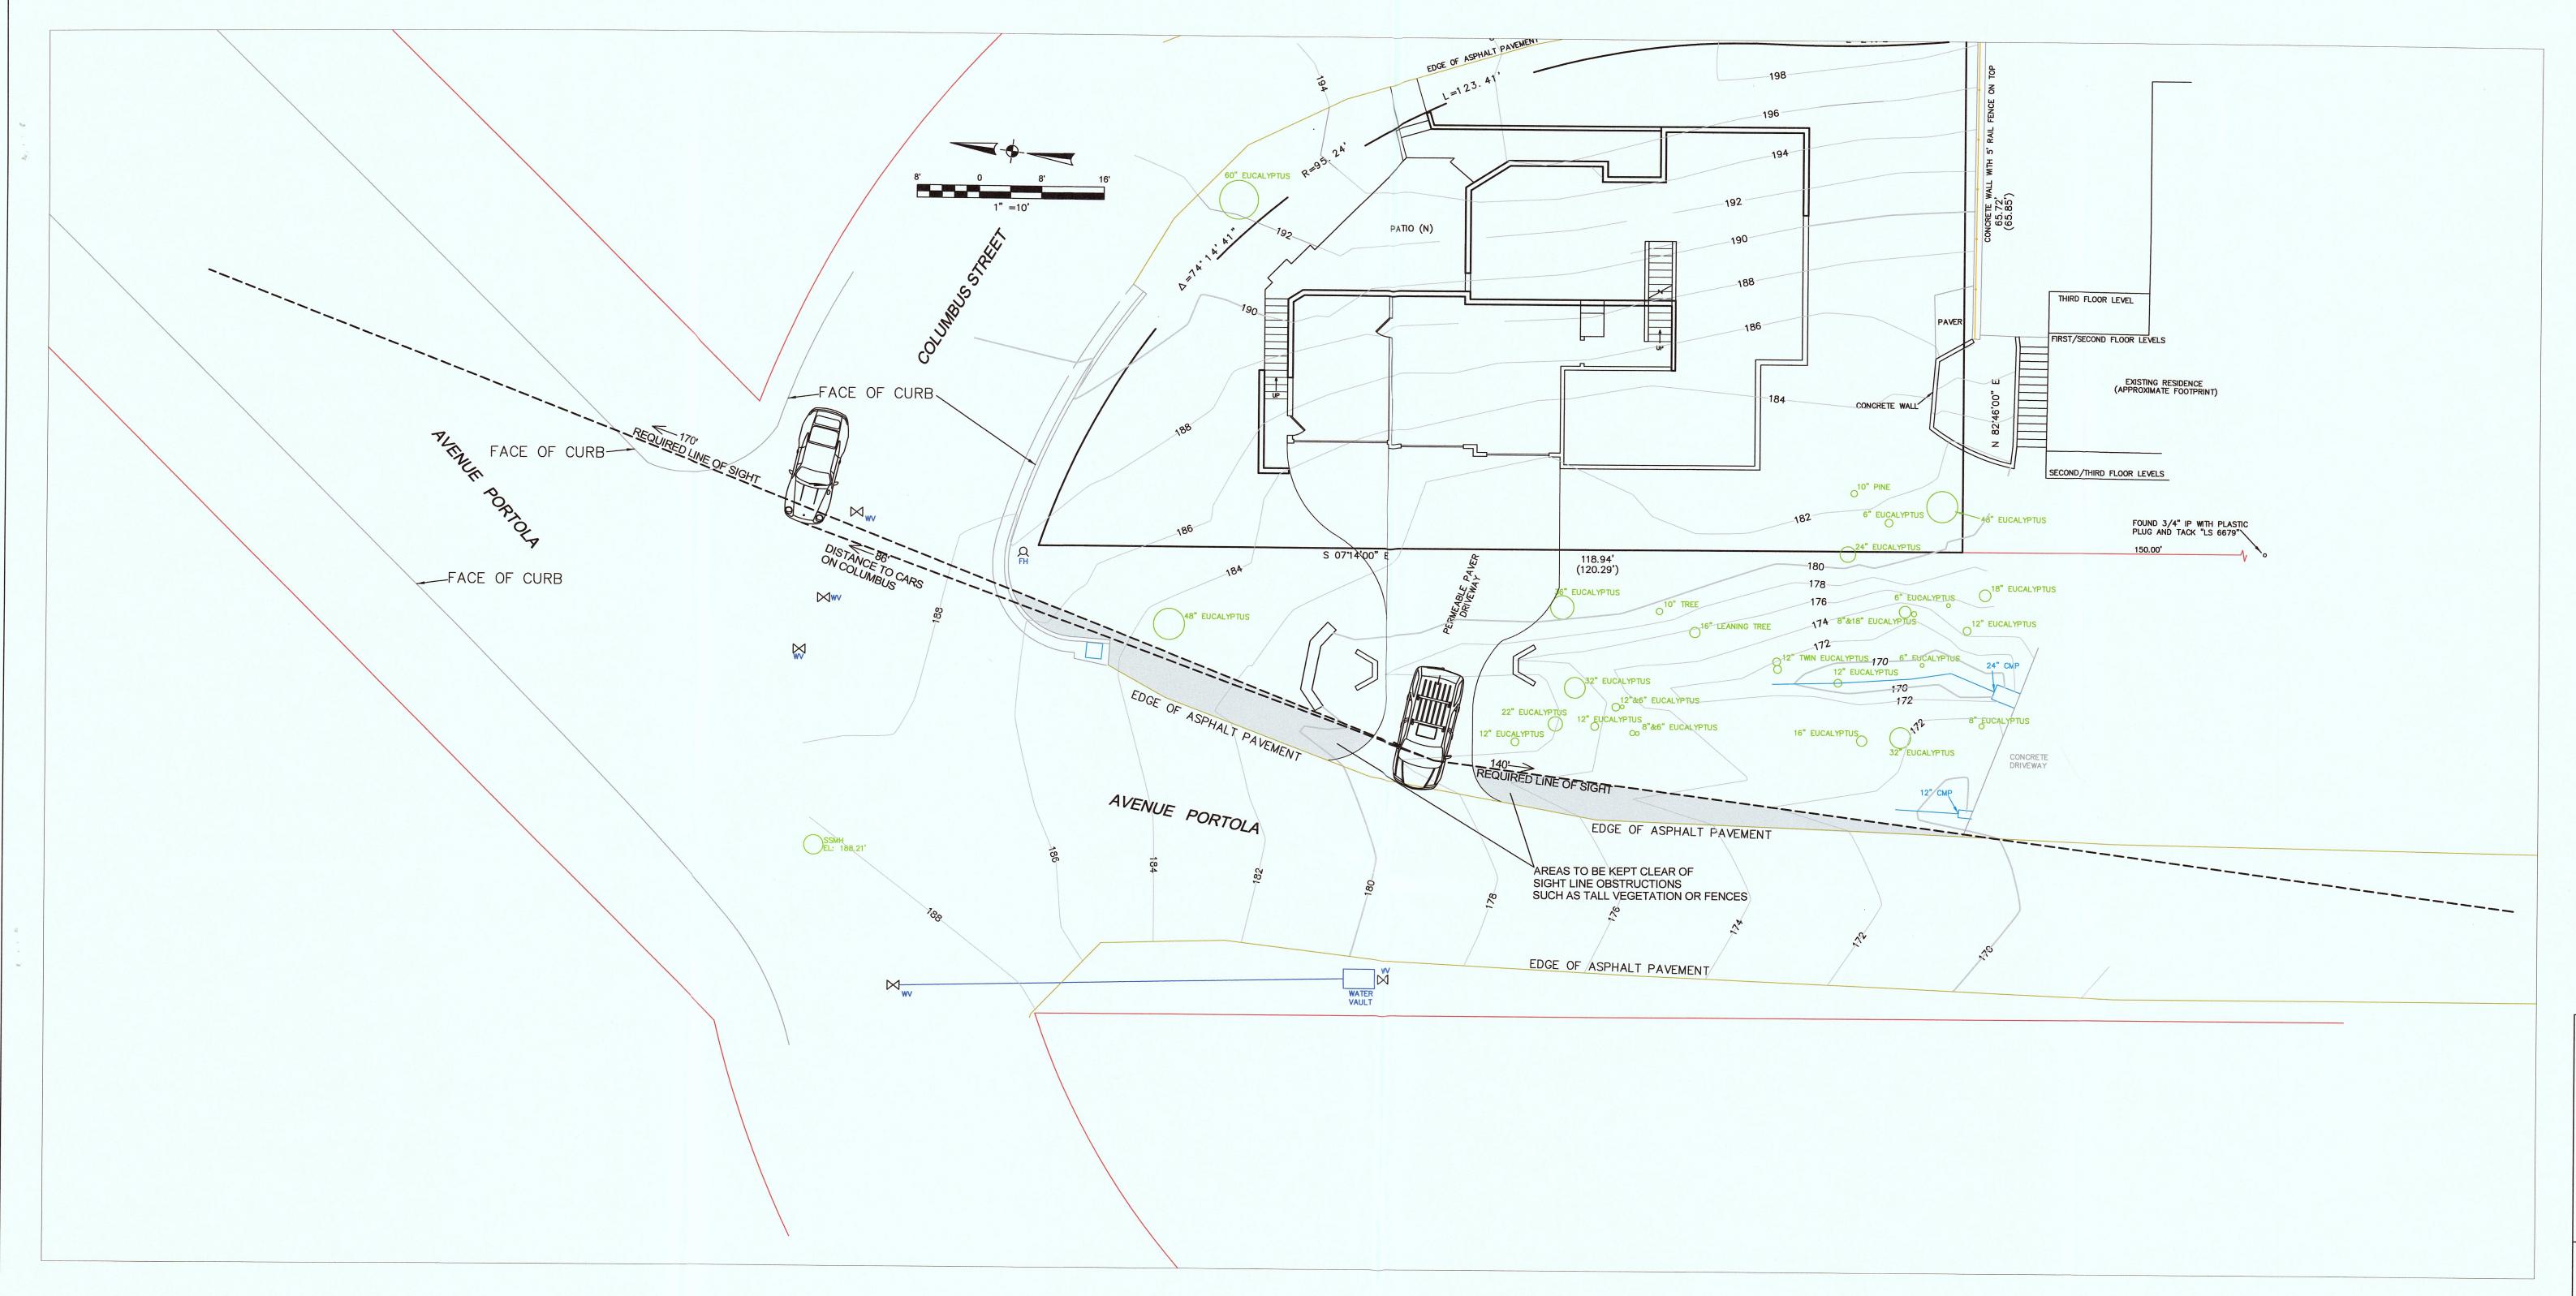

NOTES

- 1. SHADED AREAS SHALL BE KEPT CLEAR OF ANY VEGETATION OR STRUCTURES THAT WOULD BLOCK SIGHT LINES.
- 2. SIGHT LINES SHOWN ARE THE MINIMUM REQUIRED FOR THE SITE CONDITIONS. ACTUAL SIGHT LINES ARE LONGER THAN THE MINIMUM.
- 3. SIGHT LINE TO INTERSECTION OF COLUMBUS STREET IS SUFFICIENT. CARS TURNING ONTO PORTOLA NEED TO STOP TO CHECK FOR TRAFFIC, OR SLOW TO SAFELY NEGOTIATE SHARP LEFT TURN.



Sigma Prime Geosciences, Inc.

ZG SIGMA PRIME GEOSCIENCES, INC.

332 PRINCETON AVENUE

HALF MOON BAY, CA 94019

(650) 728-3590

FAX 728-3593

DATE: 3-23-16

DRAWN BY: CMK

CHECKED BY: AZG

SIGM

SIGHT LINES
CARKEEK PROPERTY

SHEET

C-3